

GENERAL NOTES

ALL CONSTRUCTION SHALL BE IN ACCORDANCE WITH THE REQUIREMENTS SET FORTH BY IBC 2018 EDITION AND SHALL CONFORM TO ALL OTHER APPLICABLE MUNICIPAL, STATE, AND FEDERAL REGULATIONS INCLUDING THE ILLINOIS ACCESSIBILITY CODE (2018) AND THE AMERICANS WITH DISABILITIES ACT.

A. GENERAL NOTES
1. ALL CONTRACTORS ARE REQUIRED TO VISIT THE SITE AND BE KNOWLEDGEABLE REGARDING EXISTING CONDITIONS AND THEIR EFFECT ON THE PROPOSED WORK.

B. MISCELLANEOUS AND DEMOLITION NOTES
1. COORDINATE PENETRATIONS AND/OR SLEEVES REQUIRED IN WALLS, FLOORS, CEILINGS OR ROOFS FOR MECHANICAL AND ELECTRICAL WORK REQUIRED BY ARCHITECTURAL, MECHANICAL, ELECTRICAL, AND PLUMBING DRAWINGS.

Table with 2 columns: Detail Number/Drawing Number and Symbol. Includes details for 8, 23, 2, 1, 26, 26, 1/1ST FLR, 204, 203.2, 203.1X, MBS, 7.531, X, and A.

DRAFTING SYMBOLS AND MATERIALS LEGEND

Table with 2 columns: Symbol and Description. Includes symbols for concrete, brick masonry, stone masonry, raked joint, brick masonry section detail, concrete masonry section detail, stone masonry section detail, steel in section detail, discontinuous rough wood blocking, continuous rough wood framing, finished wood in section detail, rigid board insulation, rigid board insulation (roofing), batt insulation, gypsum board, acoustical ceiling panel, bituminous concrete paving, aggregate ballast fill, undisturbed earth, and earth backfill.

STANDARD ABBREVIATIONS

Large table with 4 columns of abbreviations and their corresponding full names. Includes terms like ANCHOR BOLT, ACQUISITIVE CEILING PANEL, ACQUISITIVE CEILING TILE, etc.

THE MATERIALS, ABBREVIATIONS, AND DRAFTING SYMBOLS LEGEND ARE EACH AN ALL INCLUSIVE MASTER LIST USED BY THIS FIRM. THE INCLUSION OF THESE LEGENDS INTO THESE DOCUMENTS DOES NOT IMPLY THAT ALL THE SYMBOLS OR MATERIALS INCLUDED IN THESE LEGENDS ARE INCORPORATED INTO THIS PROJECT.

PROJECT

KEN PICKERILL HOUSE RENOVATIONS
6350 MINKLER ROAD
YORKVILLE, IL 60560

OWNER

KENDALL COUNTY FOREST PRESERVE DISTRICT
110 W. MADISON STREET
YORKVILLE, IL 60560

ARCHITECT/ENGINEER

KLUBER ARCHITECTS + ENGINEERS
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OWNER FINAL REVIEW

REQUIRED CODE COMPLIANCE INFORMATION


REQUIRED PLAN COVER SHEET INFORMATION FOR REVIEW UNDER 2018 INTERNATIONAL CODES, STATE OF ILLINOIS ACCESSIBILITY CODE, AND THE STATE OF ILLINOIS PLUMBING CODE. GENERAL STATEMENT OF OVERALL PROJECT SCOPE AND INTENT: PROJECT CONSISTS OF INTERIOR ALTERATIONS AND REMODELING TO AN EXISTING MULTI-STORY RESIDENTIAL BUILDING...

SEALS & CERTIFICATIONS

Professional seals for Architect (Christopher J. Hansen), Structural Engineer (Jeffrey M. Brunus), Mechanical Engineer (Donald D. Ware, Jr.), and Electrical Engineer (Michael T. Kluber). Includes expiration dates and signatures.

INDEX OF DRAWINGS

Table listing drawing titles and sheet numbers. Includes sections for GENERAL, ARCHITECTURAL, STRUCTURAL, MECHANICAL, PLUMBING, and ELECTRICAL.

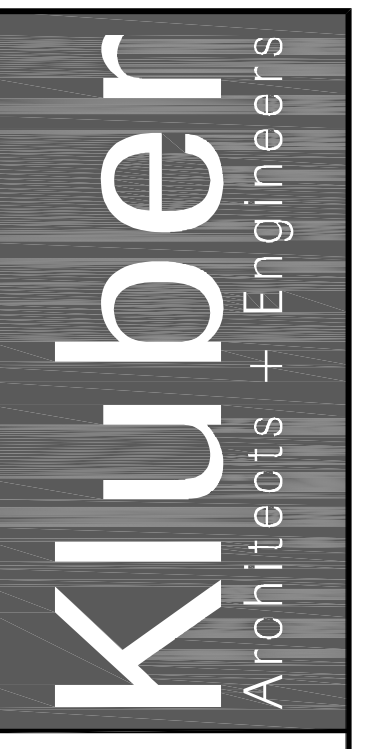

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Table with 2 columns: Description and Date. Includes entries for ISSUED, 01/06/22, and 01/06/22 BID DOCUMENTS.

Table with 2 columns: Field and Value. Includes JOB NO. 19-429-1250, DRAWN PJT, CHECKED CJH, APPROVED CJH, SHEET TITLE COVER SHEET, GENERAL NOTES, SYMBOLS AND DRAWING INDEX, and SHEET NUMBER G100.

ISSUED
01/09/22 - BID DOCUMENTS














JOB NO.	19-429-1250
DRAWN	PJT
CHECKED	CJH
APPROVED	CJH

SHEET TITLE

ACCESSIBILITY REQUIREMENTS

SHEET NUMBER

G201

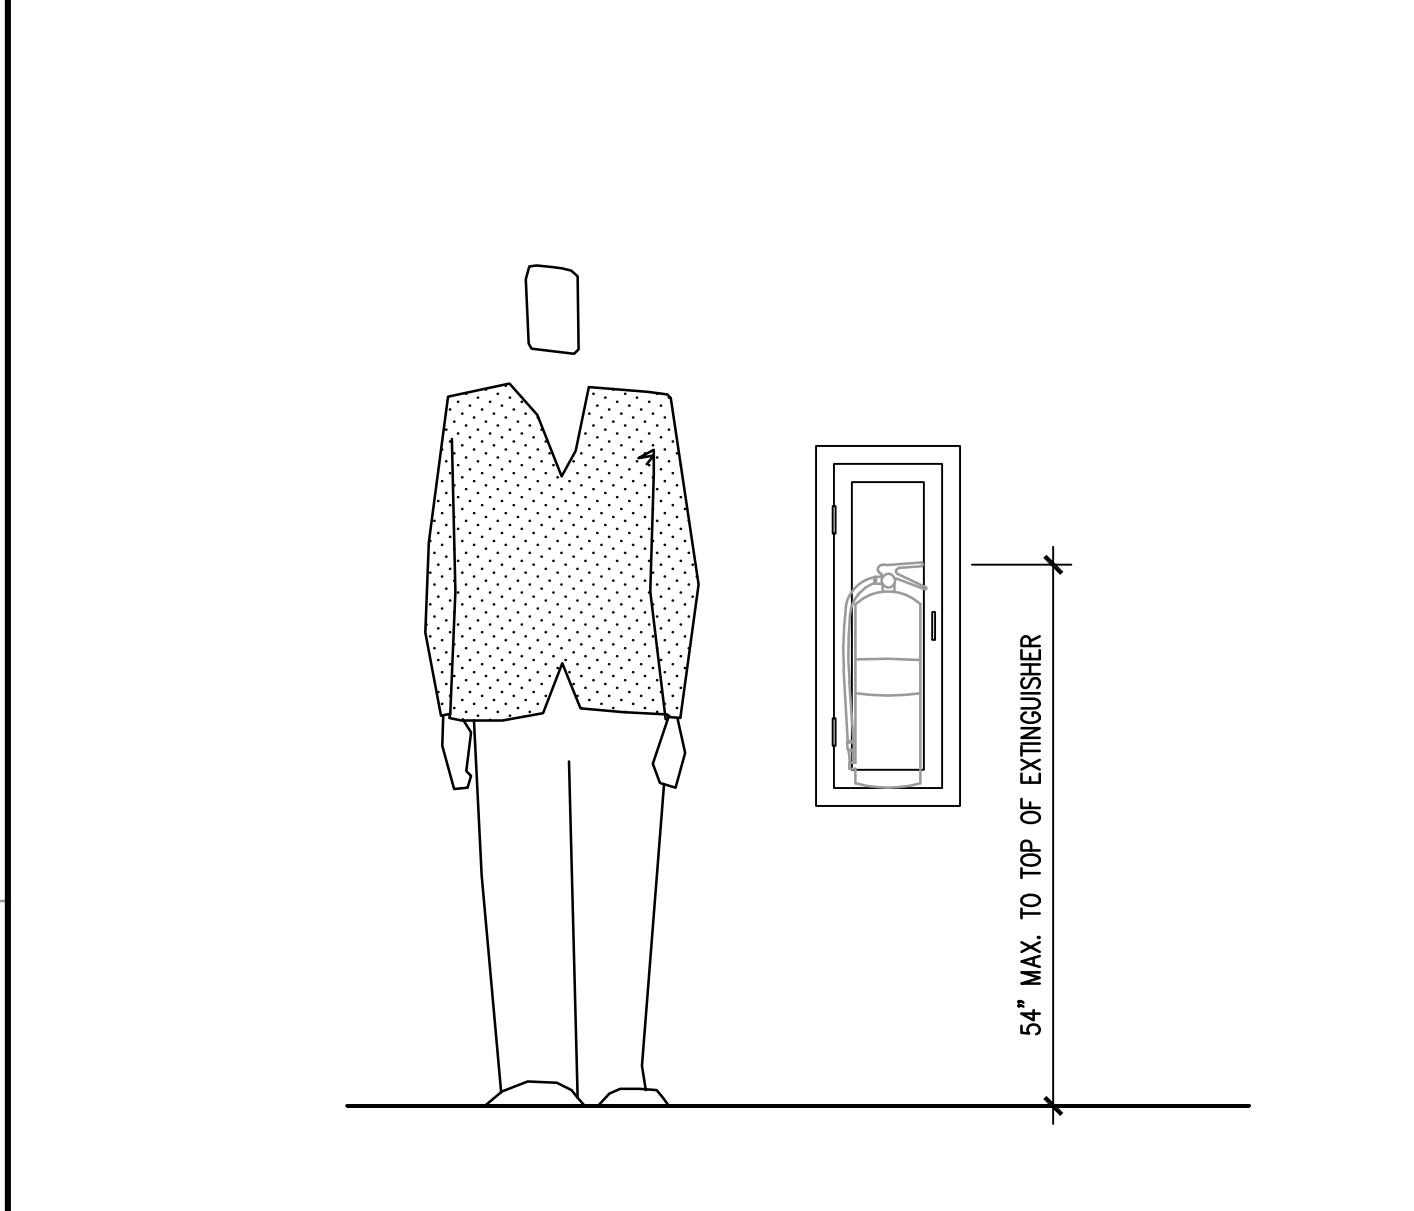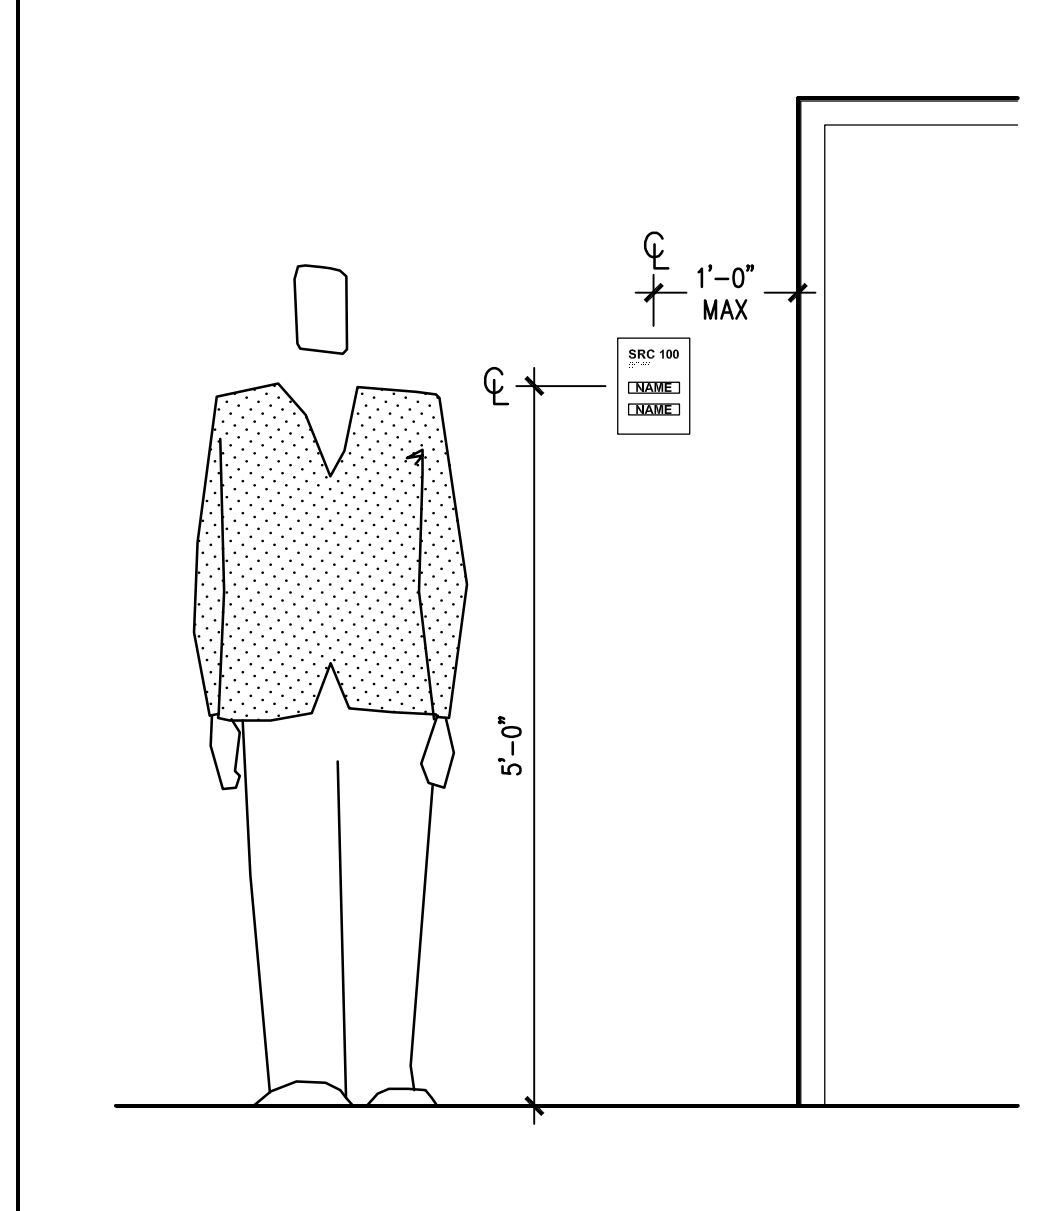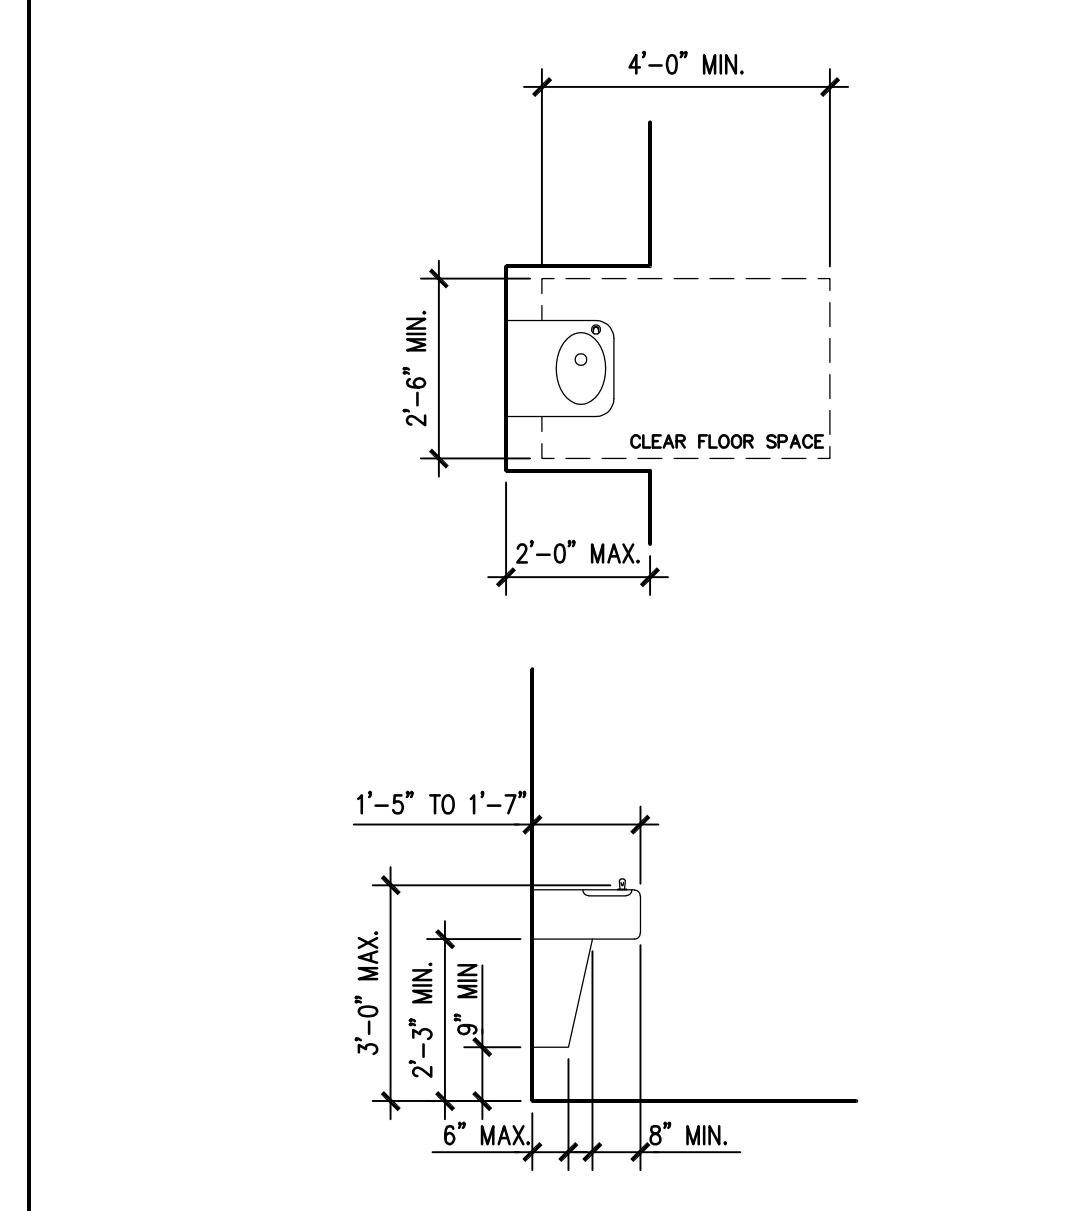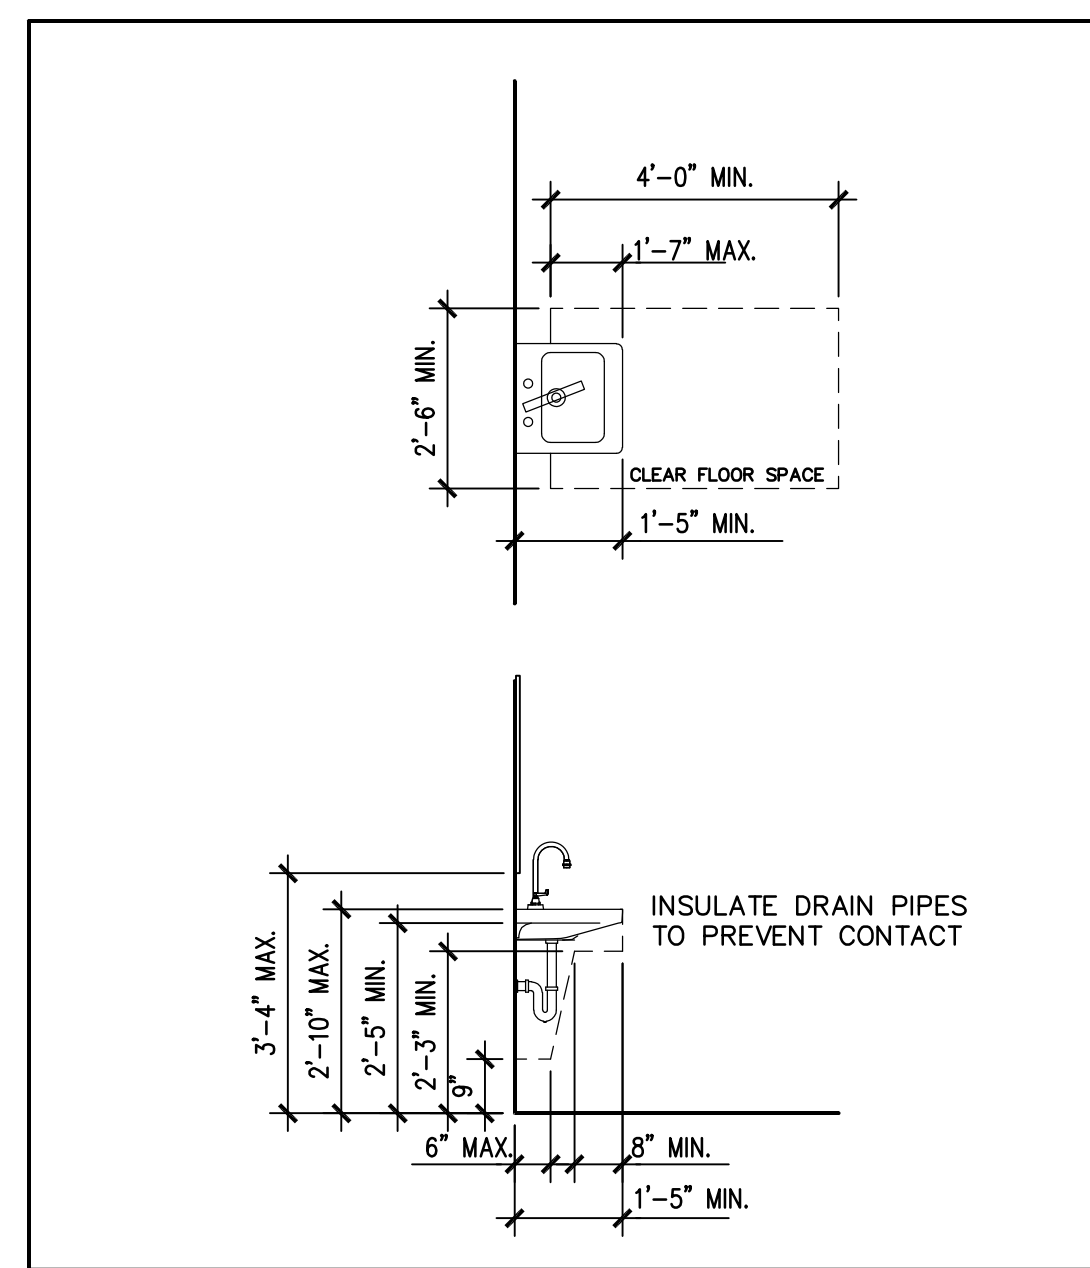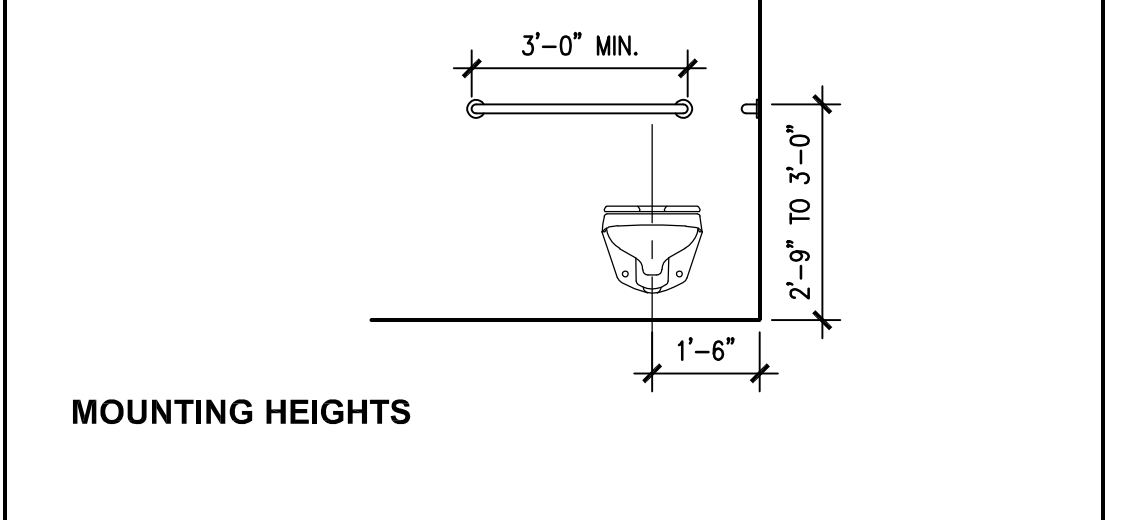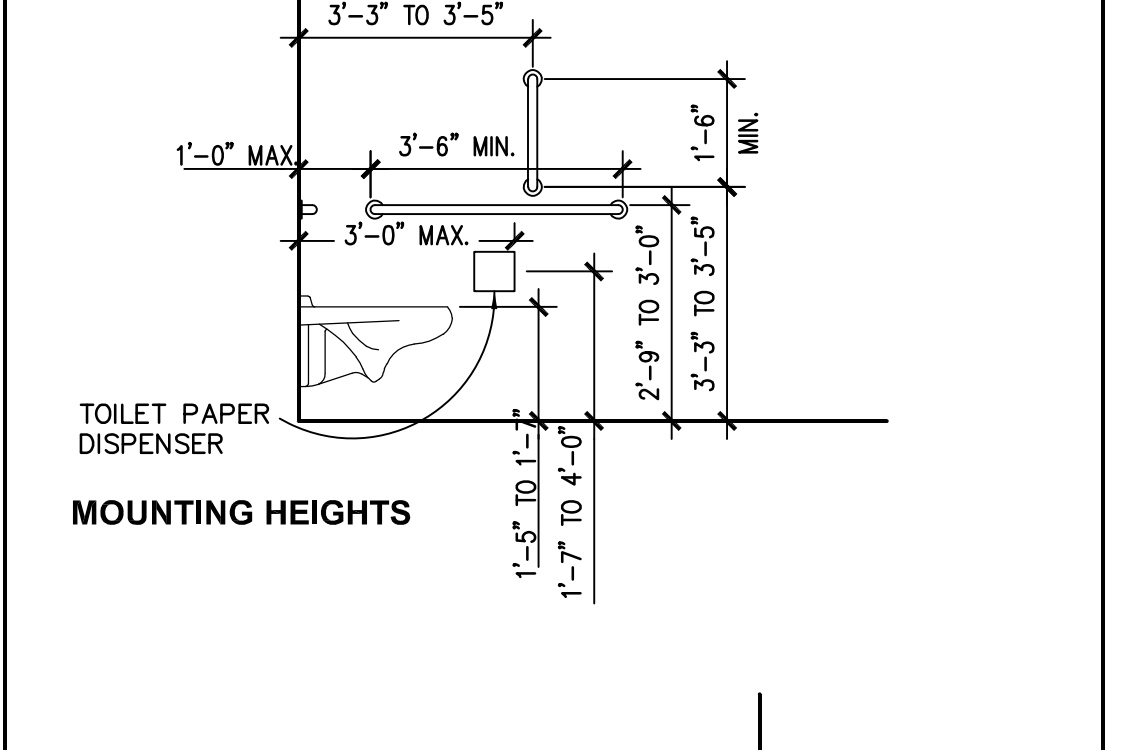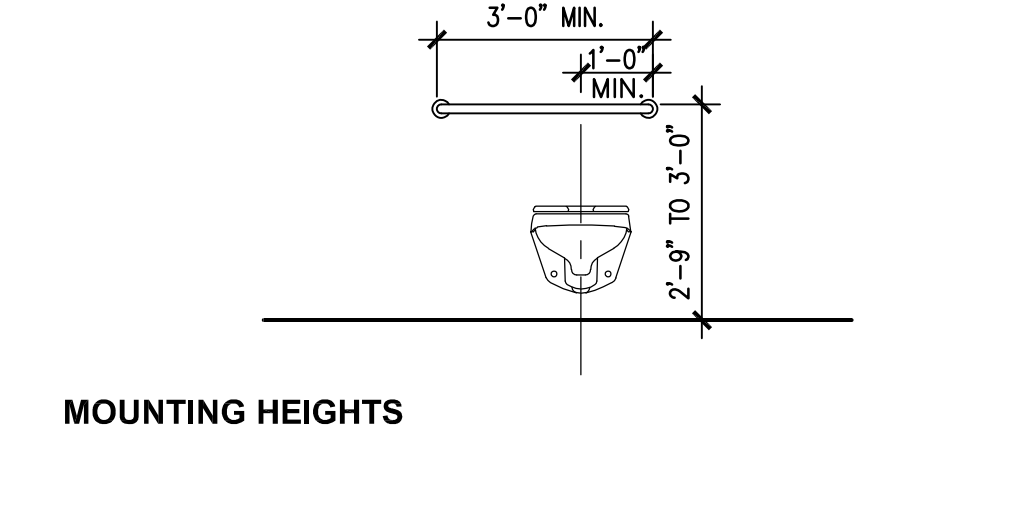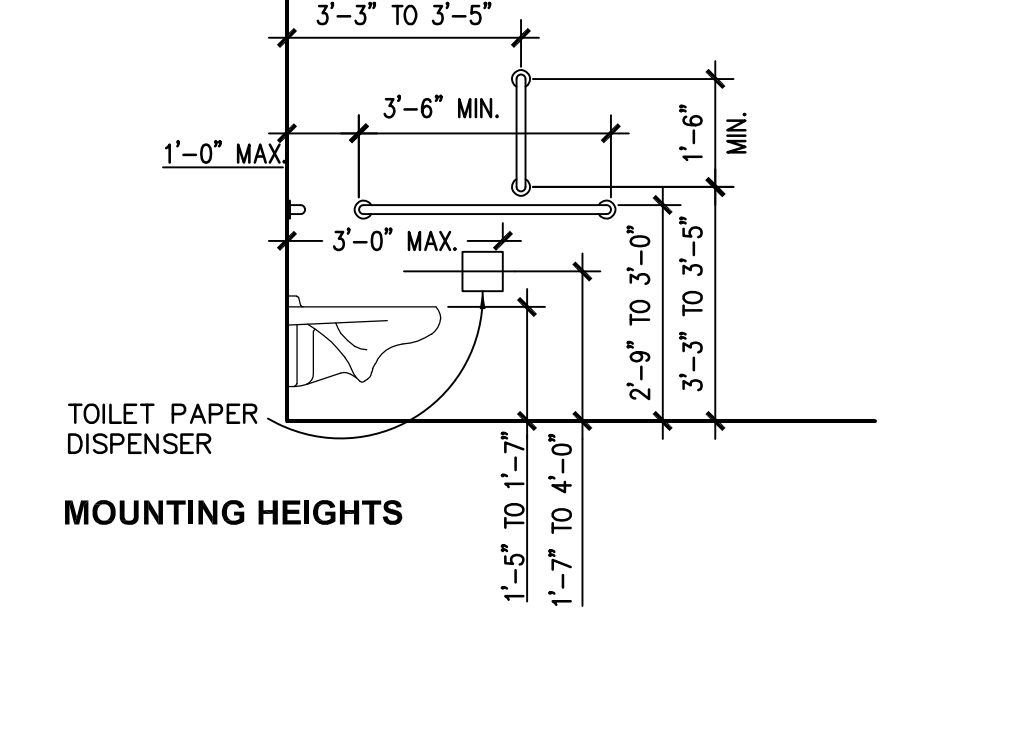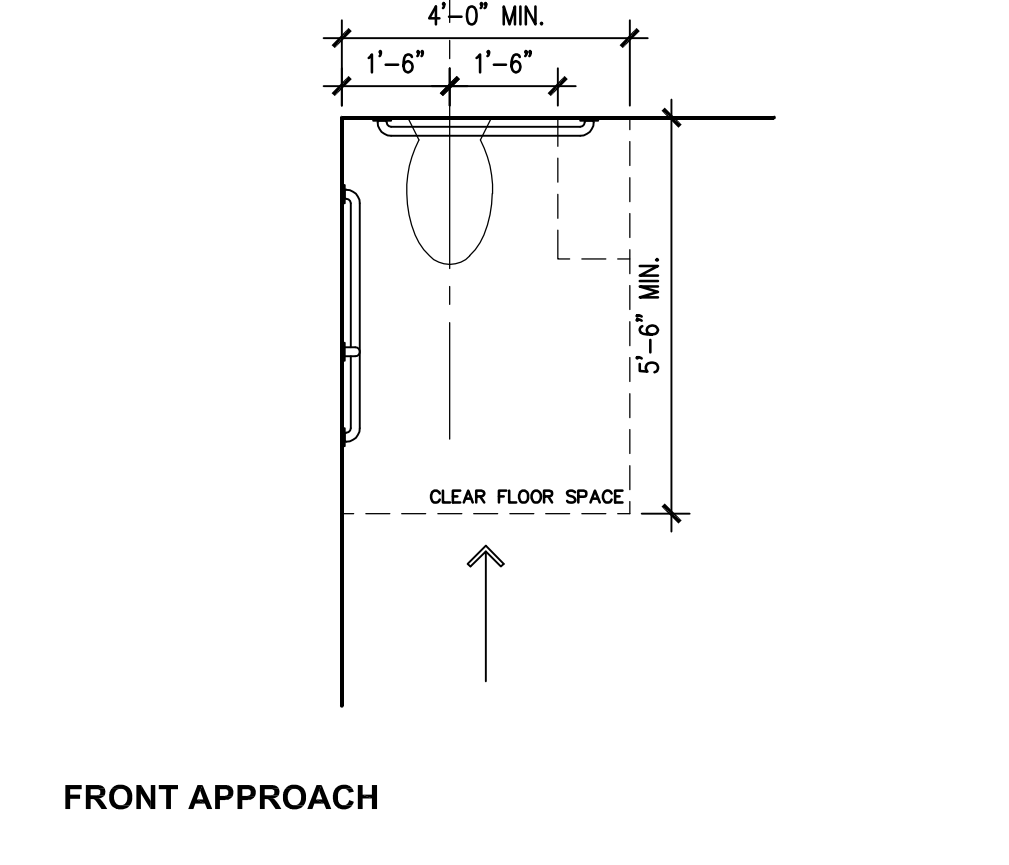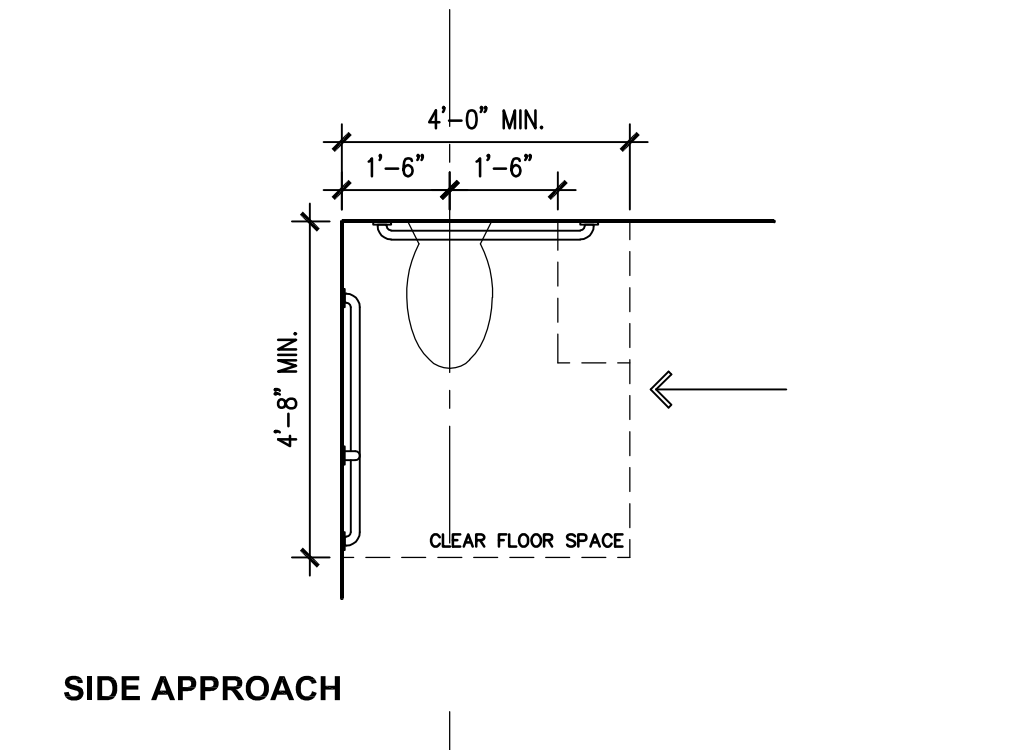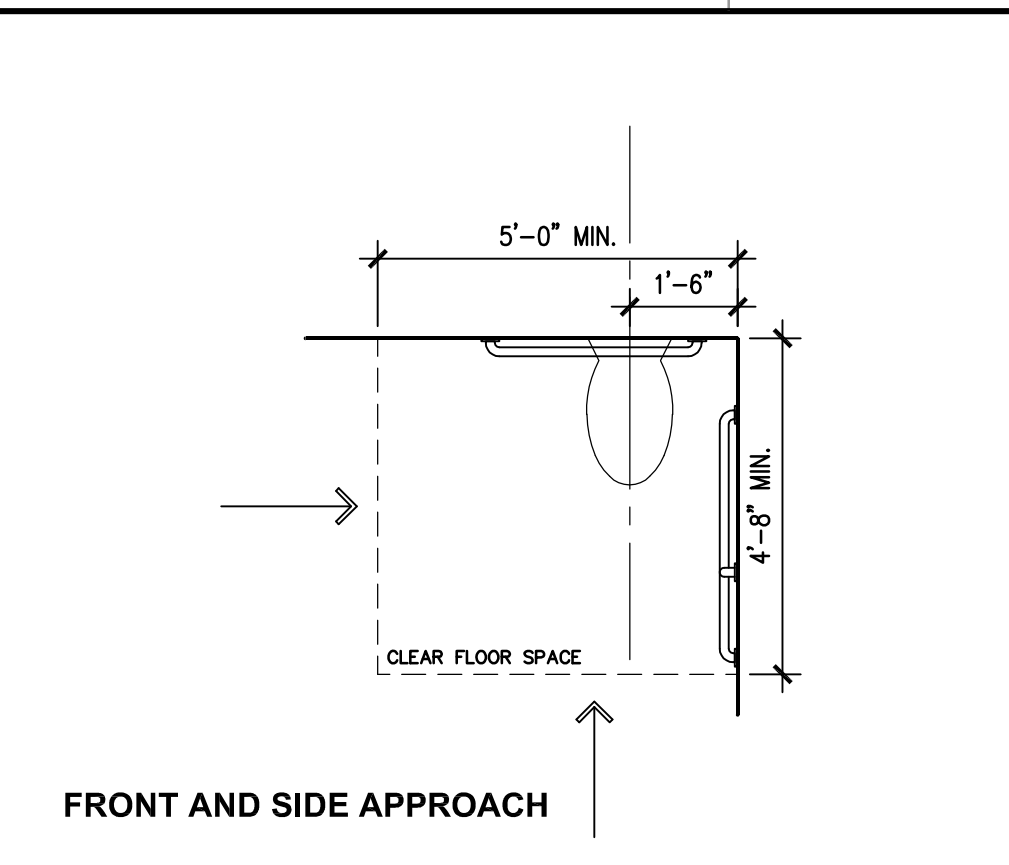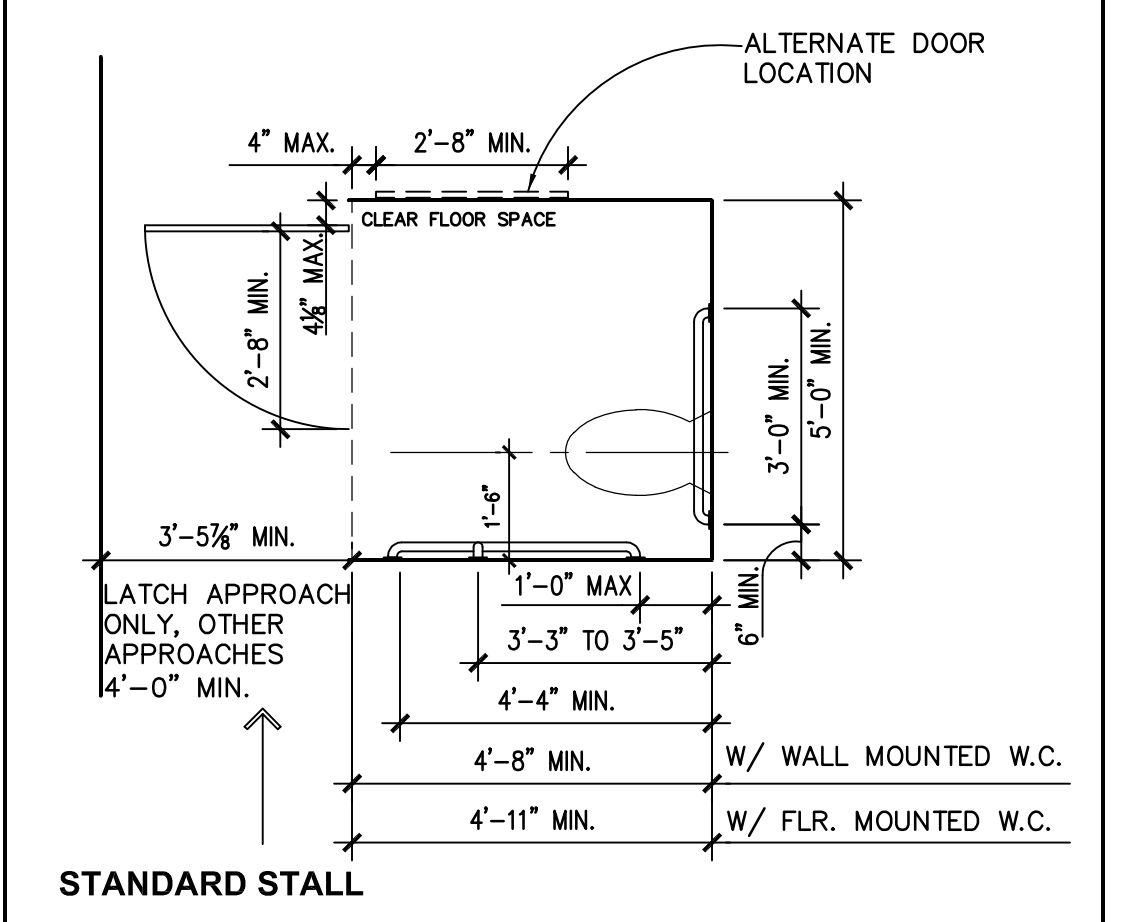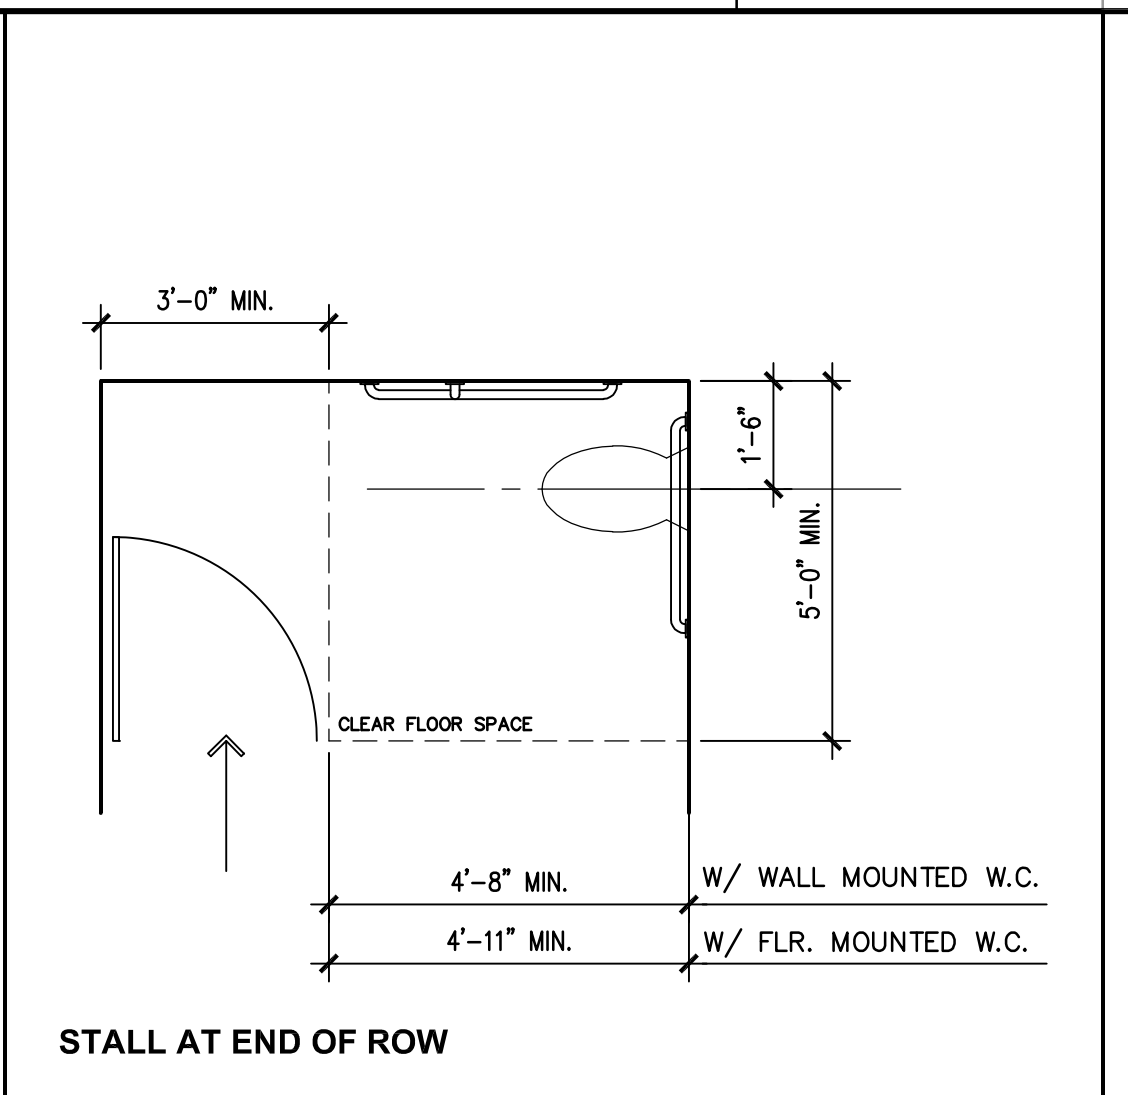

GENERAL NOTES


MULTI-USER TOILET ROOM
N.T.S. 3

SINGLE-USER TOILET ROOM
N.T.S. 4

DRINKING FOUNTAIN
N.T.S. 5

INTERIOR SIGNAGE
N.T.S. 8

FIRE EXT. CABINETS
N.T.S. 11

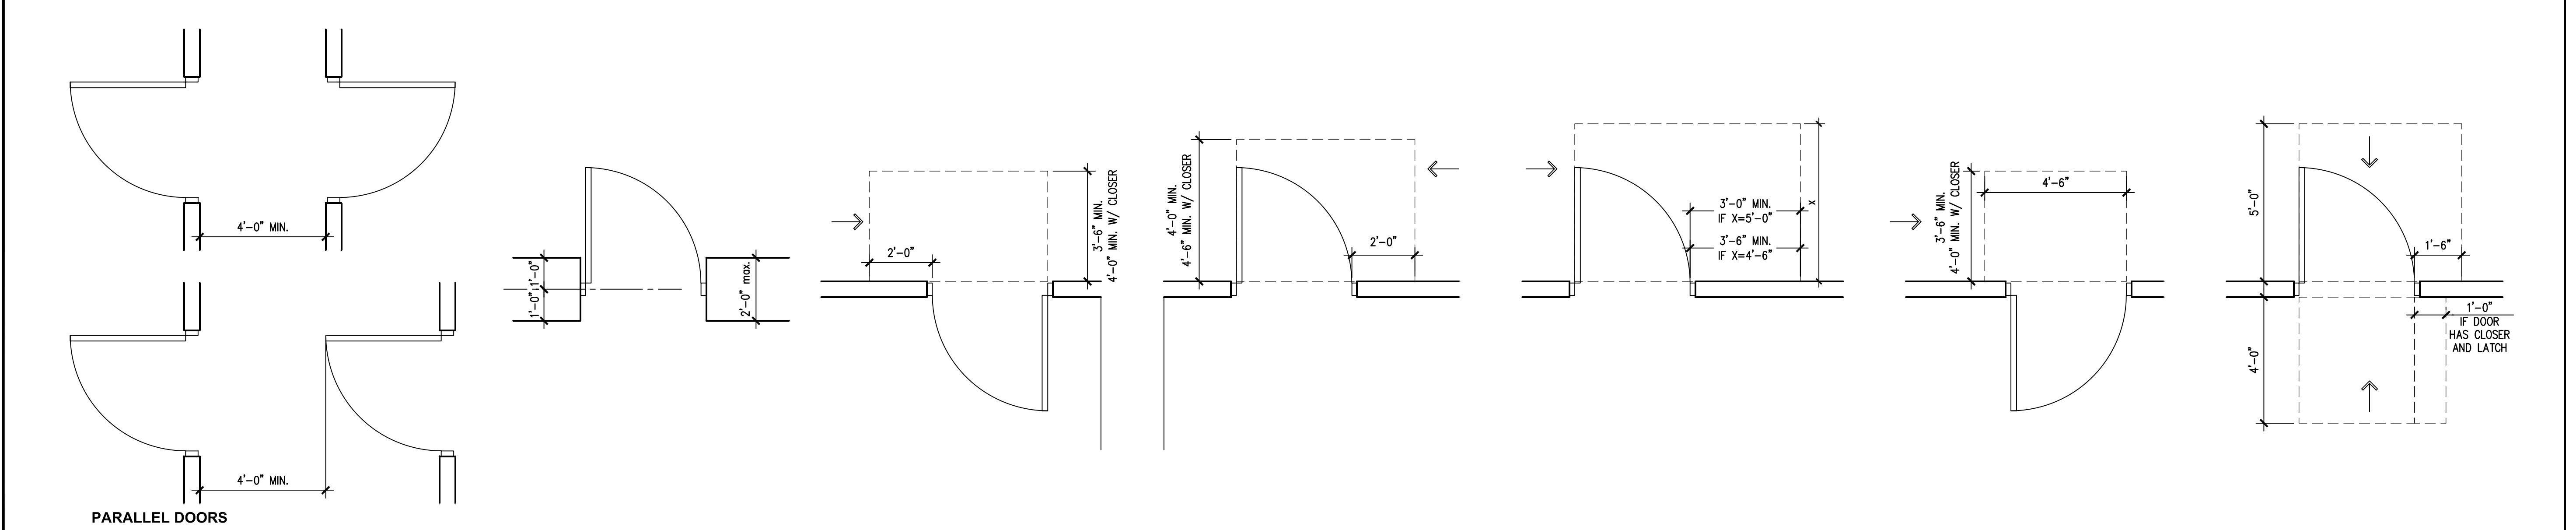

GENERAL NOTES

- REFER TO DRAWING G100 FOR PROJECT GENERAL NOTES.
- REFER TO SPECIFICATIONS FOR SCHEDULES OF FIREPROOFING OF STRUCTURAL MEMBERS AND ASSEMBLIES.
- FIRE SEPARATION ASSEMBLIES ARE DEPICTED IN PLAN ON THIS DRAWING.
- PENETRATIONS INTO AND THROUGH EXIT STAIR ENCLOSURES ARE PROHIBITED EXCEPT FOR REQUIRED EXIT DOORS, AND FOR DUCTS, PIPING AND CONDUITS THAT TERMINATE IN, AND ARE NECESSARY FOR SERVING, THE STAIR ENCLOSURES.
- COORDINATE AND PERFORM THE WORK OF ALL CONTRACTS IN ACCORDANCE WITH THE INFORMATION CONTAINED IN THIS DRAWING.

BUILDING CODE DATA

APPLICABLE BUILDING CODE:	2018 International Building Code 2018 International Mechanical Code 2018 International Fuel Gas Code 2018 International Existing Building Code 2018 International Fire Code 2017 National Electrical Code Illinois Plumbing Code (Current Edition) Illinois Energy Conservation Code (Current Edition) Illinois Accessibility Code (Current Edition) local amendments to the above codes
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GENERAL BUILDING LIMITATIONS

USE GROUP (IBC 2018 Chapter 3):	USE GROUP: A-3 PER 304.0												
TYPE OF CONSTRUCTION (IBC 2018 Chapter 6):	V-B												
ACTUAL BUILDING AREA:	BASEMENT FLOOR 2,103 S.F. 1ST FLOOR 4,565 S.F. 2ND FLOOR 3,192 S.F. TOTAL 9,860 S.F.												
FULLY SPRINKLERED:	NO												
OPEN PERIMETER:	N/A												
GENERAL BUILDING LIMITATIONS (IBC 2018 Chapter 5):	A-3 USE												
HEIGHT CALCULATIONS (Sections 504.0 and Table 504)	ALLOWABLE HEIGHT: (TABLE 504 VALUE + 24 FT/2 ST) 64 FT / 2 STORIES ACTUAL HEIGHT: 24 FT / 2 STORIES												
AREA CALCULATIONS (Sections 503 and 506)	<table border="1"> <tr> <th></th> <th>BASEMENT</th> <th>FIRST FLOOR</th> <th>SECOND FLOOR</th> </tr> <tr> <td>ACTUAL AREA:</td> <td>2,103 SF</td> <td>4,565 SF</td> <td>3,192 SF</td> </tr> <tr> <td>ALLOWABLE AREA: (TABLE 503 VALUE x xxx%)</td> <td>6,000 SF</td> <td>6,000 SF</td> <td>6,000 SF</td> </tr> </table>		BASEMENT	FIRST FLOOR	SECOND FLOOR	ACTUAL AREA:	2,103 SF	4,565 SF	3,192 SF	ALLOWABLE AREA: (TABLE 503 VALUE x xxx%)	6,000 SF	6,000 SF	6,000 SF
	BASEMENT	FIRST FLOOR	SECOND FLOOR										
ACTUAL AREA:	2,103 SF	4,565 SF	3,192 SF										
ALLOWABLE AREA: (TABLE 503 VALUE x xxx%)	6,000 SF	6,000 SF	6,000 SF										

NOTES:

RATINGS OF BUILDING ELEMENTS

	CONSTRUCTION TYPE V-B		
STRUCTURAL FRAME	0 HOUR		
BEARING WALL EXTERIOR	0 HOUR		
BEARING WALL INTERIOR	1 HOUR		
FLOOR CONSTRUCTION	0 HOUR		
ROOF CONSTRUCTION	0 HOUR		
STAIRS AND SHAFTS	0 HOUR		

LEGEND

SMOKE PARTITION
 1-HR RATED FIRE SEPARATION ASSEMBLY OR EXTERIOR WALL
 1-HR RATED FIRE SEPARATION @ FLOOR ASSEMBLY ABOVE

SPACE EGRESS INFORMATION:

C119 ROOM NUMBER
MECHANICAL OCCUPANCY TYPE
602 GSF ROOM SIZE (IN NET OR GROSS SQUARE FEET)
300 2 TOTAL NUMBER OF OCCUPANTS
300 2 NET GROSS S.F. PER OCCUPANT

EXIT ACCESS / EXIT STAIR INFORMATION:

8101 SPACE NUMBER (IF ANY)
CORRIDOR EXIT ACCESS COMPONENT TYPE
52" CLEAR OPENING WIDTH (INCHES)

EXIT EGRESS INFORMATION:

33'1165 CLEAR OPENING WIDTH (INCHES)
100 EGRESS CAPACITY (PEOPLE)
100 ANTICIPATED EGRESS LOAD (PEOPLE)


DIRECTION OF EGRESS TRAVEL
 TRAVEL ROUTE AND DISTANCE FROM MOST REMOTE POINT (FEET)
 FIRE EXTINGUISHER LOCATION

EXIT CALCULATIONS

MEANS OF EGRESS COMPARTMENT	OCCUPANT LOAD	NUMBER OF EXITS		MIN. WIDTH OF EXIT STAIRS		MIN. CLR. WID. OF EXIT DOORWAYS		TOTAL EXIT WIDTH		REMARKS
		REQD.	ACTUAL	REQD.	ACTUAL	REQD.	ACTUAL	REQD.	ACTUAL	
FIRST FLOOR 1.1	126	2	3	N/A	N/A	32"	33"	64"	99"	

EXIT CALCULATION REMARKS

- OCCUPANTS EXITING DIRECTLY TO THE OUTSIDE FROM A ROOM ARE NOT COUNTED IN DETERMINING THE TOTAL OCCUPANT LOAD OF THE EGRESS COMPARTMENT.

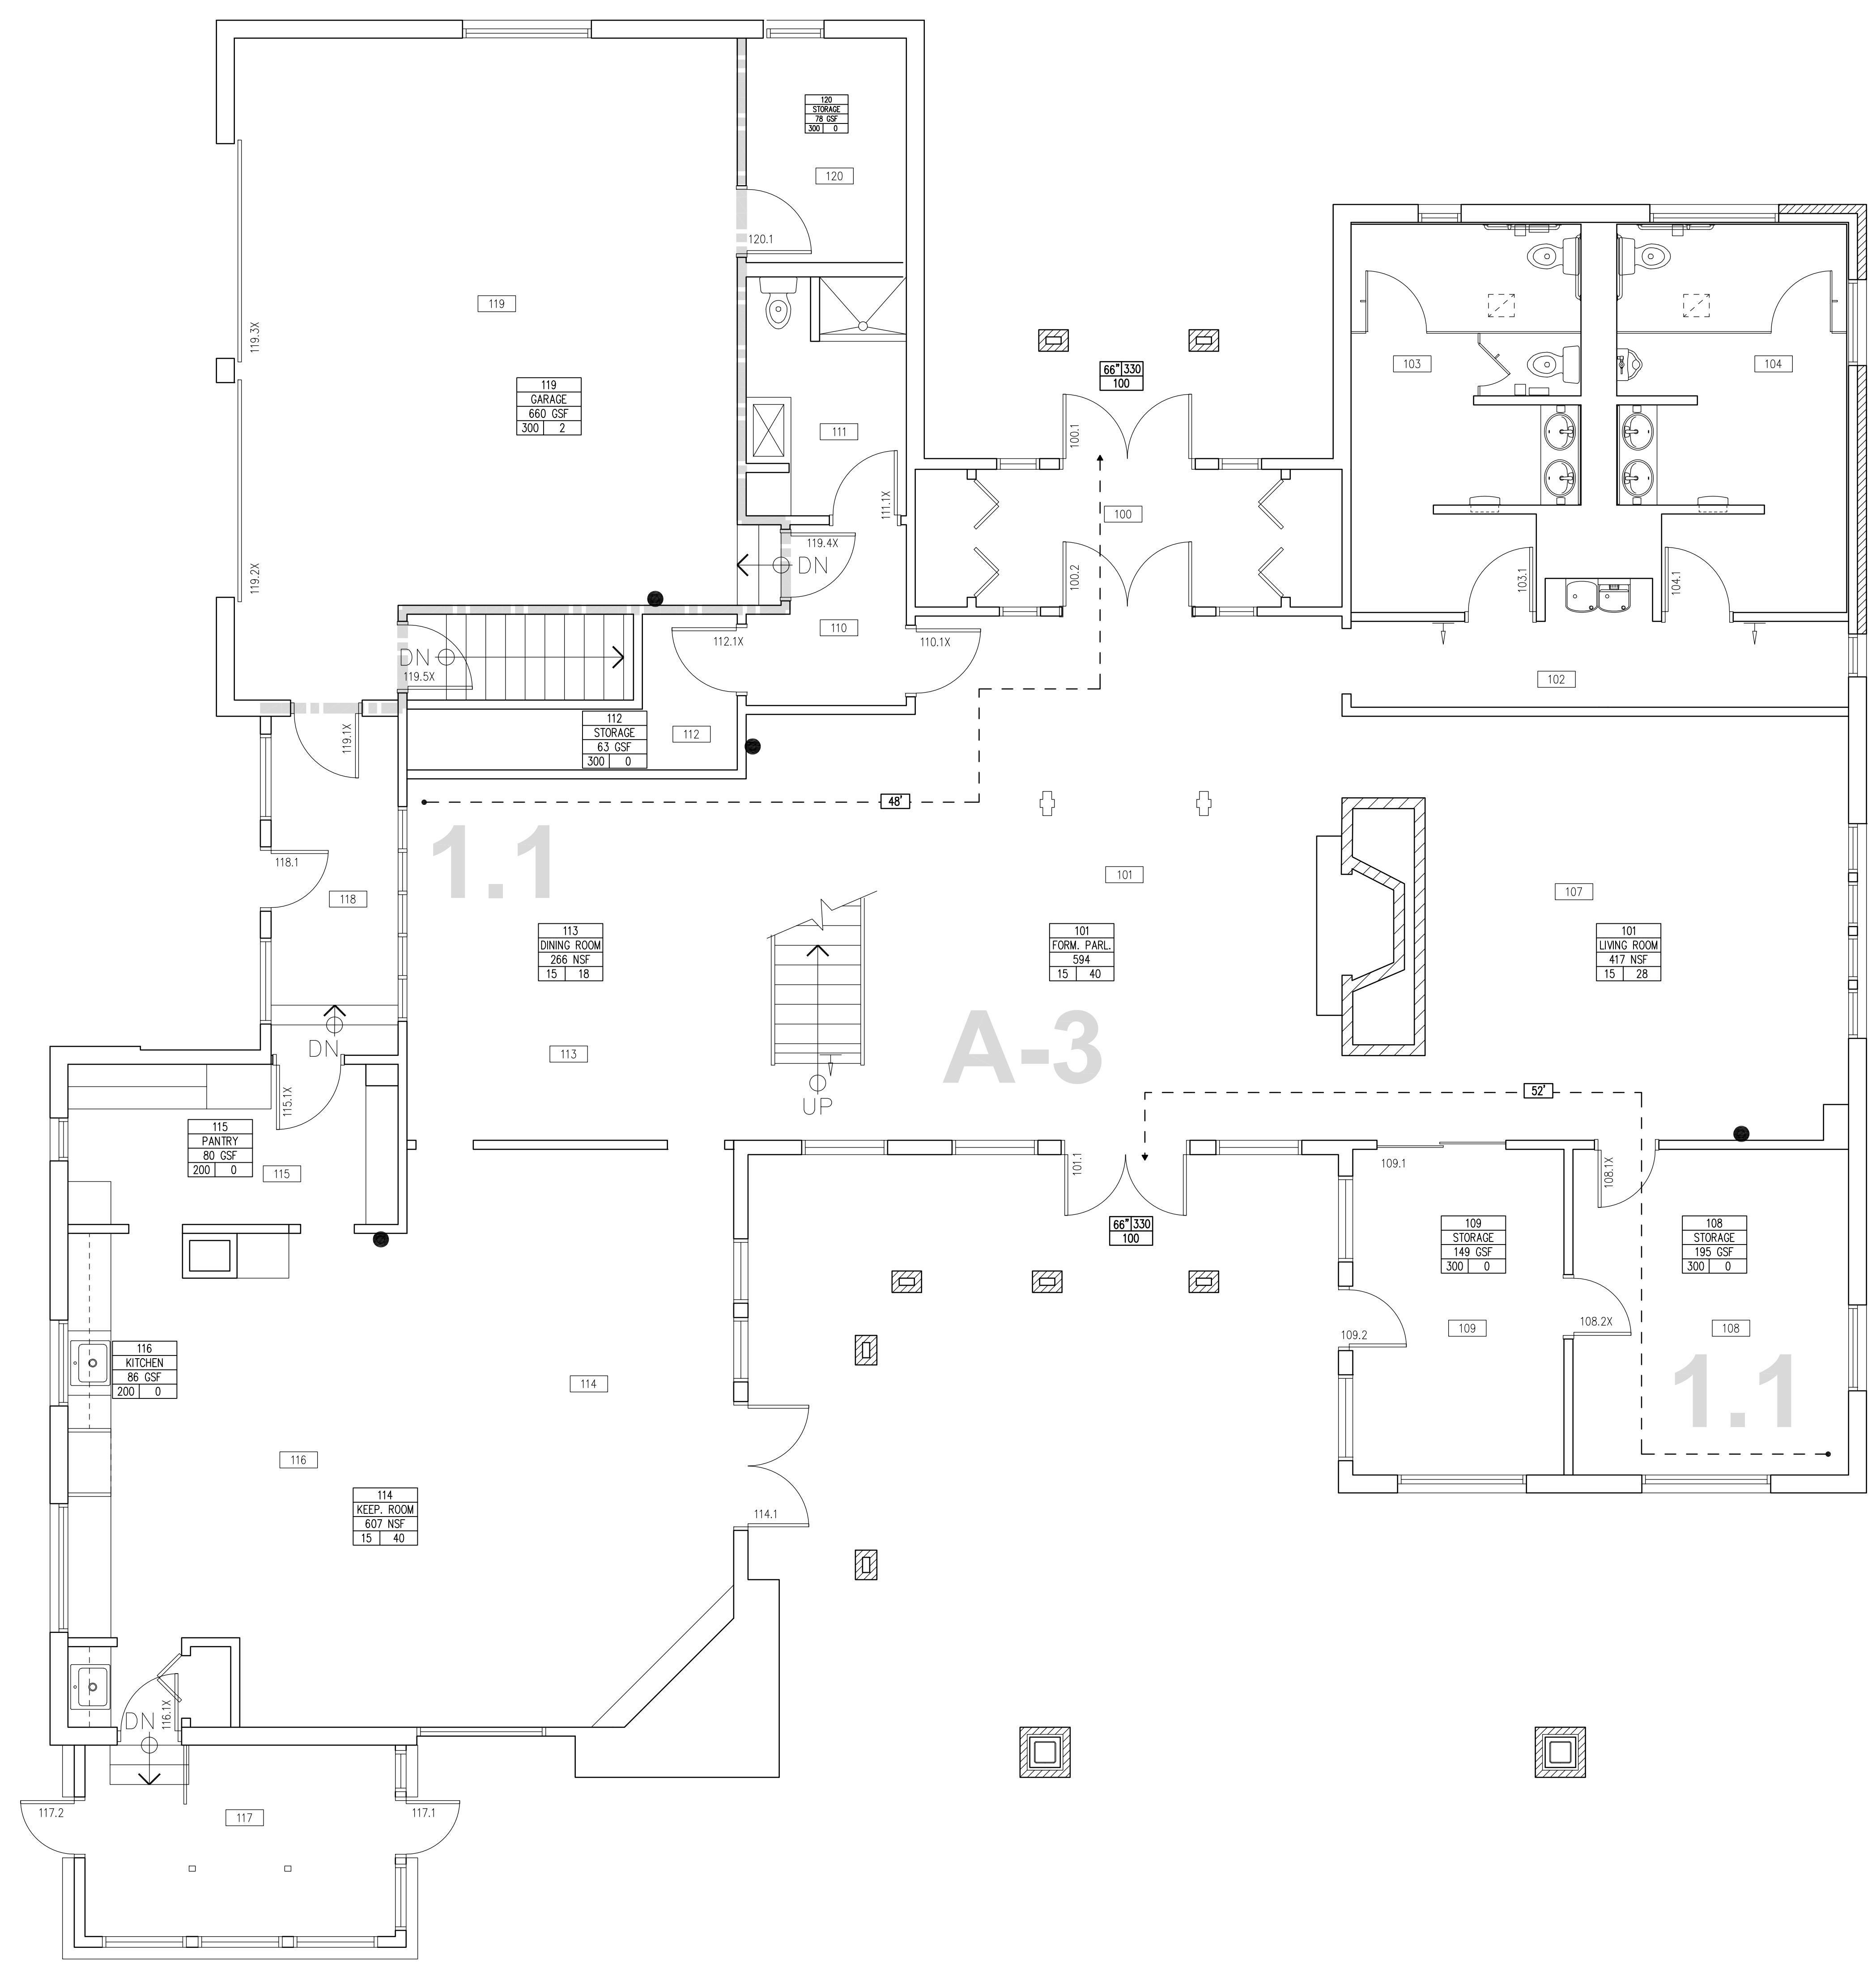

FIRST FLOOR CODE REVIEW PLAN - BUILDING CONSTRUCTION


SCALE: 1/4" = 1'-0" 1

KEYNOTES

KEYNOTES ARE TYPICALLY NOT DUPLICATED WITHIN A GIVEN DETAIL. AN UN-KEYNOTED ITEM IN A DETAIL IS THE SAME AS A KEYNOTED ITEM HAVING THE SAME APPEARANCE WITHIN THE SAME DETAIL.

- 1.570 APPROXIMATE LOCATION OF TEMPORARY EROSION AND SEDIMENT CONTROL FENCE LINE. REFER TO SPECIFICATIONS
- 1.571 CHAIN LINK FENCE: 6' HIGH.
- 1.572 CHAIN LINK FENCE GATE: WIDTH AS INDICATED.
- 1.573 TOP SOIL STORAGE AREA.

- 2.401 REMOVE EXISTING SITE FEATURE: SIDEWALK PAVEMENT.
- 2.402 REMOVE EXISTING SITE FEATURE: STONE PAVERS.
- 2.404 REMOVE EXISTING SITE FEATURE: TREE.
- 2.405 REMOVE EXISTING SITE FEATURE: SEPTIC TANK AND FIELD IN ITS ENTIRETY; REFER TO ALLOWANCE.

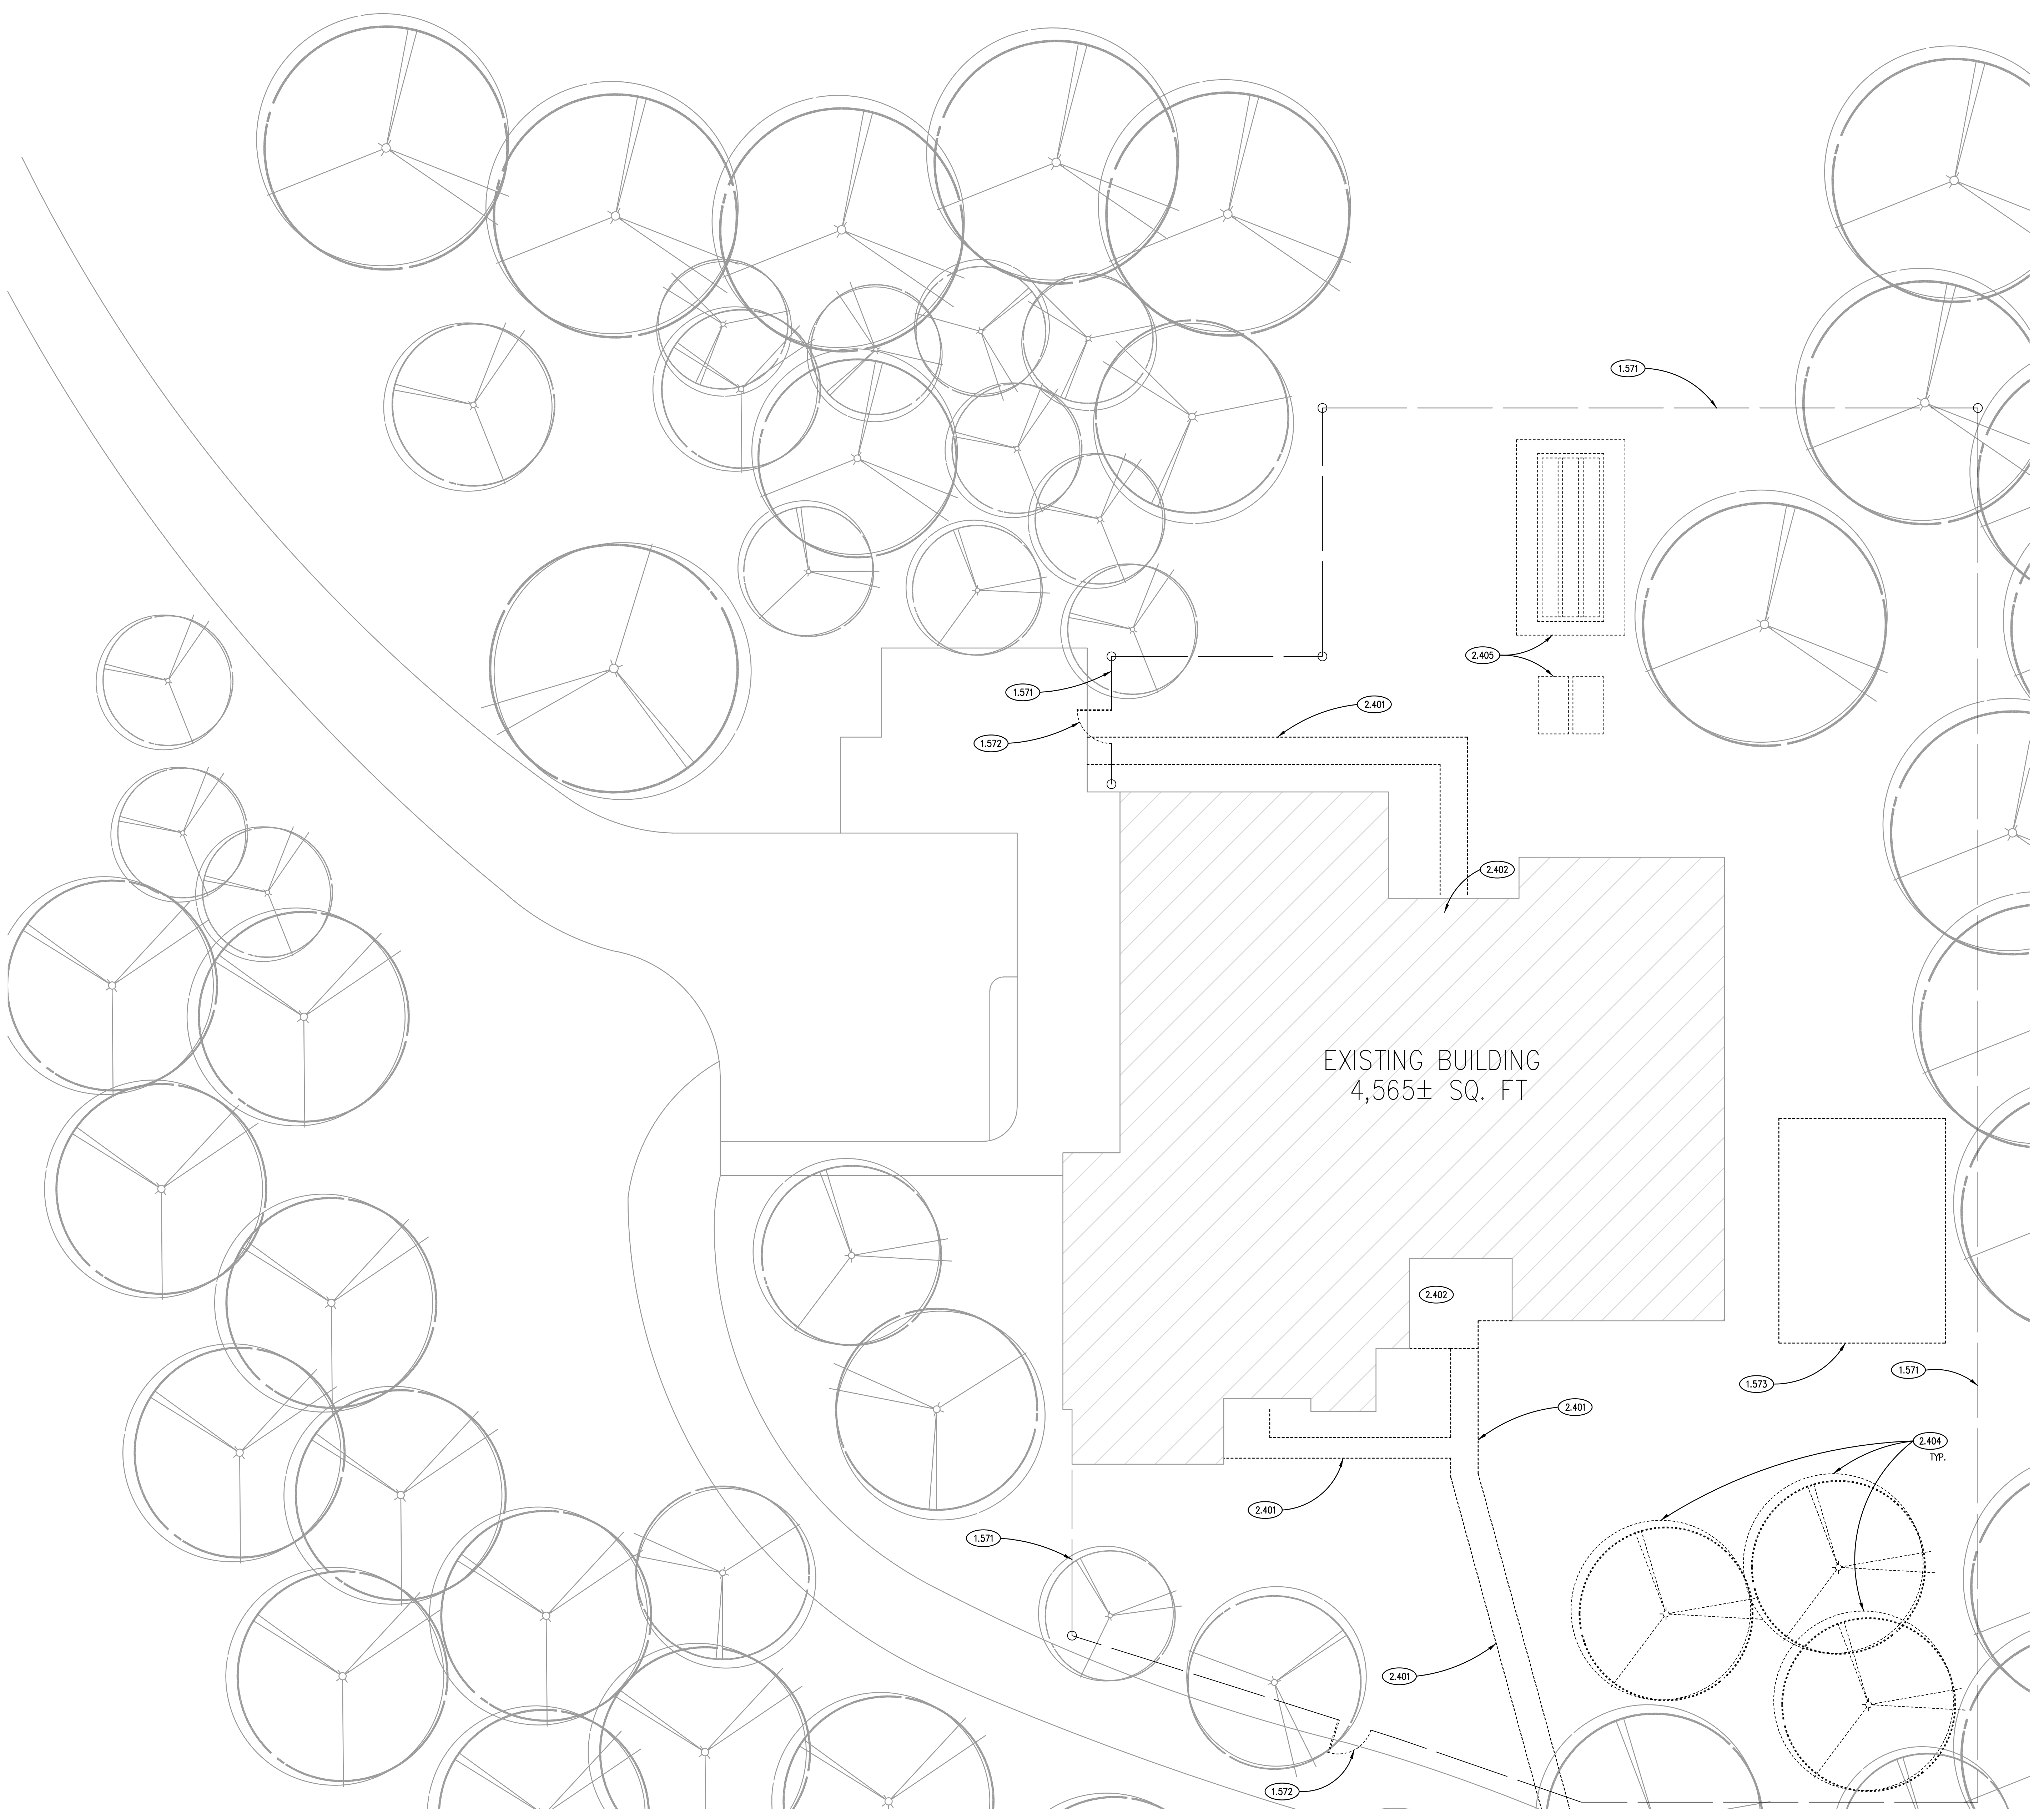

DEMOLITION SITE PLAN ①
SCALE: 1" = 10'-0"

GENERAL NOTES

- 1. REFER TO DRAWING G100 FOR PROJECT GENERAL NOTES.

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JOB NO.	19-429-1250
DRAWN	PJT
CHECKED	CJH
APPROVED	CJH

SHEET TITLE
DEMOLITION SITE PLAN


SHEET NUMBER

A050

KEYNOTES

KEYNOTES ARE TYPICALLY NOT DUPLICATED WITHIN A GIVEN DETAIL. AN UN-KEYNOTED ITEM IN A DETAIL IS THE SAME AS A KEYNOTED ITEM HAVING THE SAME APPEARANCE WITHIN THE SAME DETAIL.

- 26.002 GARDEN WALL SEAT CAP LIGHTING: TYPICAL. REFER TO ELECTRICAL DRAWINGS.
- 26.003 PATHWAY BOLLARD LIGHTING: TYPICAL. REFER TO ELECTRICAL DRAWINGS.
- 31.235 TOPSOIL: 6 INCHES DEEP ACROSS AFFECTED AREAS OF SITE DISTURBED BY CONSTRUCTION ACTIVITIES.
- 32.014 PRECAST CONCRETE UNIT PAVERS: PATTERN OF PAVERS AS SPECIFIED. REFER TO SPECIFICATIONS.
- 32.022 PRECAST CONCRETE DIMENSIONAL STONE SEAT WALL STONE BASE: MIN. 18 INCHES THICK.
- 32.025 PRE-MANUFACTURED CHIMNEY W/ WOOD BOX: REFER TO SPECIFICATIONS.
- 32.131 CONCRETE SIDEWALK: 5 INCHES THICK X 5 FEET WIDE WITH REINFORCING AND CONTROL JOINTS AT 5 FEET ON CENTER OVER MIN. 6 INCHES COMPACTED STONE BASE. REFER TO SPECIFICATIONS. RAISE GRADE AS REQUIRED WITH COMPACTED FILL TO ACCOMMODATE SLOPE OF RAMP. INFILL SIDES OF RAMP WITH TOPSOIL FOR A NATURAL GRADE AWAY FROM THE SIDEWALK SURFACE.
- 32.330 NEW SEPTIC FIELD AND TANK. REFER TO ALLOWANCES.
- 32.921 SEED & MULCH: INSTALL AT ALL AREAS OF THE SITE AFFECTED BY CONSTRUCTION AND SEPTIC SYSTEM INSTALLATION. REFER TO SPECIFICATIONS.

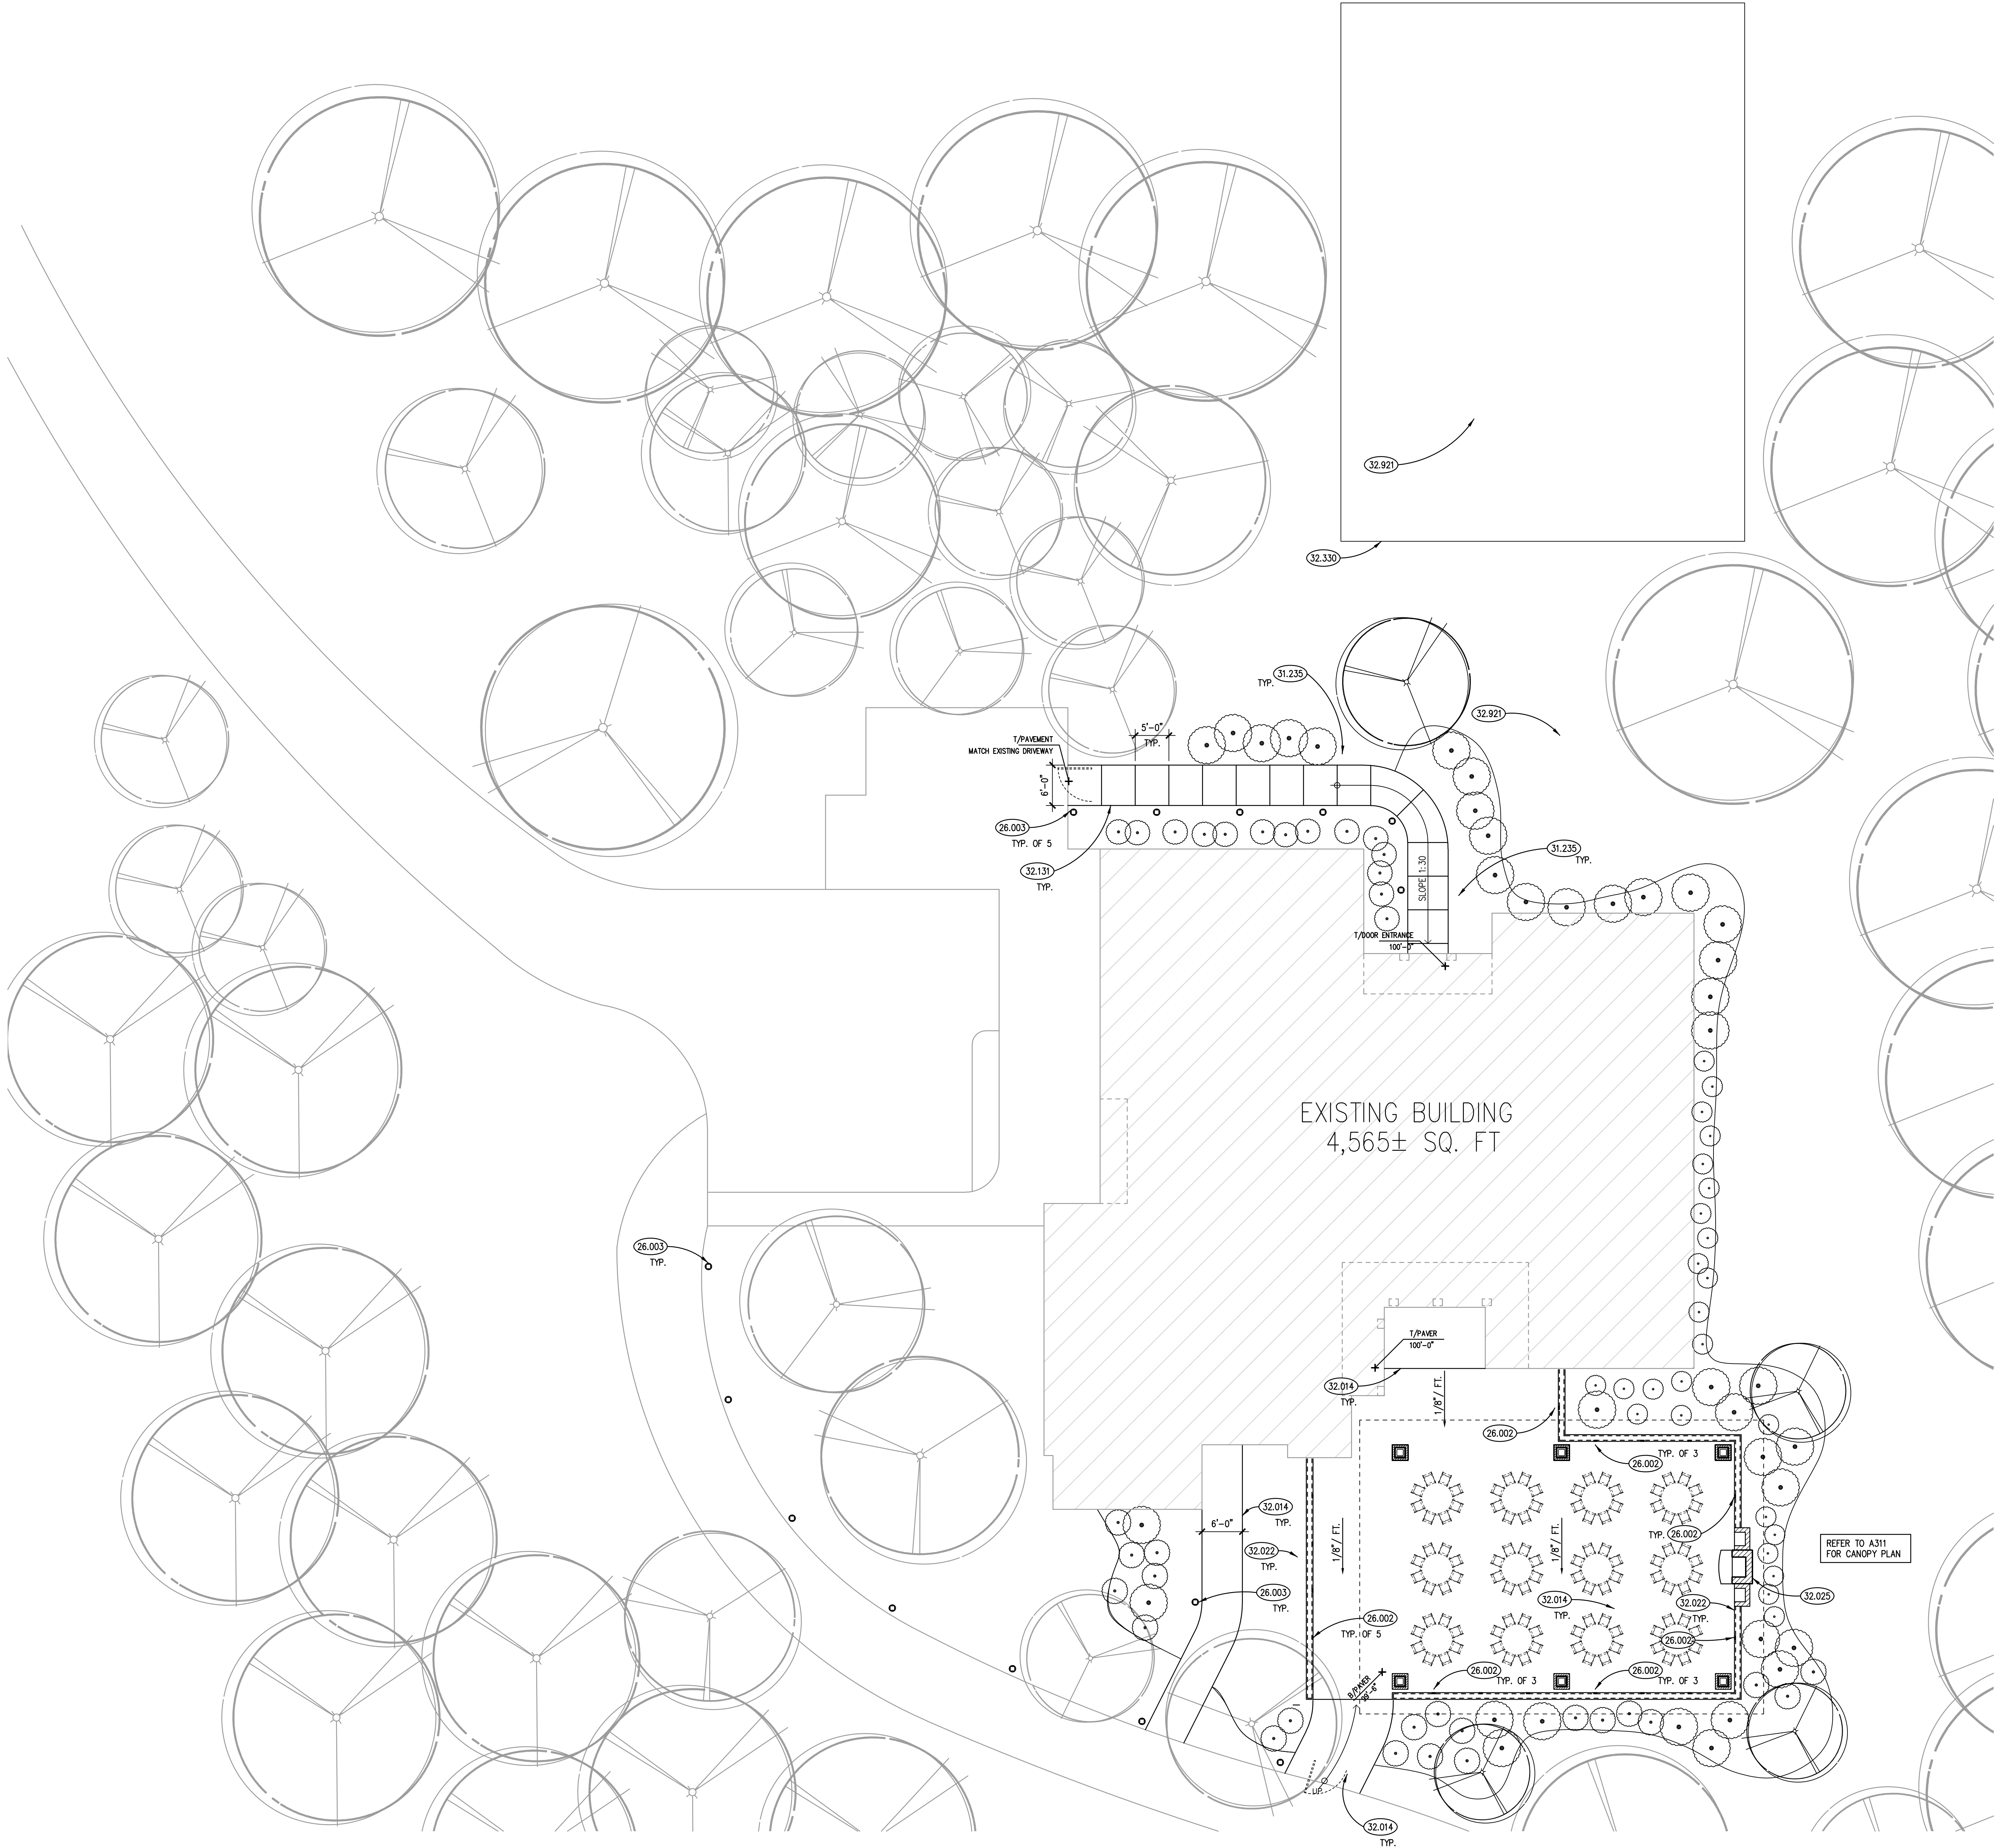

GENERAL NOTES

1. REFER TO DRAWING G100 FOR PROJECT GENERAL NOTES.

SITE PLAN
SCALE: 1" = 10'-0" ①

ISSUED	
01/09/22	BID DOCUMENTS
JOB NO.	19-429-1250
DRAWN	PJT
CHECKED	CJH
APPROVED	CJH
SHEET TITLE	
SITE PLAN	
SHEET NUMBER	
A100	

NOTE: SCALES DEPICTED ON THIS DRAWING ARE NOT CORRECT UNLESS PLOTTED SHEET SIZE IS 30 X 42 INCHES.

KEYNOTES

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- 2.049 EXISTING STONE PAVERS TO REMAIN.
- 2.068 EXISTING LINOLEUM TO REMAIN AND ENCAPSULATED.
- 2.069 EXISTING CABINETRY TO REMAIN.
- 2.402 REMOVE EXISTING SITE FEATURE: STONE PAVERS.
- 2.403 REMOVE EXISTING SITE FEATURE: STEPPED STONE PAVERS.
- 2.435 REMOVE EXISTING EXTERIOR WINDOW & FRAME.
- 2.438 REMOVE EXISTING EXTERIOR DOOR AND FRAME.
- 2.439 REMOVE EXISTING EXTERIOR SLIDING DOOR.
- 2.440 REMOVE EXISTING FIBER CEMENT SIDING AND TRIM.
- 2.452 REMOVE EXISTING INTERIOR WALL CONSTRUCTION: DRYWALL PARTITION.
- 2.459 REMOVE EXISTING FAILED GLASS UNIT.
- 2.460 REMOVE EXISTING INTERIOR SPECIALTY ITEM: DISHWASHER.
- 2.461 REMOVE EXISTING INTERIOR SPECIALTY ITEM: ELECTRIC RANGE TOP.
- 2.467 REMOVE EXISTING INTERIOR CONSTRUCTION: CASEWORK; AS INDICATED.
- 2.468 REMOVE EXISTING INTERIOR CONSTRUCTION: STAIRS.
- 2.469 REMOVE EXISTING INTERIOR CONSTRUCTION: WOOD DECK BOARDS.
- 2.470 REMOVE EXISTING INTERIOR CONSTRUCTION: WOOD SHELVING.
- 2.472 REMOVE EXISTING INTERIOR FLOORING: GRAVEL ROCK.
- 2.475 REMOVE EXISTING INTERIOR FLOOR FINISH: CARPET.
- 2.476 REMOVE EXISTING INTERIOR FLOOR FINISH: LINOLEUM.
- 2.479 REMOVE EXISTING COUNTERTOP.
- 2.480 REMOVE EXISTING INTERIOR WALL FINISH: FOIL WALLPAPER.
- 2.496 REMOVE EXISTING PLUMBING FIXTURE: AS INDICATED.
- 2.502 PATCH EXISTING FLOOR OPENING AFTER REMOVAL OF MECHANICAL CONNECTIONS.

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YORKVILLE, IL 60560

ROOM SCHEDULE

RM. NO.	ROOM NAME	RM. NO.	ROOM NAME
105	EXISTING BEDROOM		
106	EXISTING BATHROOM		
107	EXISTING LIVING ROOM		
108	EXISTING STORAGE		
109	EXISTING STORAGE		
110	EXISTING CORRIDOR		
111	EXISTING BATHROOM		
112	EXISTING JANITOR'S CLOSET		
113	EXISTING DINING ROOM		
114	EXISTING KEEPING ROOM		
115	EXISTING PANTRY		
116	EXISTING KITCHENETTE		
117	EXISTING GREEN HOUSE		
118	EXISTING FOYER		
119	EXISTING GARAGE		
120	EXISTING STORAGE		

GENERAL NOTES

1. REFER TO DRAWING G100 FOR PROJECT GENERAL NOTES.
2. UNLESS NOTED OTHERWISE, WHERE EXISTING FLOOR, WALL AND CEILING SURFACES ARE SCHEDULED TO RECEIVE FINISHES, DEMOLISH EXISTING FINISH MATERIALS (EXCEPT PROPERLY ADHERED PAINT) AND SALVAGE SURFACE-MOUNTED ITEMS; PROPERLY PREPARE SURFACES TO RECEIVE NEW FINISHES; REINSTALL SURFACE-MOUNTED ITEMS AT NEW LOCATIONS DETERMINED BY OWNER UNLESS SPECIFIC LOCATIONS ARE INDICATED ON DRAWINGS.
3. ADDITIONAL DEMOLITION/ RECONSTRUCTION AND REMOVAL/REPLACEMENT OF ARCHITECTURAL ELEMENTS IS REQUIRED TO COMPLETE THE WORK OF THIS PROJECT. COORDINATE WITH ARCHITECTURAL, MECHANICAL, PLUMBING, FIRE PROTECTION AND ELECTRICAL DRAWINGS, AND PROVIDE DEMOLITION/RECONSTRUCTION AND REMOVAL/REPLACEMENT OF ARCHITECTURAL ELEMENTS AS REQUIRED TO COMPLETE THE WORK SHOWN ON THOSE DRAWINGS.



FIRST FLOOR DEMOLITION PLAN

SCALE: 1/4" = 1'-0"

1

ISSUED
01/10/22 | BID DOCUMENTS

JOB NO. 19-429-1250
DRAWN PJT
CHECKED CJH
APPROVED CJH

SHEET TITLE
FIRST FLOOR
DEMOLITION PLAN

SHEET NUMBER

A210

KEYNOTES

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- 2.067 EXISTING WOOD BEAM.
- 2.482 REMOVE EXISTING INTERIOR CEILING FINISH: DRYWALL AND SUSPENDED FURRING.
- 2.492 REMOVE EXISTING MECHANICAL SYSTEM COMPONENT: CEILING DIFFUSER/GRILLE.
- 2.498 REMOVE EXISTING LIGHT FIXTURE.
- 2.499 REMOVE EXISTING LIGHT FIXTURE AND TRACK.
- 2.500 REMOVE EXISTING EXTERIOR LIGHT FIXTURE.

ROOM SCHEDULE

RM. NO.	ROOM NAME	RM. NO.	ROOM NAME
100	EXISTING FOYER		
101	EXISTING FORMAL PARLOR		
102	EXISTING CORRIDOR		
103	EXISTING BATHROOM		
104	EXISTING PET SUITE		
105	EXISTING BEDROOM		
106	EXISTING BATHROOM		
107	EXISTING LIVING ROOM		
108	EXISTING STORAGE		
109	EXISTING STORAGE		
110	EXISTING CORRIDOR		
111	EXISTING BATHROOM		
112	EXISTING JANITOR'S CLOSET		
113	EXISTING DINING ROOM		
114	EXISTING KEEPING ROOM		
115	EXISTING PANTRY		
116	EXISTING KITCHENETTE		
117	EXISTING GREEN HOUSE		
118	EXISTING FOYER		
119	EXISTING GARAGE		
120	EXISTING STORAGE		

GENERAL NOTES

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01/10/2021	BID DOCUMENTS

JOB NO.	19-429-1250
DRAWN	PJT
CHECKED	CJH
APPROVED	CJH

SHEET TITLE
FIRST FLOOR REFLECTED CEILING DEMOLITION PLAN
SHEET NUMBER

A210C





FIRST FLOOR REFLECTED CEILING DEMOLITION PLAN

SCALE: 1/4" = 1'-0" 1

KEYNOTES

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- 2.442 REMOVE EXISTING ROOFING: SINGLE-PLY MEMBRANE, BALLASTED.
- 2.443 REMOVE EXISTING ROOFING: SINGLE-PLY MEMBRANE.
- 2.445 REMOVE EXISTING ROOFING: ASPHALT SHINGLES.
- 2.446 REMOVE EXISTING ROOFING COMPONENT: METAL GUTTER.
- 2.490 REMOVE EXISTING MECHANICAL UNIT: REFER TO MECHANICAL DRAWINGS FOR ADDITIONAL INFORMATION.

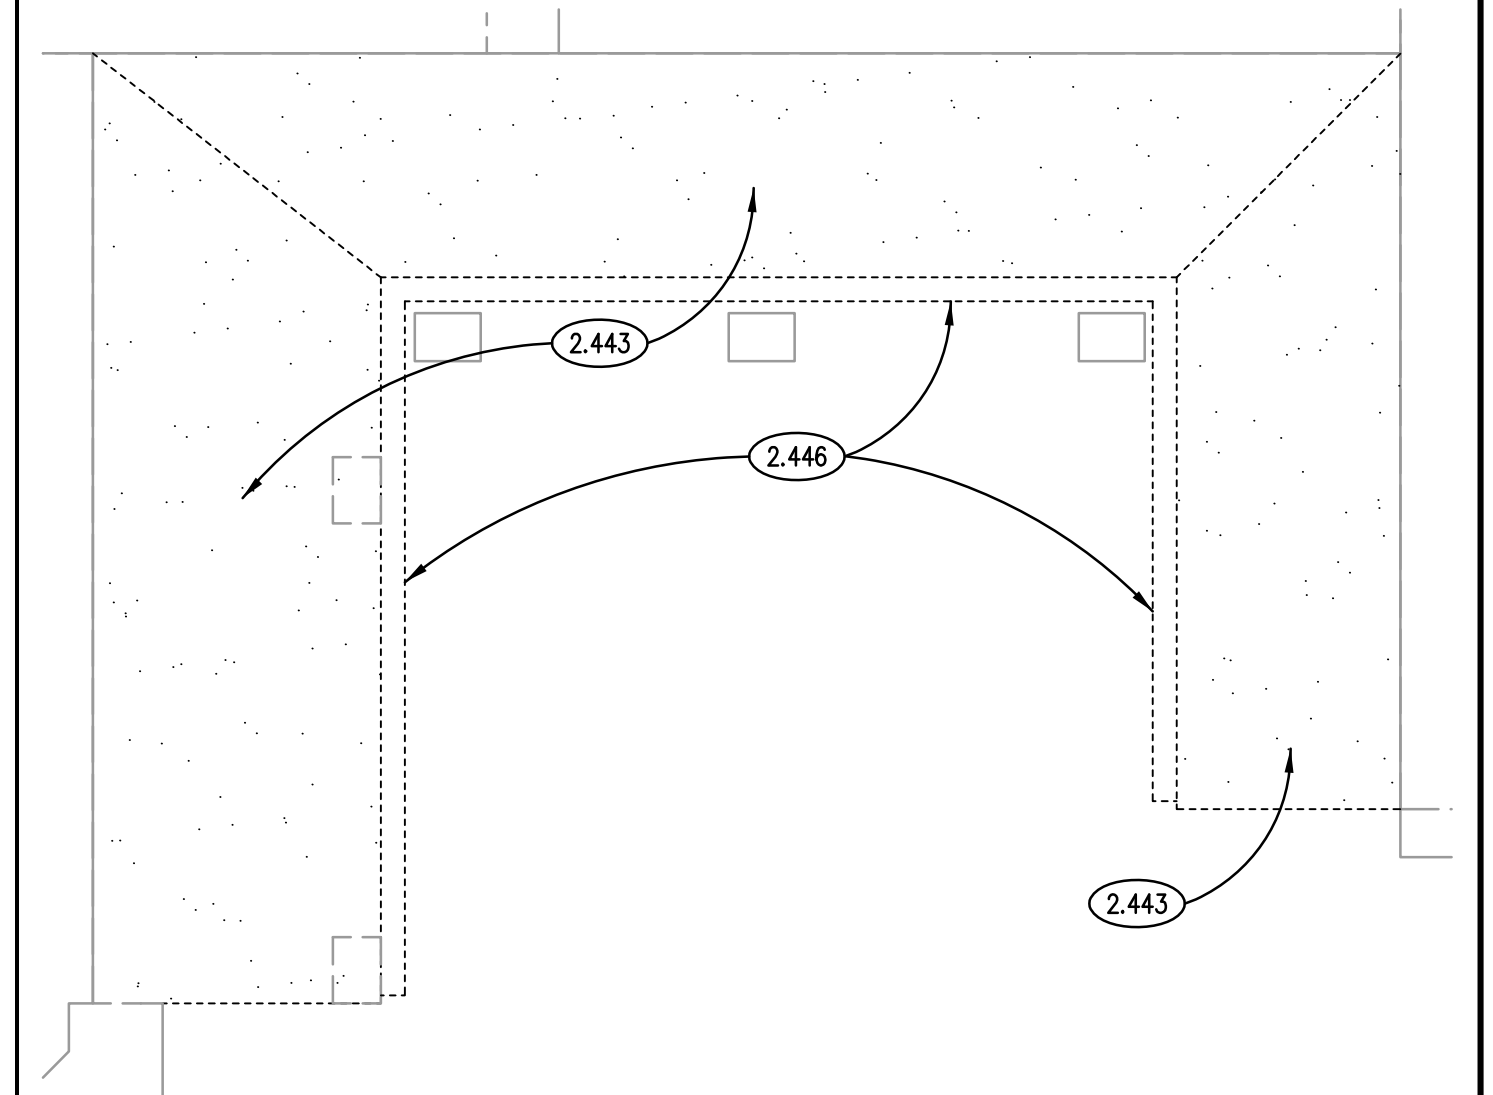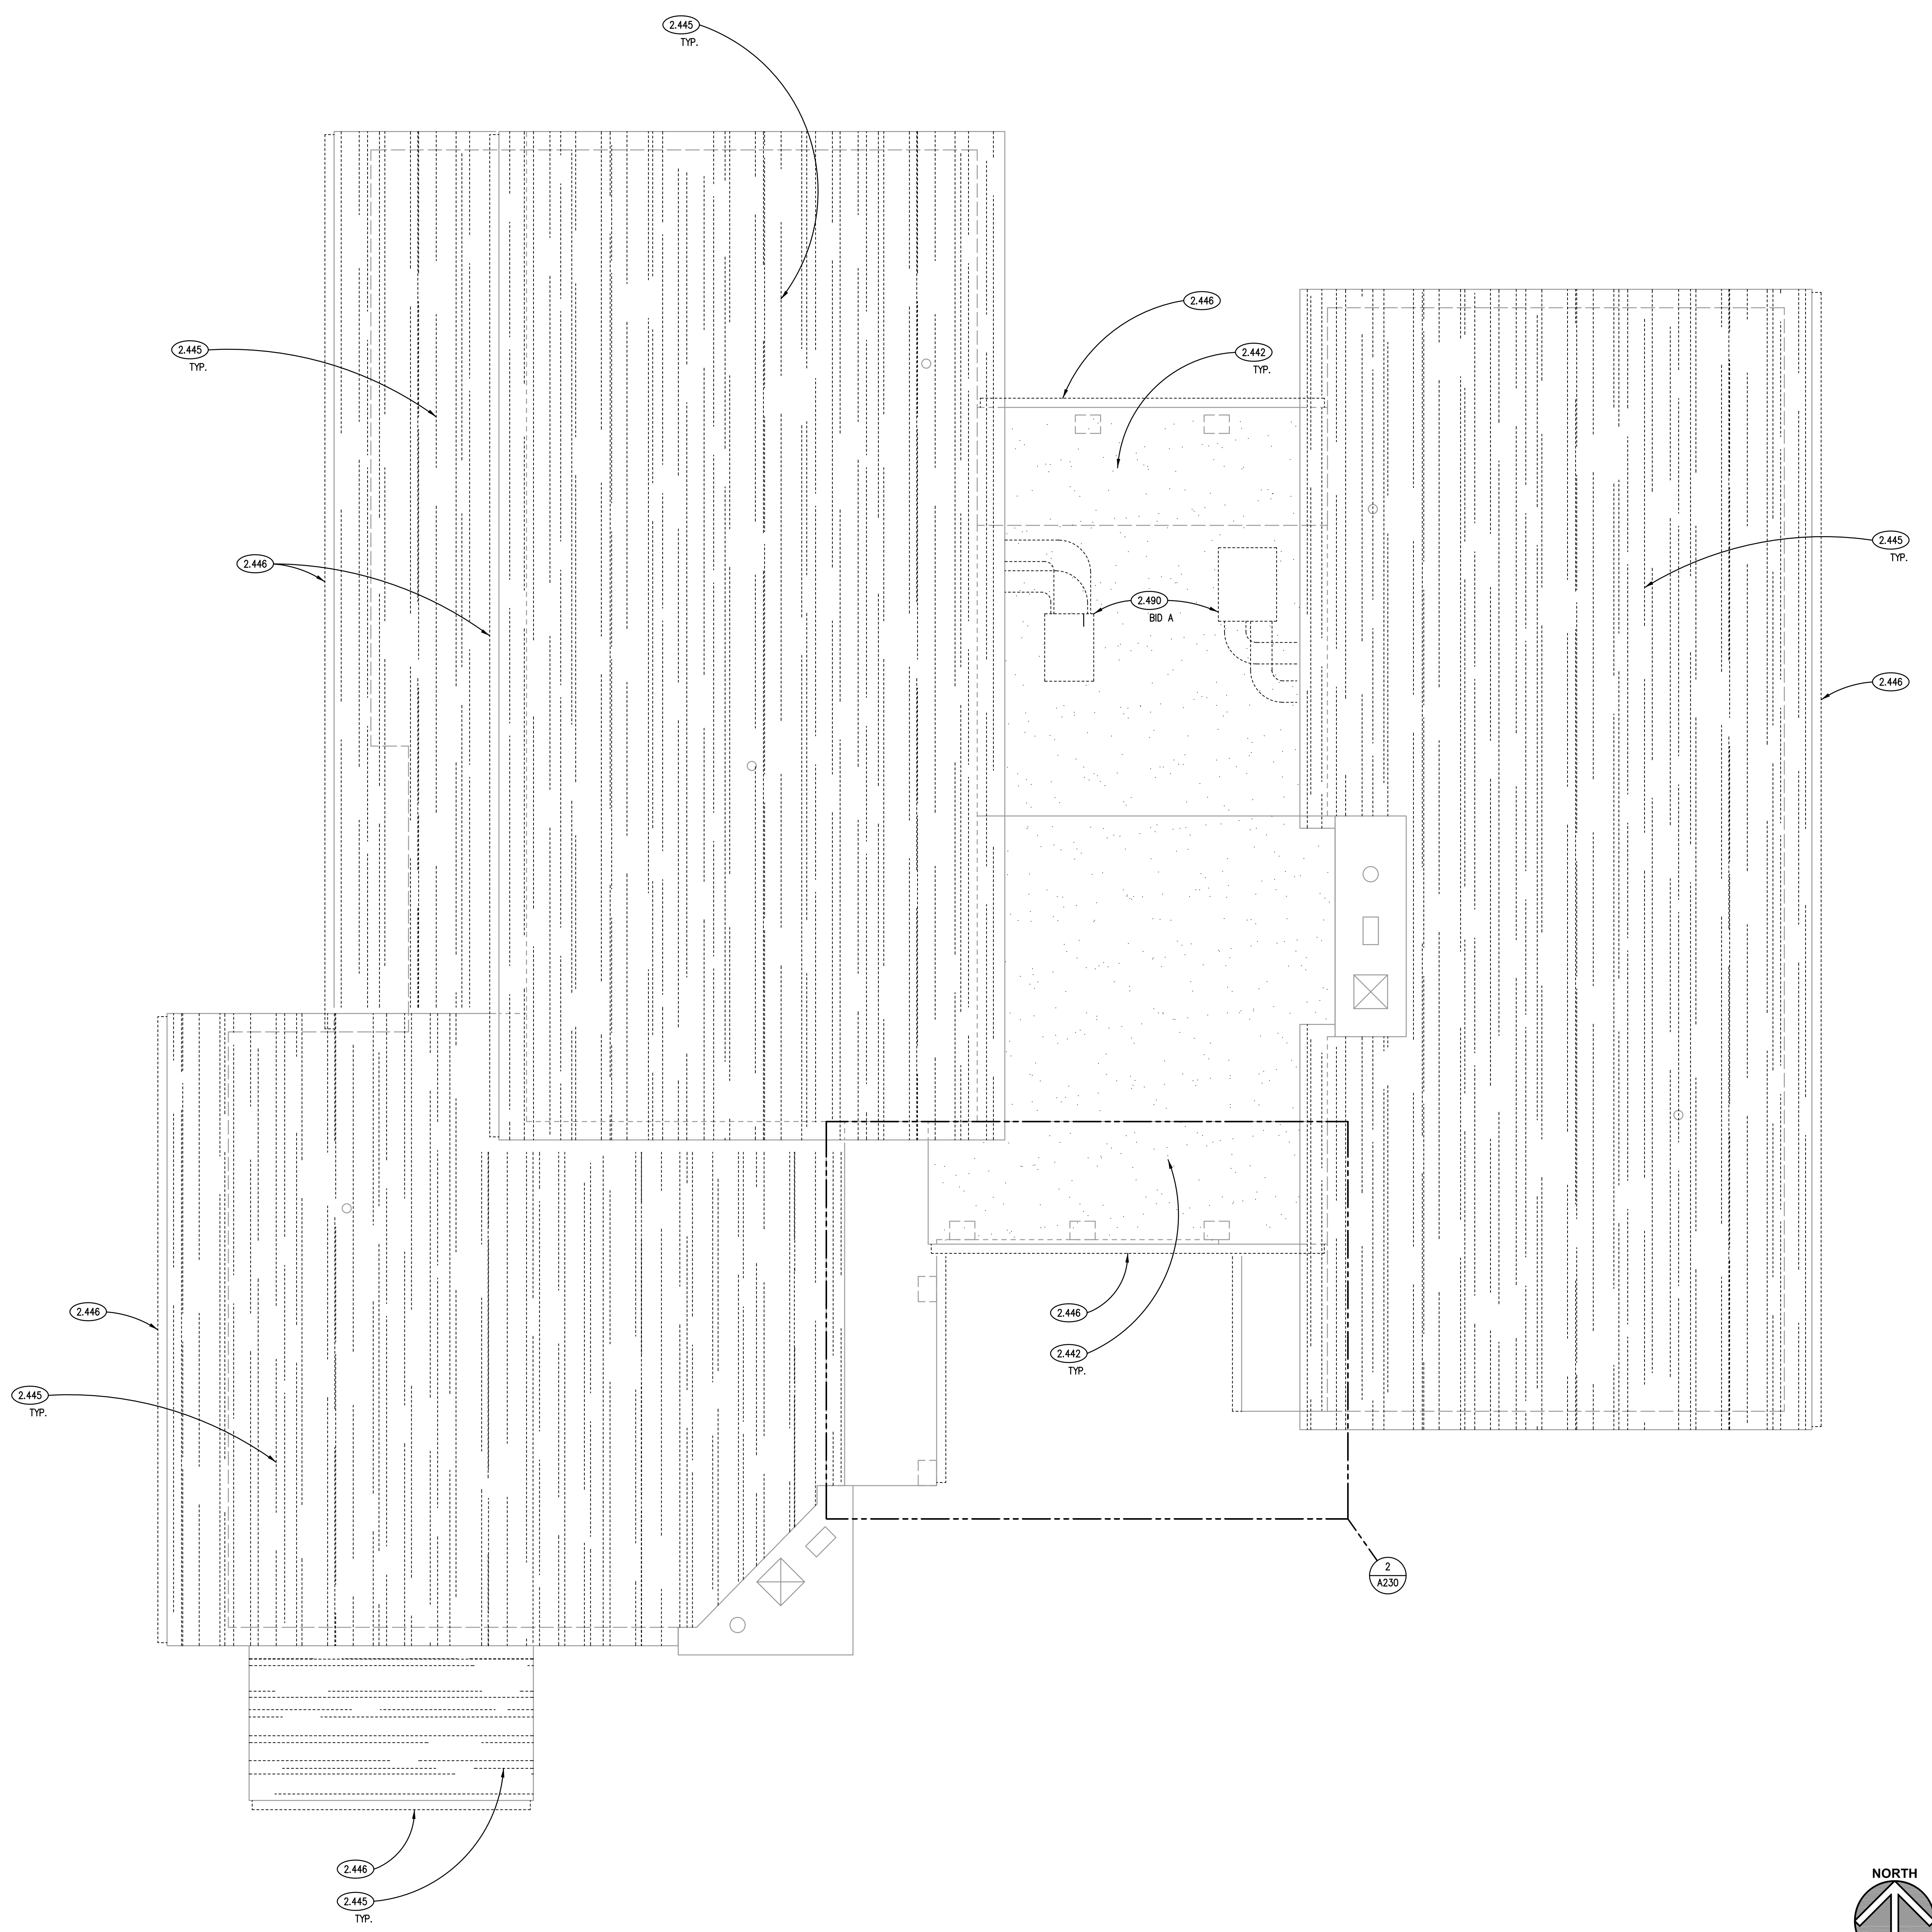

LOWER DEMOLITION ROOF PLAN ②
SCALE: 1/4" = 1'-0"

GENERAL NOTES

1. REFER TO DRAWING G100 FOR PROJECT GENERAL NOTES.

DEMOLITION ROOF PLAN ①
SCALE: 1/4" = 1'-0"

ISSUED	
01/06/22	BID DOCUMENTS

JOB NO.	19-429-1250
DRAWN	PJT
CHECKED	CJH
APPROVED	CJH

SHEET TITLE
DEMOLITION ROOF PLAN

SHEET NUMBER

A230


KEYNOTES

- 2.069 EXISTING CABINETS TO REMAIN.
- 2.070 EXISTING WOOD BASE TO REMAIN.
- 3.032 CAST-IN-PLACE CONCRETE: SLAB-ON-GRADE INFILL; 4" THICK, MIN.
- 3.033 CAST-IN-PLACE CONCRETE STAIRS.
- 5.070 METAL FABRICATION: STEEL HANDRAIL ASSEMBLY; 1 1/4" NOM. DIA. STEEL PIPE W/WALL BRACKETS OR FLOOR SUPPORTS @ 4'-0" O.C. MAX.
- 6.211 FINISH CARPETRY: WOOD BASE; REFER TO FINISHES SCHEDULE.
- 6.212 FINISH CARPETRY: WOOD PANEL SYSTEM.
- 6.410 CUSTOM CASEWORK: PLASTIC LAMINATE BASE CABINET; ADA LAVATORY UNIT WITH DIAGONAL PANEL.
- 6.411 CUSTOM CASEWORK: PLASTIC LAMINATE REMOVABLE DIAGONAL PANEL; ADA COMPLIANT.
- 8.141 WOOD EXTERIOR SWING ENTRANCE DOOR AND FRAME WITH APPLIED TRIM APPLICAIE TO MATCH EXISTING PROFILES. REFER TO DOOR, FRAME AND BORROWED LIGHT SCHEDULE.
- 8.801 INSULATED GLASS UNITS: TOUCH UP STAINS ON WINDOW STRIPS AFTER INSTALLATION.
- 8.803 MIRROR: SIZED FOR WIDTH OF OPENING BY HEIGHT AS SHOWN WITH BOTTOM METAL TRACK SUPPORT. REFER TO SPECIFICATIONS.
- 8.840 WASH WINDOWS BEFORE CONCEALMENT.
- 9.300 CERAMIC WALL TILE: PORCELAIN; REFER TO A900 SERIES DRAWINGS.
- 9.310 CERAMIC TILE ACCESSORY: METAL TRANSITION COVE BASE, BILLUNOSE OUTSIDE CORNER OR EDGE TRIM; TYPICAL AT FULL RESTROOM AREA; REFER TO SPECIFICATIONS.
- 9.650 RESILIENT FLOORING: LVT WOOD GRAIN PLANK FLOORING. REFER TO A900 SERIES DRAWINGS.
- 9.915 INTERIOR PAINTING: PRIME AND TWO COATS PAINT EXTERIOR SWING DOORWAY.
- 9.930 STAINING AND FINISHING: PREPARE, STAIN AND FINISH WOOD TRIM TO MATCH EXISTING STAIN COLOR. TYPICAL FOR ALL NEW INTERIOR STAIN ON DOORS, JAMBS AND CASINGS. REFER TO SPECIFICATIONS.
- 10.140 SIGNAGE: PANEL TYPE. WALL MOUNTED. "MEN" AND "WOMEN" RESTROOM SIGNAGE WITH UNIVERSAL ACCESSIBILITY SYMBOL. TYPICAL AT TWO NEW RESTROOMS.
- 10.141 SIGNAGE: CHAINED OFF STAIRWAY SIGN. "NO PUBLIC ACCESS."
- 10.211 METAL TOILET COMPARTMENT. ADA CONFIGURATION. REFER TO SPECIFICATIONS.
- 10.212 METAL TOILET COMPARTMENT. REGULAR CONFIGURATION. REFER TO SPECIFICATIONS.
- 10.440 FIRE PROTECTION ACCESSORY: FIRE EXTINGUISHER AND WALL BRACKET.
- 12.360 COUNTERTOP: SOLID SURFACE; REFER TO SPECIFICATIONS.
- 12.361 COUNTERTOP BACK/SIDE SPLASH: 4" HIGH; SAME MATERIAL AS COUNTERTOP.
- 12.362 COUNTERTOP ACCESSORY: LAVATORY SINK LT; UNDERMOUNT SOLID SURFACE TYPE. REFER TO SPECIFICATIONS.
- 12.363 COUNTERTOP ACCESSORY: COUNTERTOP SUPPORT BRACKET; CONCEALED IN WALL TYPE. REFER TO SPECIFICATIONS.
- 12.370 SINK: SINGLE BOWL, ADA ACCESSIBLE; SK-1.
- 12.371 SINK: SINGLE BOWL, NON-ADA ACCESSIBLE; SK-2.
- 26.004 LIGHT FIXTURE: INTERIOR; REFER TO ELECTRICAL DRAWINGS.

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KENDALL COUNTY FOREST PRESERVE DISTRICT
110 W. MADISON STREET
YORKVILLE, IL 60560



INTERIOR ELEVATION
SCALE: 1/4" = 1'-0" ②

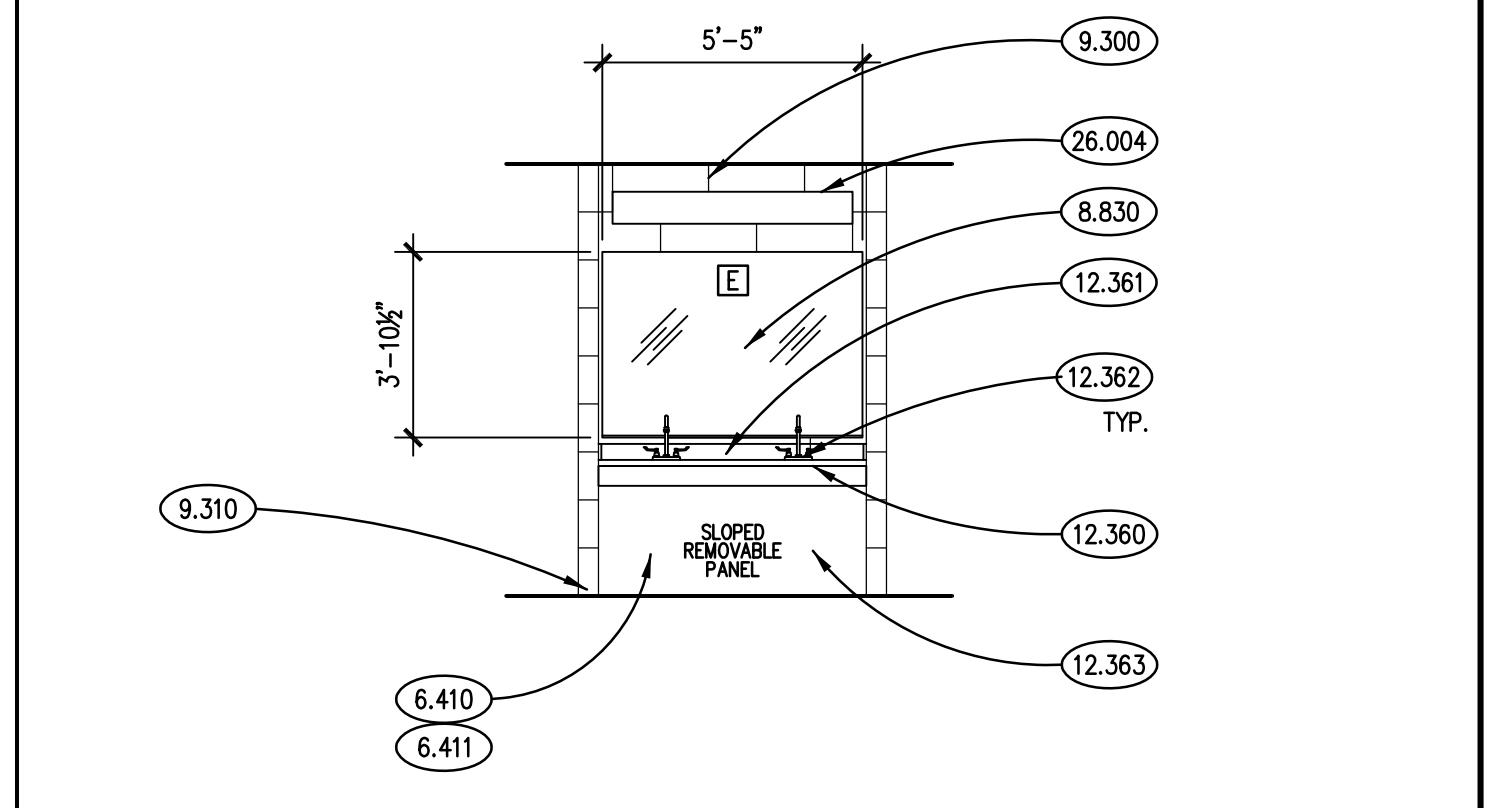TOILET ACCESSORY SCHEDULE

MARK	DESCRIPTION	CAT. NO.	REMARKS	MOUNTING HEIGHTS
A	S.S. GRAB BAR - 36"	3800-36	SNAP-ON FLANGE COVER	SEE SHEET G201
B	S.S. GRAB BAR - 42"	3800-42	SNAP-ON FLANGE COVER	SEE SHEET G201
C	S.S. GRAB BAR - 18" (VERTICAL)	3800-18	SNAP-ON FLANGE COVER	SEE SHEET G201
D	WALL MOUNTED SOAP DISPENSER	5001-SS	SURF. MTD.	46" MAX. TO DISPENSER LEVEL
E	CHANNEL FRAME MIRROR	--	REFER TO SPECS.	40" TO BOTTOM
F	AUTOMATIC PAPER TOWEL DISPENSER/ WASTE RECEPTACLE COMBO UNIT	204692A-6	SEMI-RECESSED	48" TO TOP EDGE OF TOWEL DISPENSER
G	TOILET TISSUE DISPENSER	0030	SURF. MTD.	SEE SHEET G201
H	SANITARY NAPKIN DISPOSAL	0852	SURFACE MOUNTED	44" TO TOP

TOILET ACCESSORY GENERAL NOTES

- A.S.I. CATALOG NUMBERS ARE USED FOR REFERENCE ONLY, UNLESS OTHERWISE NOTED.
- MOUNTING HEIGHTS PER ADA-AG (AMERICAN'S WITH DISABILITIES ACT ACCESSIBILITIES GUIDELINES).
- MOUNTING HEIGHTS ARE FROM FINISHED FLOOR TO HEIGHT INDICATED.

TOILET ACCESSORY REMARKS

- BOBRICK CATALOG NUMBERS, USED FOR REFERENCE ONLY.
- DUROLLA MODEL NUMBERS, USED FOR REFERENCE ONLY.

ROOM SCHEDULE

RM. NO.	ROOM NAME	RM. NO.	ROOM NAME
109	NOT USED	113	EXISTING DINING ROOM
106	NOT USED	114	EXISTING KEEPING ROOM
107	EXISTING LIVING ROOM	115	EXISTING PANTRY
108	EXISTING STORAGE	116	EXISTING KITCHEN
109	EXISTING STORAGE	117	EXISTING GREEN HOUSE
110	EXISTING CORRIDOR	118	EXISTING FOYER
111	EXISTING BATHROOM	119	EXISTING GARAGE
112	EXISTING JANITOR'S CLOSET	120	EXISTING STORAGE

GENERAL NOTES


- REFER TO DRAWING G100 FOR PROJECT GENERAL NOTES.

ISSUED	
01/09/22	BID DOCUMENTS

JOB NO.	19-429-1250
DRAWN	PJT
CHECKED	CJH
APPROVED	CJH

SHEET TITLE
FIRST FLOOR PLAN

SHEET NUMBER
A310

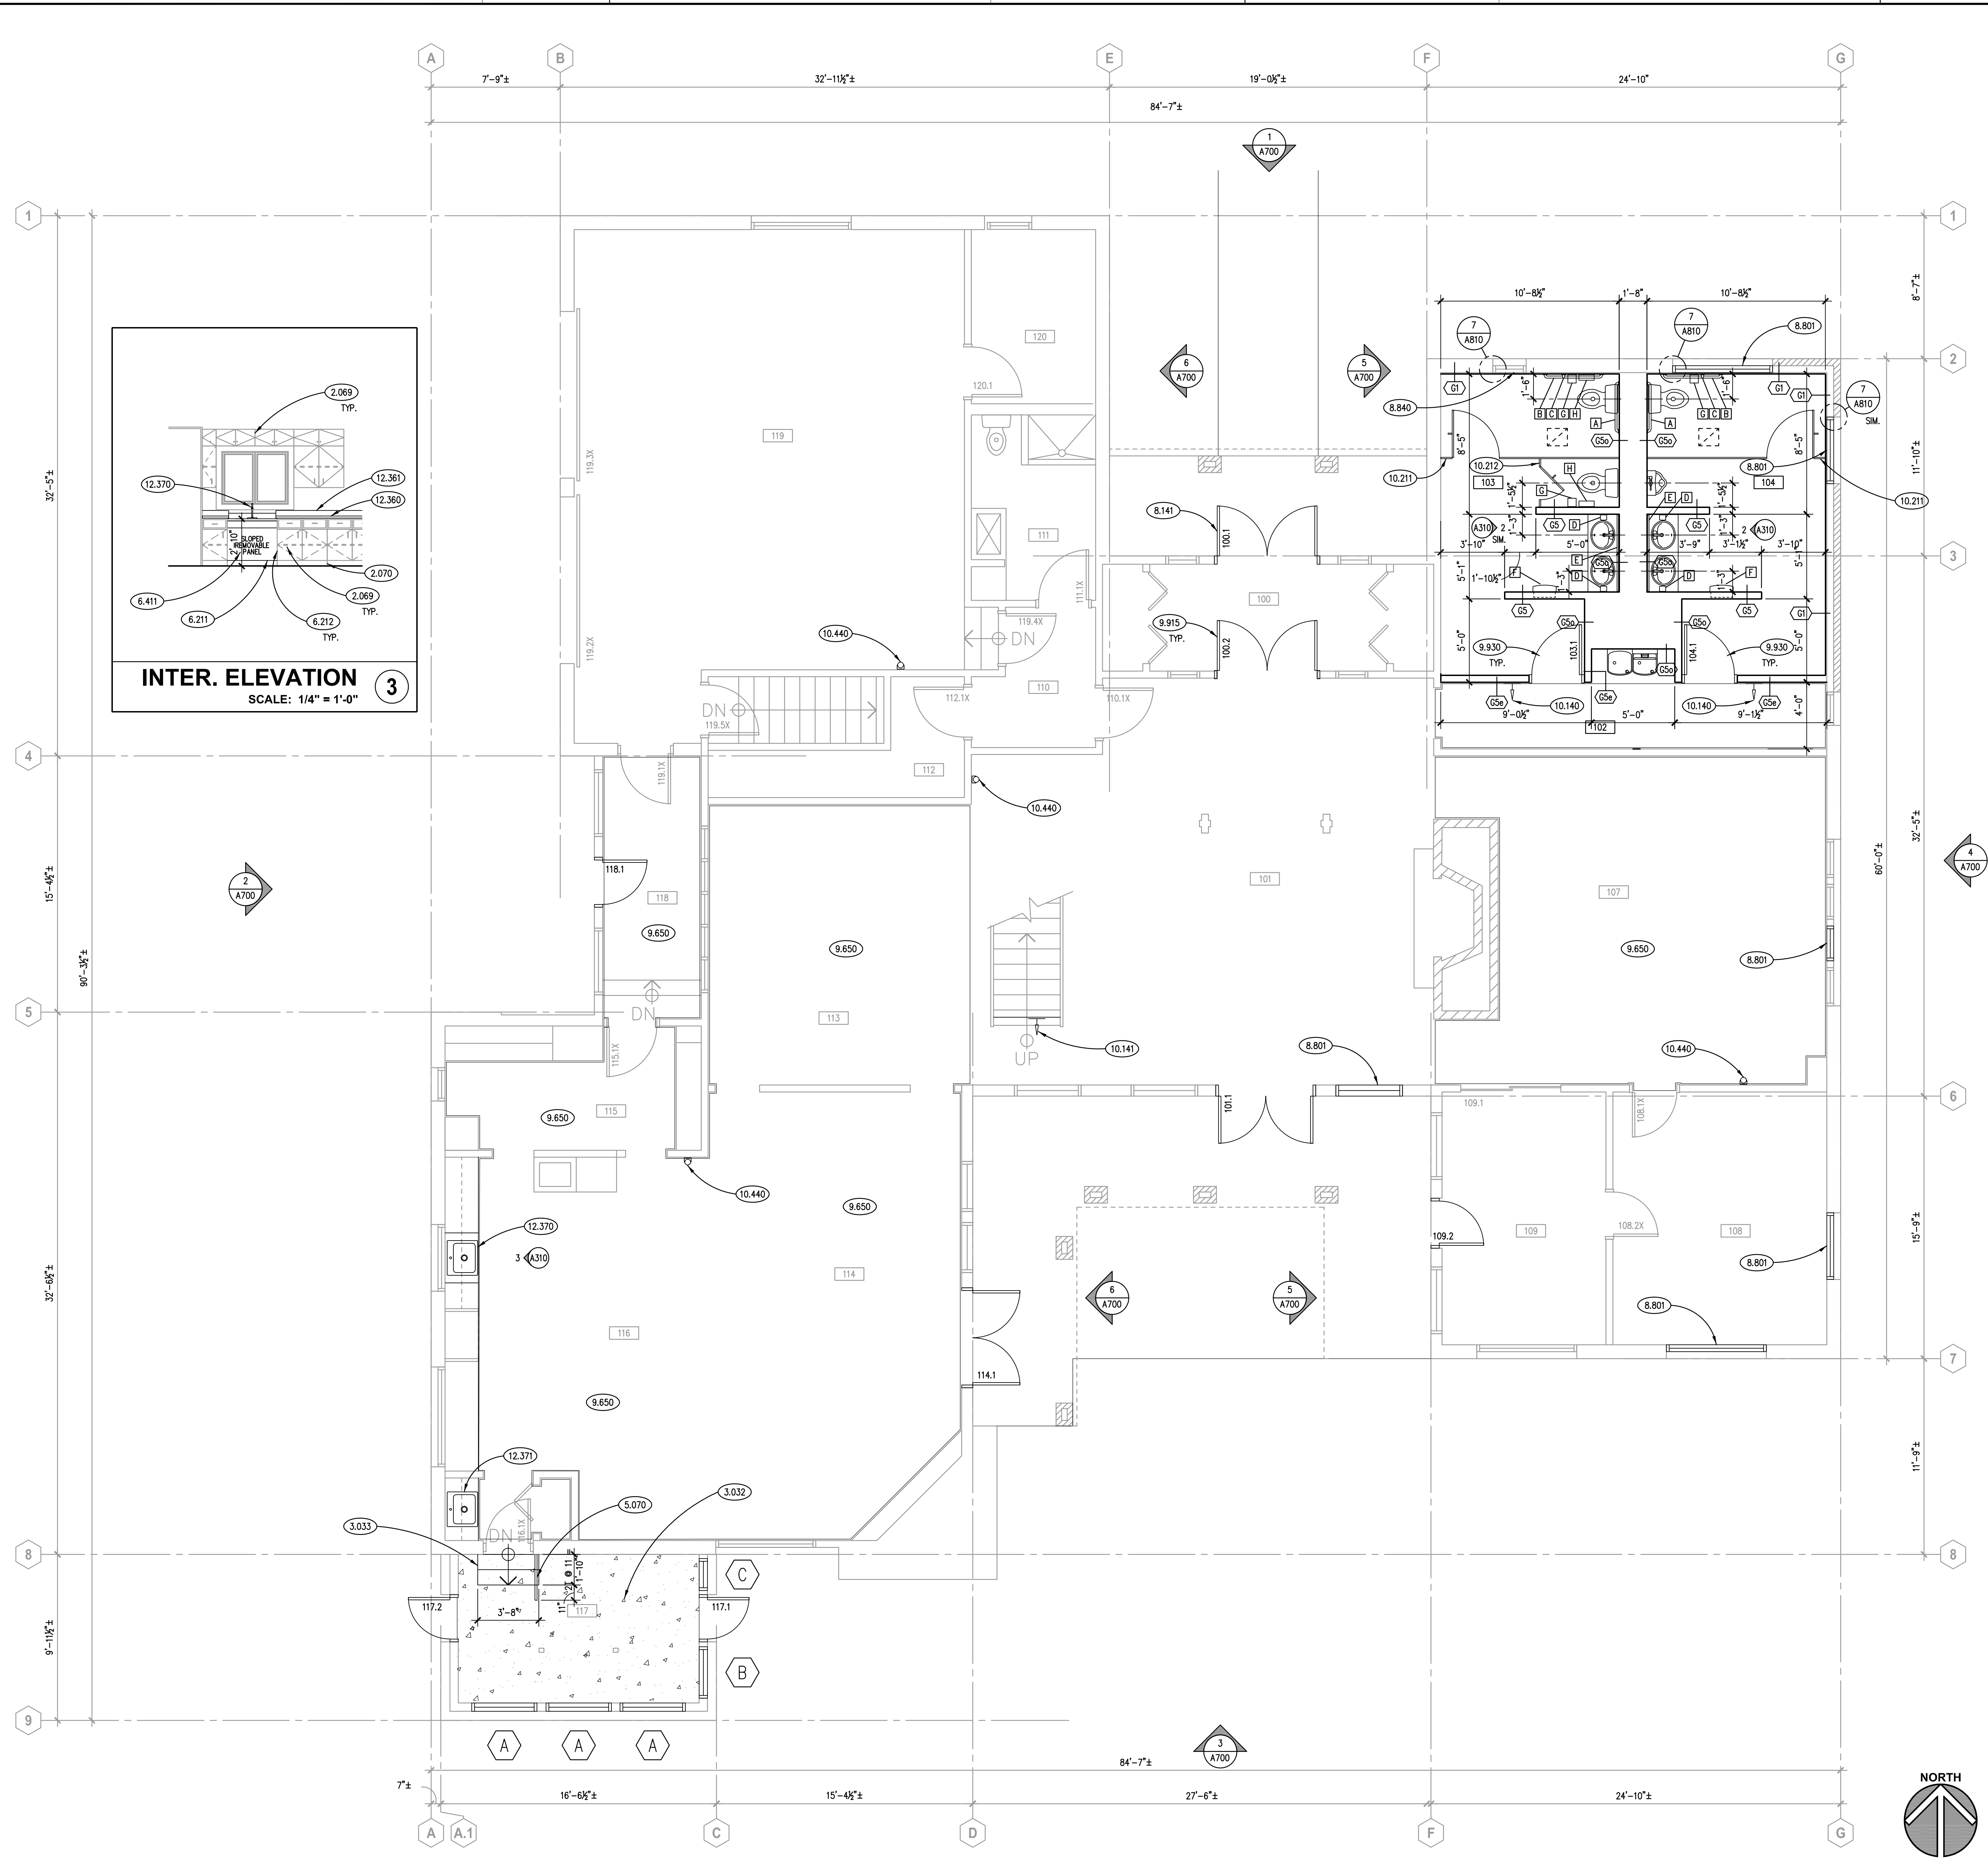


FIRST FLOOR PLAN
SCALE: 1/4" = 1'-0" ①

P:\1250 - Kendall County Forest Preserve - Pickerill Estate House Renovation\3D_Design\DWG\02-CDD10_Arch\1250A0310.dwg, 1/7/2022 4:12:03 PM, PJT

KEYNOTES


KEYNOTES ARE TYPICALLY NOT DUPLICATED WITHIN A GIVEN DETAIL. AN UN-KEYNOTED ITEM IN A DETAIL IS THE SAME AS A KEYNOTED ITEM HAVING THE SAME APPEARANCE WITHIN THE SAME DETAIL.

- 32.014 PRECAST CONCRETE UNIT PAVERS: PATTERN OF PAVERS AS SPECIFIED. REFER TO SPECIFICATIONS.
- 32.022 PRECAST CONCRETE DIMENSIONAL STONE SEAT WALL STONE BASE, MIN. 18 INCHES THICK.
- 32.025 PRE-MANUFACTURED CHIMNEY W/ WOOD BOX: REFER TO SPECIFICATIONS.

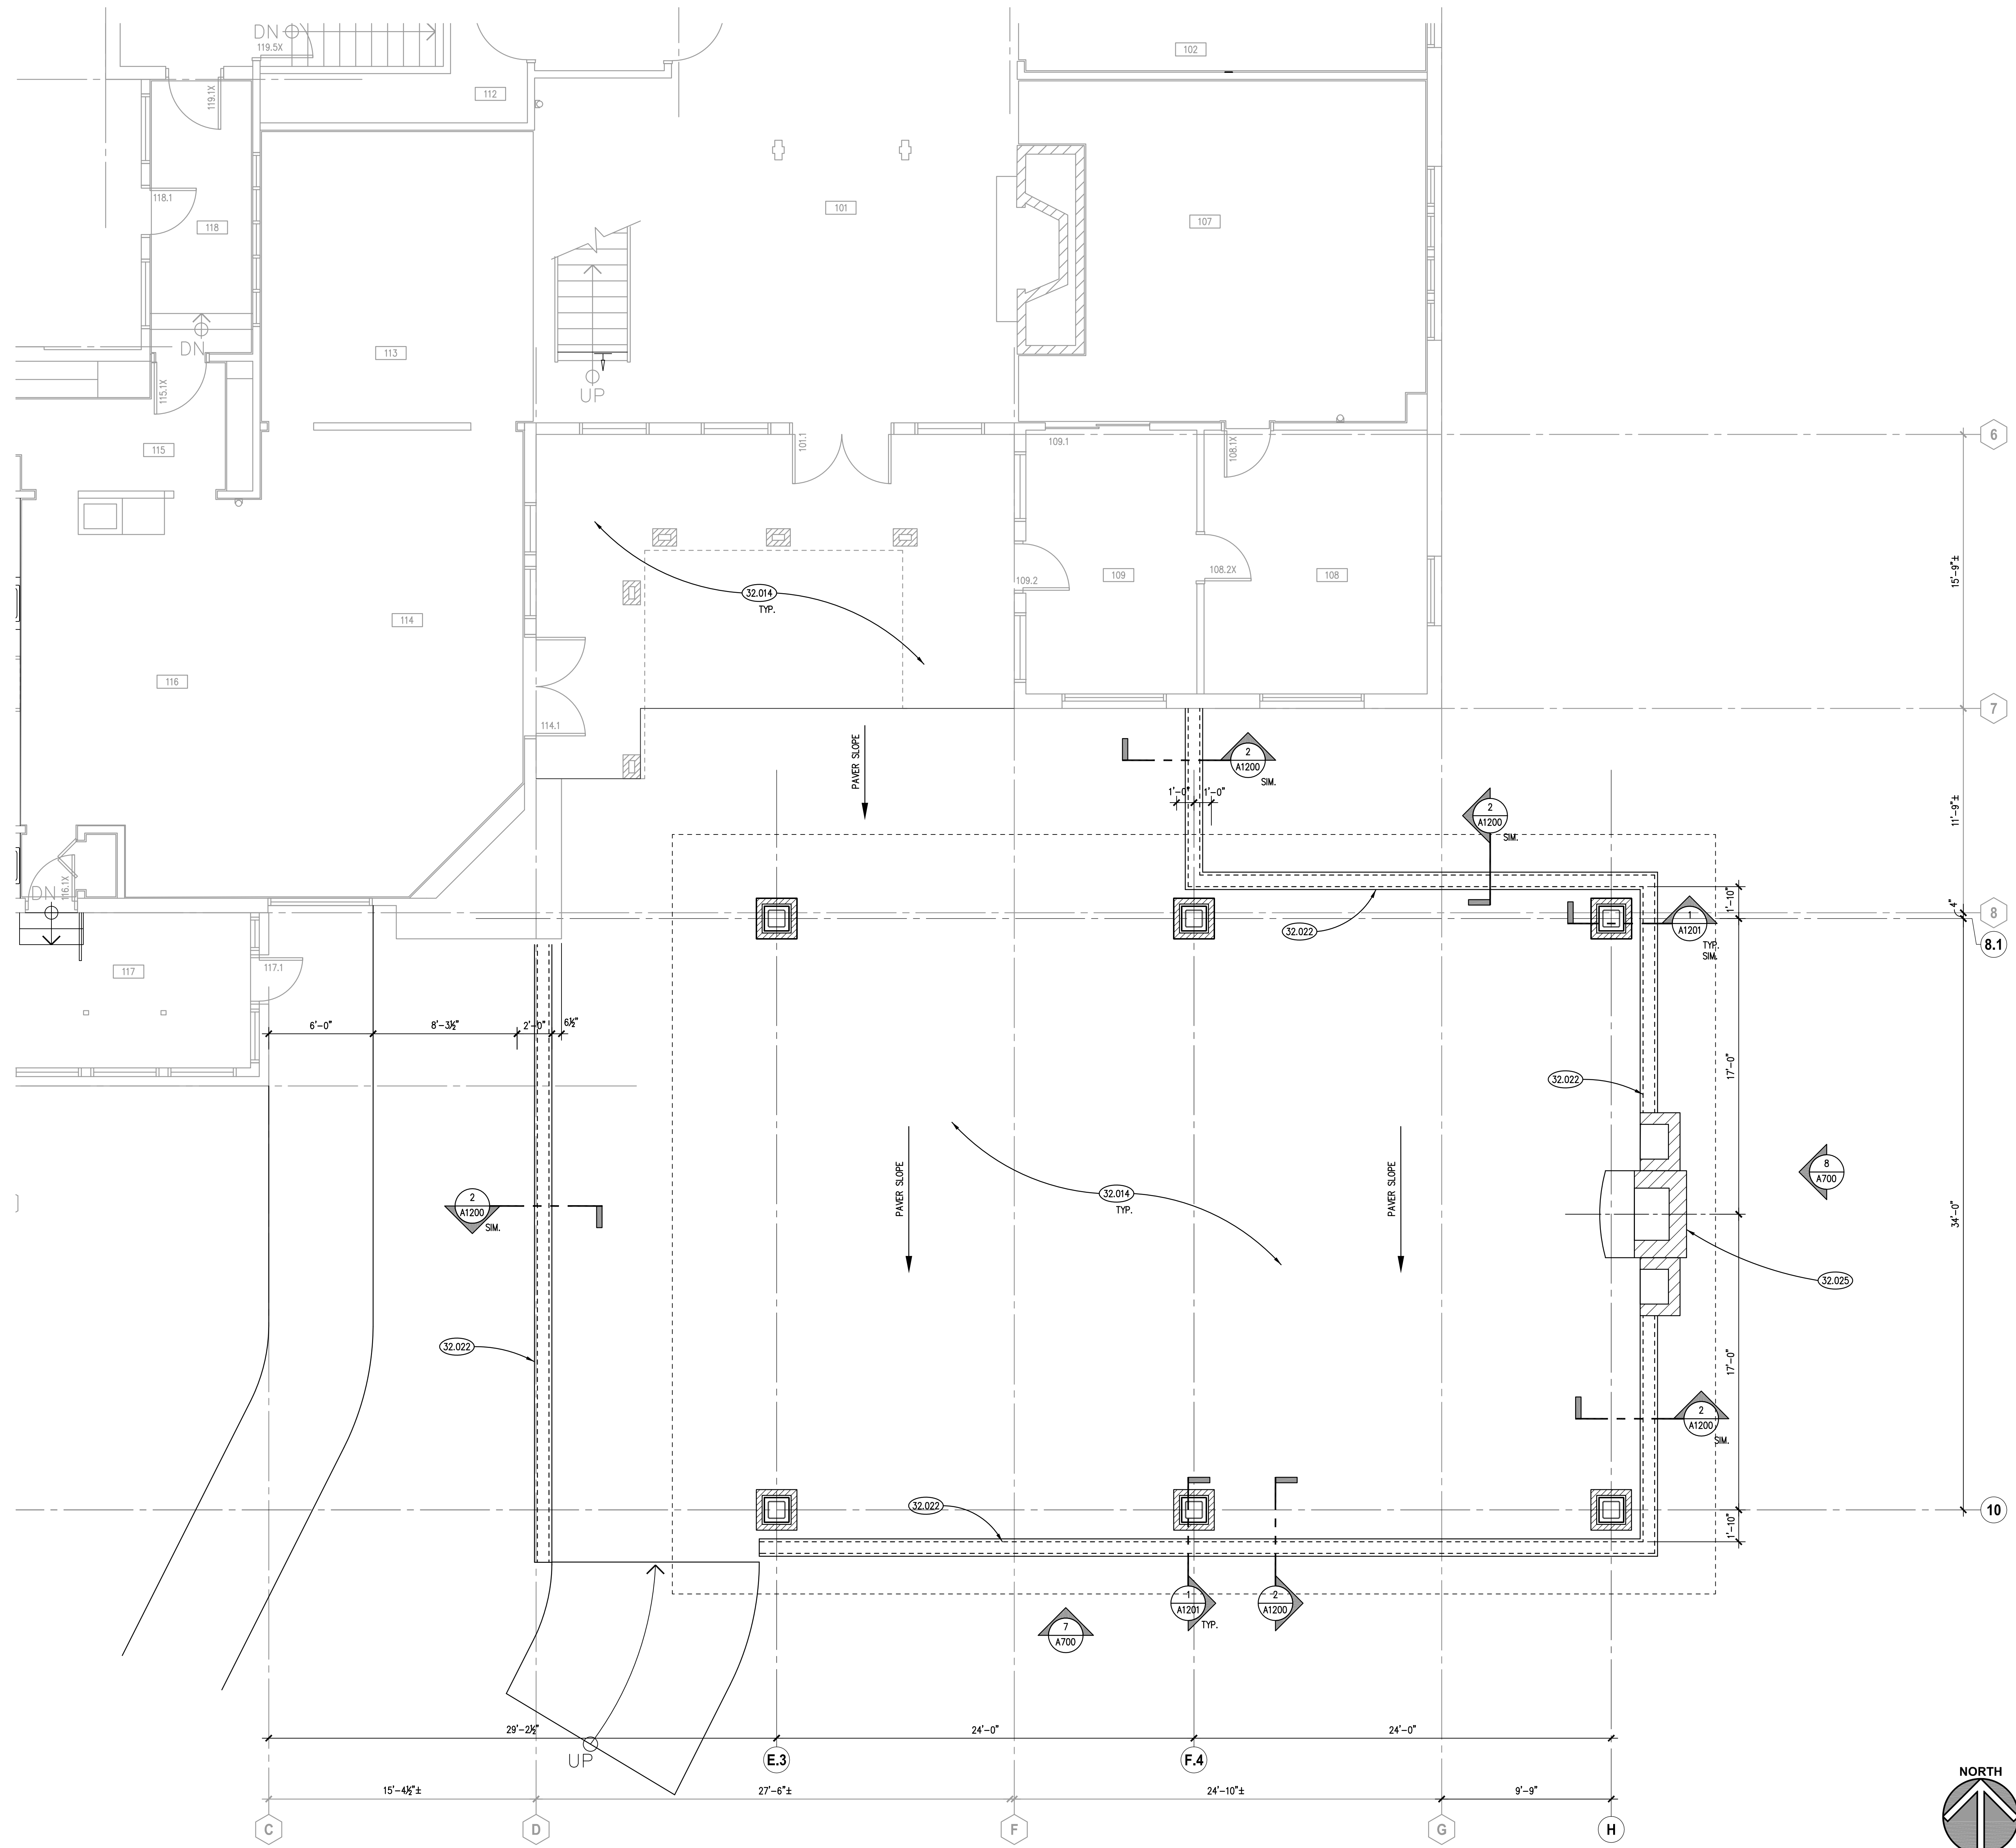

GENERAL NOTES

- 1. REFER TO DRAWING G100 FOR PROJECT GENERAL NOTES.

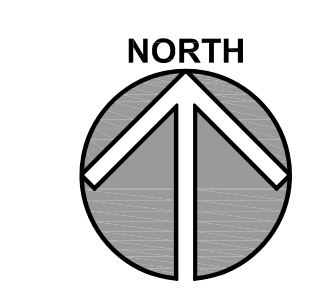

CANOPY & PATIO PLAN ①
SCALE: 1/4" = 1'-0"

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01/06/22	BID DOCUMENTS


JOB NO.	19-429-1250
DRAWN	PJT
CHECKED	CJH
APPROVED	CJH

SHEET TITLE
CANOPY & PATIO PLAN

SHEET NUMBER
A311

KEYNOTES

KEYNOTES ARE TYPICALLY NOT DUPLICATED WITHIN A GIVEN DETAIL. AN UN-KEYNOTED ITEM IN A DETAIL IS THE SAME AS A KEYNOTED ITEM HAVING THE SAME APPEARANCE WITHIN THE SAME DETAIL.

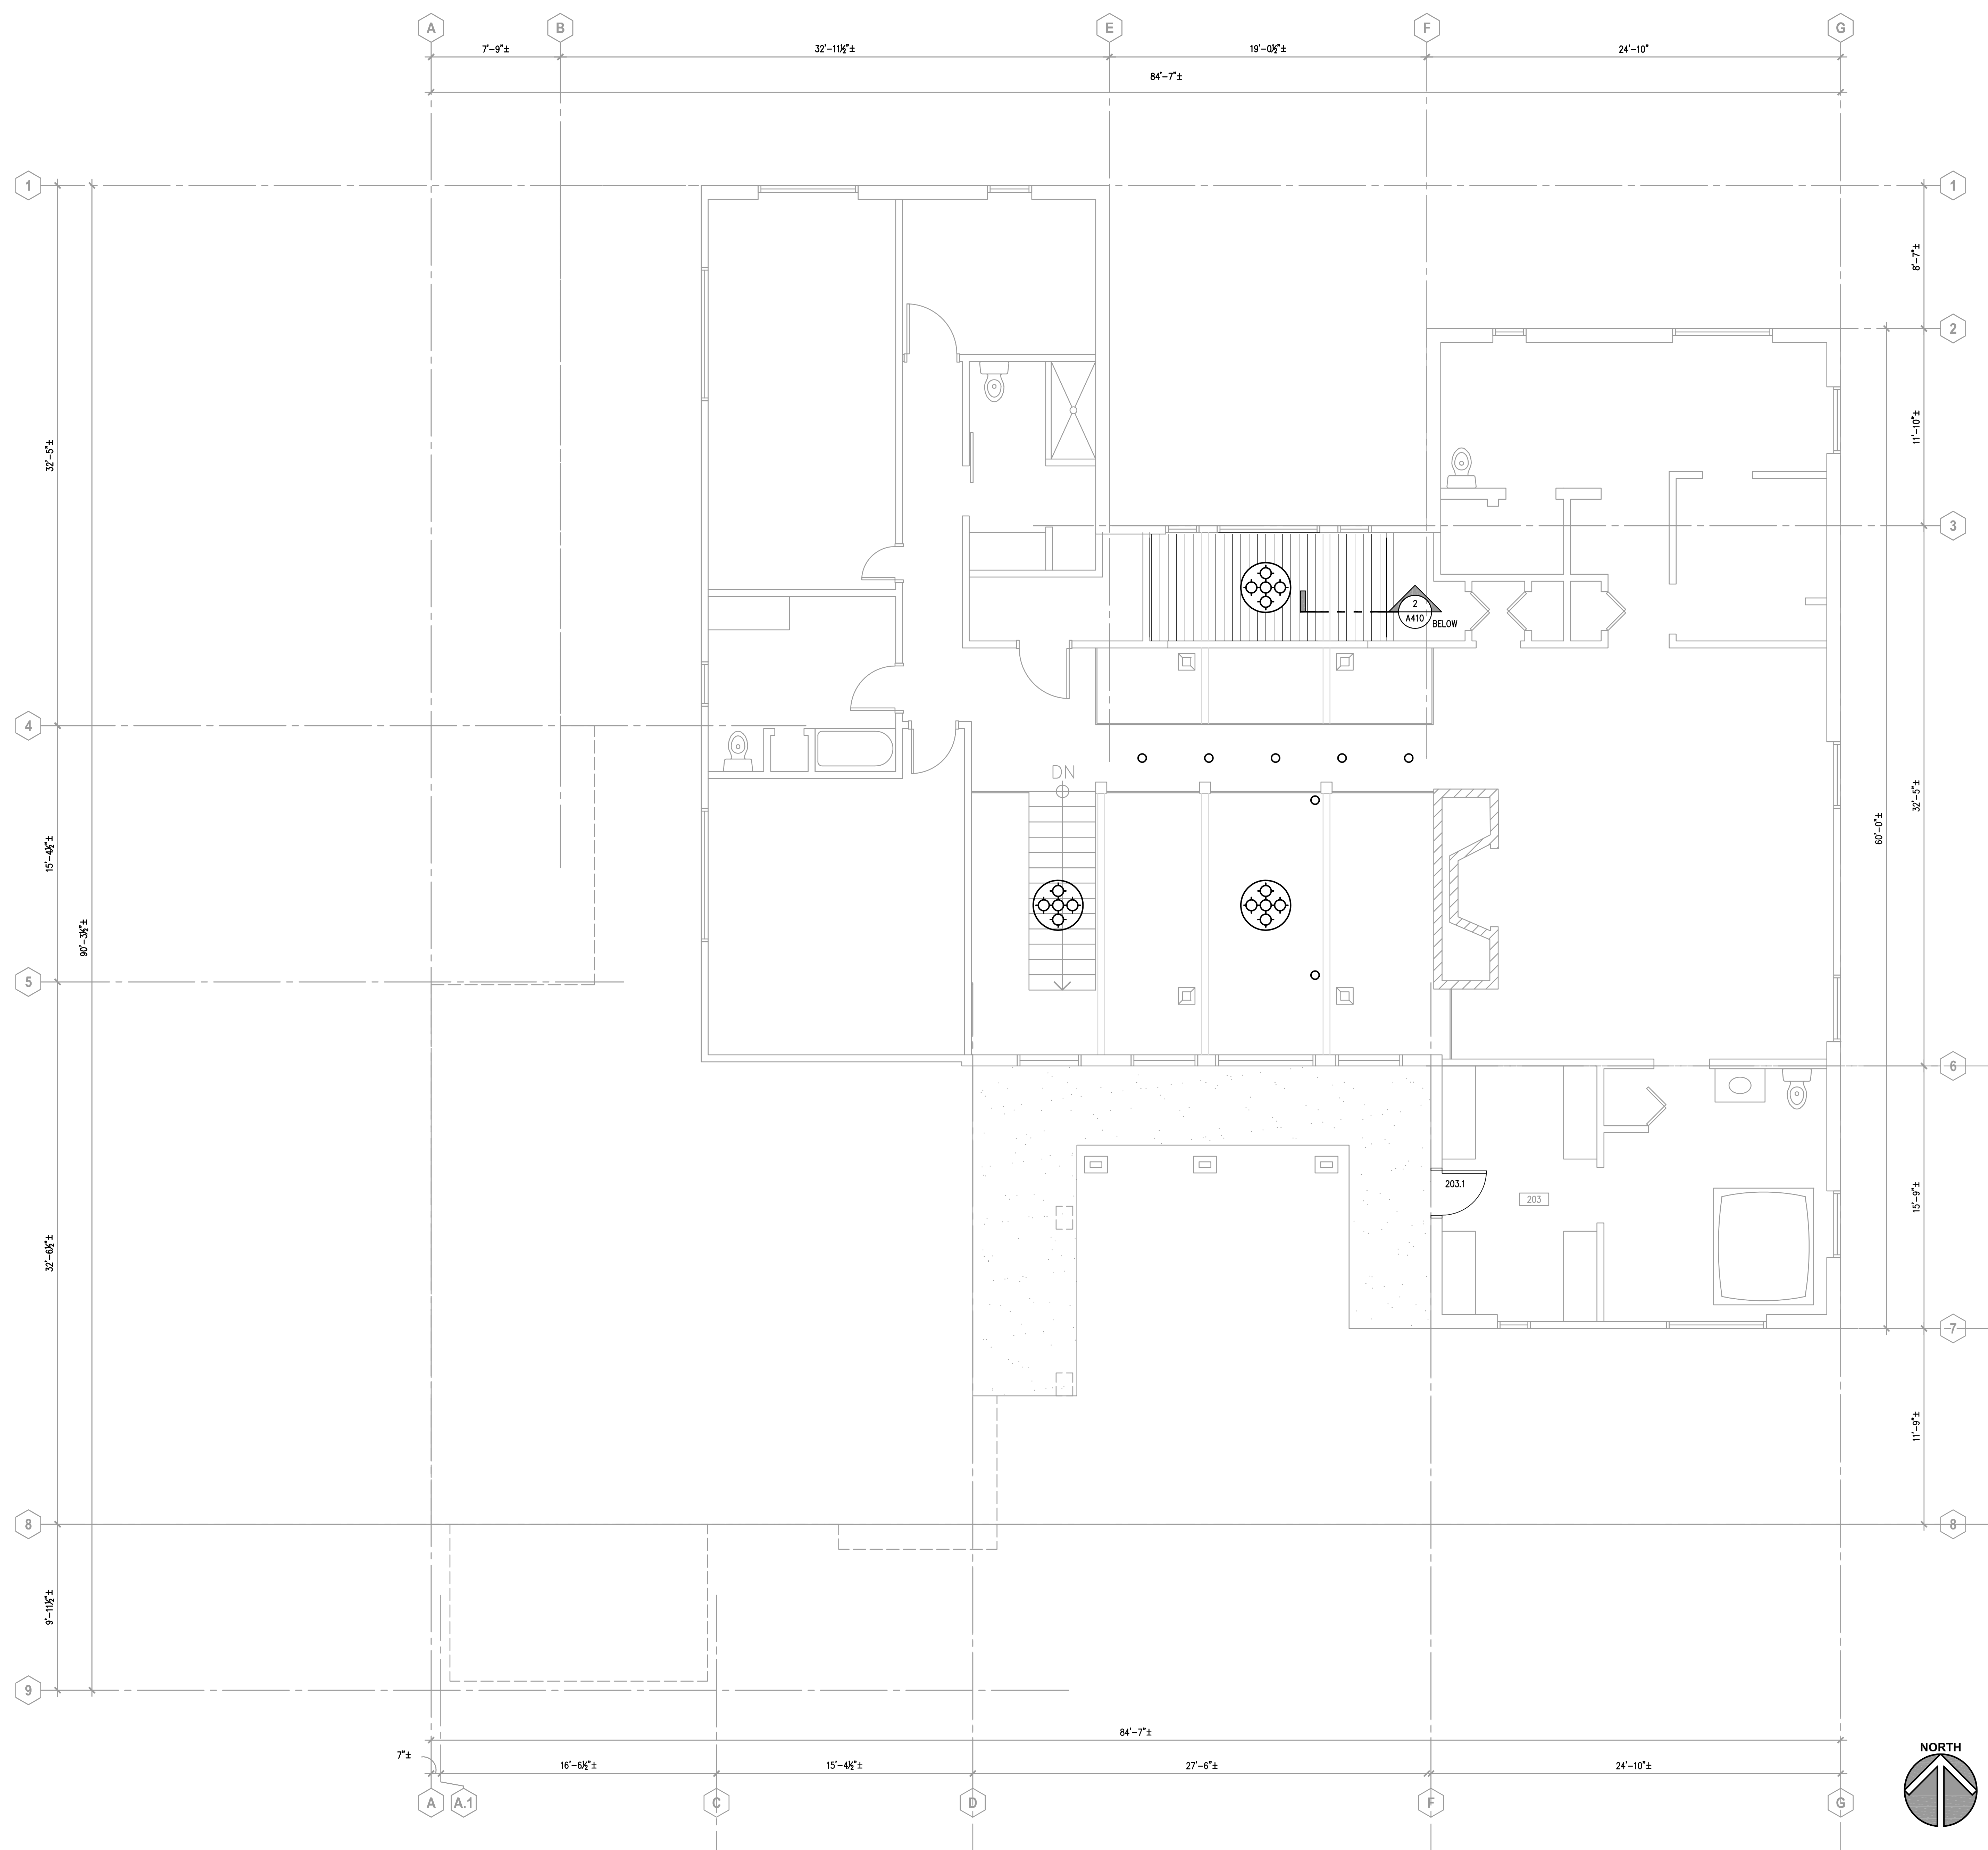

CEILING LEGEND

SYMBOL	DESCRIPTION	SYMBOL	DESCRIPTION
	GYP SUM BOARD		MECHANICAL DIFFUSER: SUPPLY
	ACOUSTICAL CEILING TILE: 2' X 2'		MECHANICAL DIFFUSER: RETURN
	TONGUE & GROOVE		MECHANICAL DIFFUSER: EXHAUST
			MECHANICAL DIFFUSER: LINEAR SUPPLY
			COMBINATION LIGHT/EXHAUST FAN
			LIGHT FIXTURE: 15.5" X 48"
			LIGHT FIXTURE: 24" X 24"
			LIGHT TRACK WITH FIXTURE HEADS
			LIGHT FIXTURE: INDUSTRIAL STRIP
	EXIT LIGHT FIXTURES		EMERGENCY LIGHT FIXTURES
	LIGHT FIXTURE		SPRINKLER HEADS A: PENDANT B: UPRIGHT C: CONCEALED D: SIDEWALL
			DOWN LIGHT FIXTURES A: SPOT B: DOWN C: WALL WASHER D: SCORCE

ROOM SCHEDULE

RM. NO.	ROOM NAME	RM. NO.	ROOM NAME
105	NOT USED	120	EXISTING STORAGE
106	NOT USED		
107	EXISTING LIVING ROOM		
108	EXISTING STORAGE		
109	EXISTING STORAGE		
110	EXISTING CORRIDOR	203.1	EXISTING CLOSET
111	EXISTING BATHROOM		
112	EXISTING JANITOR'S CLOSET		
113	EXISTING DINING ROOM		
114	EXISTING KEEPING ROOM		
115	EXISTING PANTRY		
116	EXISTING KITCHEN		
117	EXISTING GREEN HOUSE		
118	EXISTING FOYER		
119	EXISTING GARAGE		

GENERAL NOTES

1. REFER TO DRAWING G100 FOR PROJECT GENERAL NOTES.

SECOND FLOOR PLAN
SCALE: 1/4" = 1'-0"

ISSUED	
01/06/22	BID DOCUMENTS

JOB NO.	19-429-1250
DRAWN	SKF
CHECKED	CJH
APPROVED	CJH

SHEET TITLE


SECOND FLOOR PLAN

SHEET NUMBER

A320

KEYNOTES

- KEYNOTES ARE TYPICALLY NOT DUPLICATED WITHIN A GIVEN DETAIL. AN UN-KEYNOTED ITEM IN A DETAIL IS THE SAME AS A KEYNOTED ITEM HAVING THE SAME APPEARANCE WITHIN THE SAME DETAIL.
- 7.311 ASPHALT SHINGLES.
 - 7.530 ELASTOMERIC MEMBRANE ROOFING SYSTEM; FULLY ADHERED.
 - 7.535 ELASTOMERIC MEMBRANE ROOFING MATERIAL; RIGID INSULATION; TAPERED; 1/2" PER FOOT SLOPE U.N.O.
 - 7.631 METAL GUTTER; MATERIAL, THICKNESS AND FINISH AS SPECIFIED.
 - 7.632 METAL DOWNSPOUT; MATERIAL, THICKNESS AND FINISH AS SPECIFIED.
 - 23.301 MECHANICAL EQUIPMENT; REFER TO MECHANICAL DRAWINGS.
 - 23.741 MECHANICAL ROOFTOP UNIT ACCESSORY; ROOF CURB.
 - 23.742 MECHANICAL ROOFTOP UNIT ACCESSORY; ROOF RAIL.

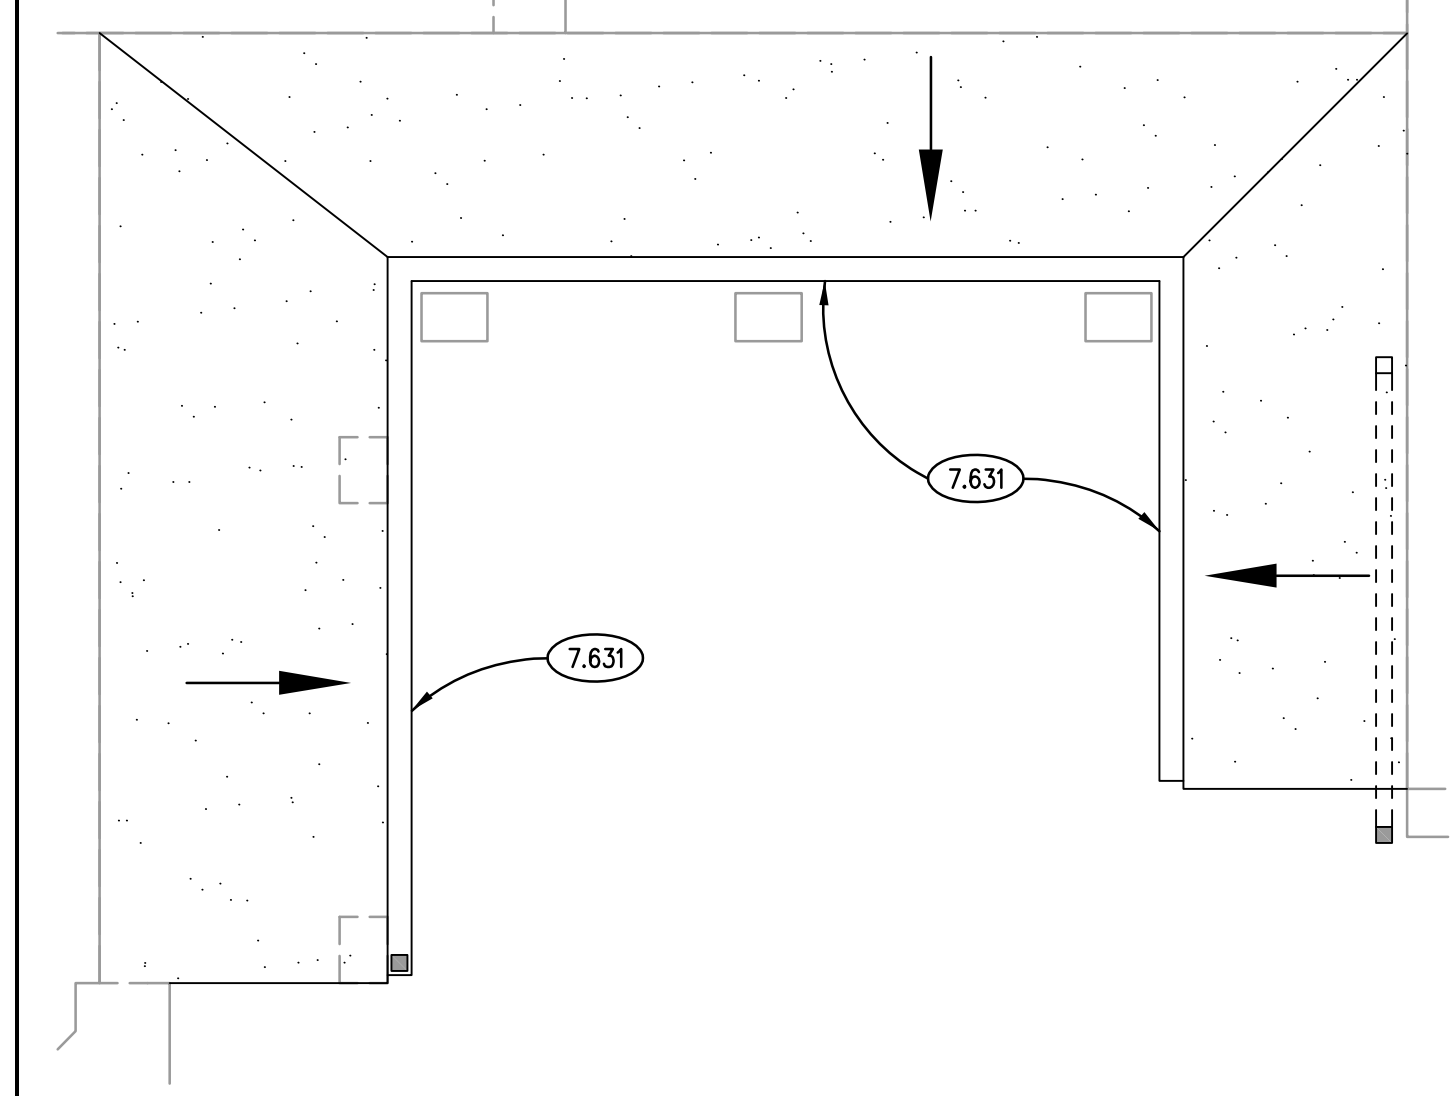


LOWER LEVEL ROOF PLAN
SCALE: 1/4" = 1'-0" ②

ROOF PLAN LEGEND


- 7.530
- 7.535
- 7.311
- DIRECTION OF WATER

GENERAL NOTES

1. REFER TO DRAWING G100 FOR PROJECT GENERAL NOTES.
2. GENERAL TRADES CONTRACTOR PROVIDE CARPENTER-BUILT CURBS AND RAILS FOR MECHANICAL UNITS AND DUCTWORK SHOWN ON THIS DRAWING AND ON MECHANICAL DRAWINGS EXCEPT WHERE MECHANICAL UNITS ARE PROVIDED WITH PREFABRICATED ROOF CURBS BY MECHANICAL UNIT MANUFACTURER.
3. ROOFING CONTRACTOR PROVIDE BOOTED ROOF PORTALS FOR ELECTRICAL CONDUIT, REFRIGERATION PIPING, GAS PIPING, CONDENSATE PIPING, AND HYDRONIC PIPING OUTSIDE ROOF CURBS TO MECHANICAL UNITS AND REMOTE CONDENSER UNITS. COORDINATE WITH MECHANICAL DRAWINGS AND KITCHEN EQUIPMENT DRAWINGS.
4. ROOFING CONTRACTOR PROVIDE STACK BOOTS ON MECHANICAL AND PLUMBING VENTS.
5. BID A IS DENOTED AS "BID A" IN THE INDIVIDUAL KEYNOTES ON THIS SHEET. IF "BID A" IS NOT INCLUDED WITH AN INDIVIDUAL KEYNOTE THEN CONTRACTOR SHALL BID WORK AS BID B.

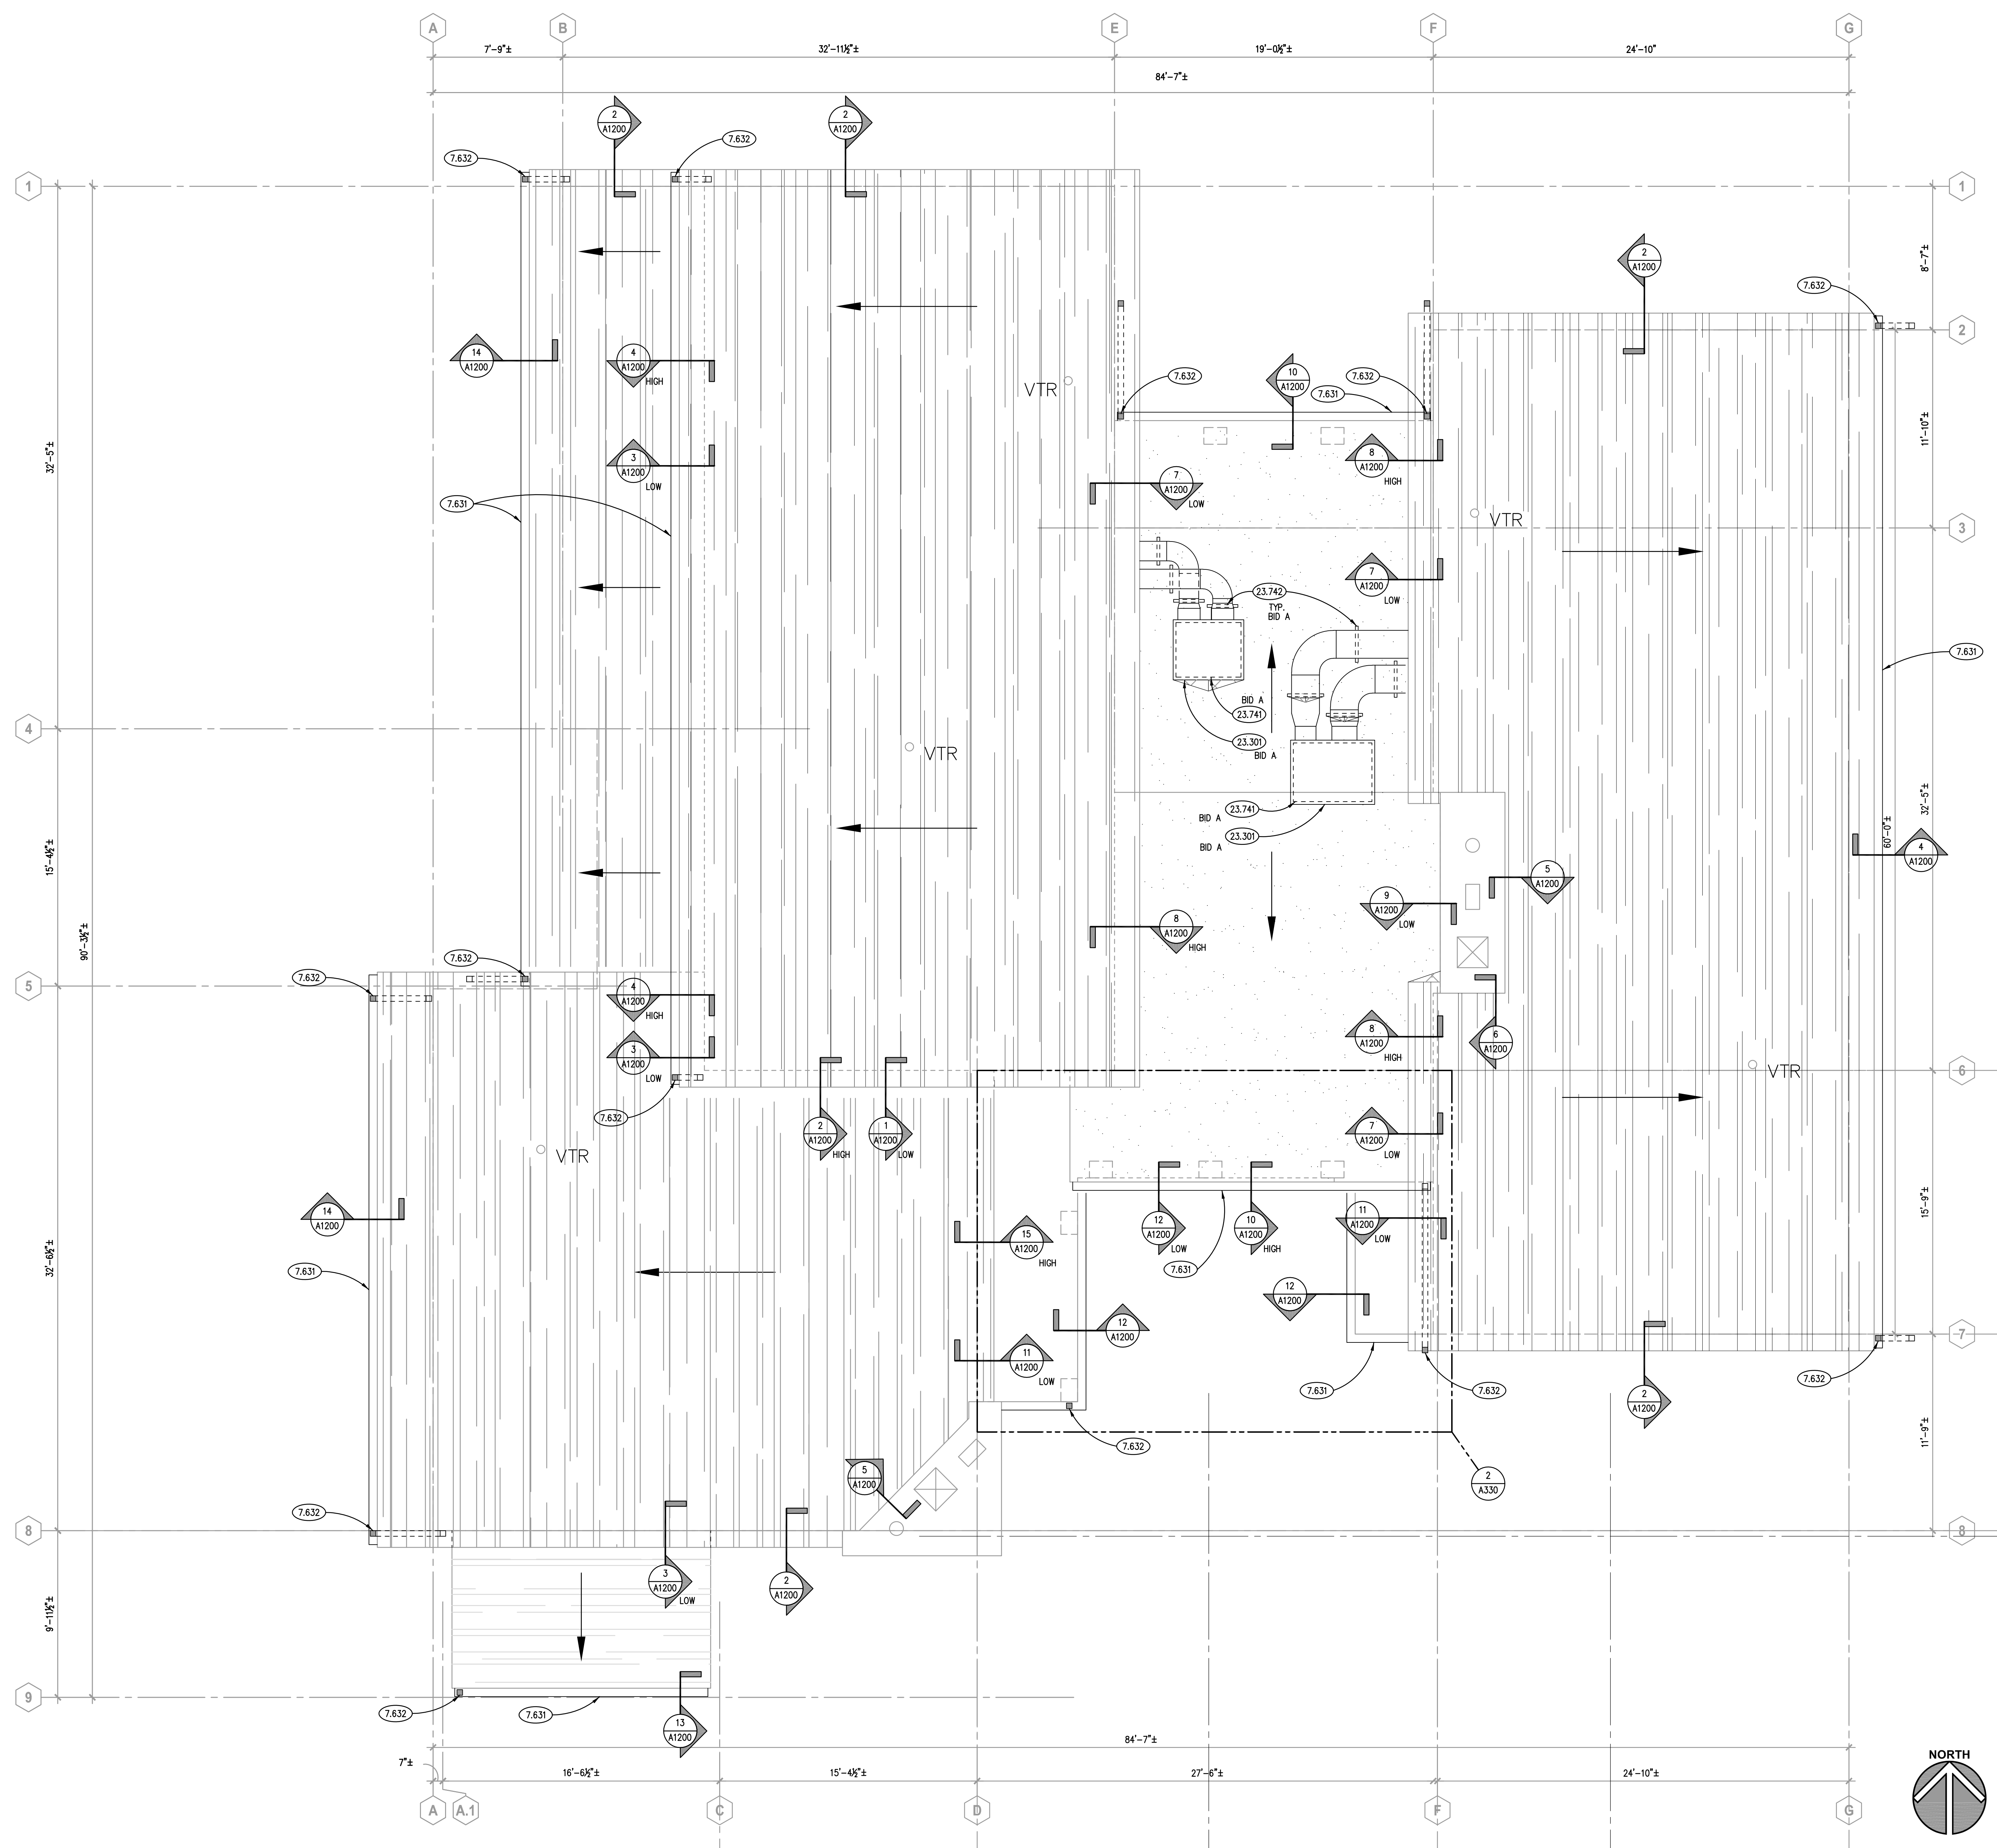

ROOF PLAN
SCALE: 1/4" = 1'-0" ①

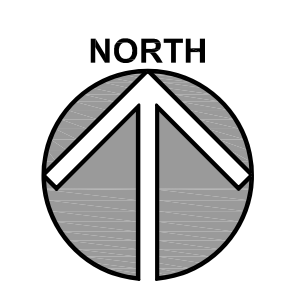

ISSUED	
01/09/22	BID DOCUMENTS

JOB NO.	19-429-1250
DRAWN	PJT
CHECKED	CJH
APPROVED	CJH

SHEET TITLE	ROOF PLAN
SHEET NUMBER	A330

A330

KEYNOTES


KEYNOTES ARE TYPICALLY NOT DUPLICATED WITHIN A GIVEN DETAIL. AN UN-KEYNOTED ITEM IN A DETAIL IS THE SAME AS A KEYNOTED ITEM HAVING THE SAME APPEARANCE WITHIN THE SAME DETAIL.

7.311 ASPHALT SHINGLES.

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CANOPY ROOF PLAN 1
SCALE: 1/4" = 1'-0"

GENERAL NOTES

1. REFER TO DRAWING G100 FOR PROJECT GENERAL NOTES.

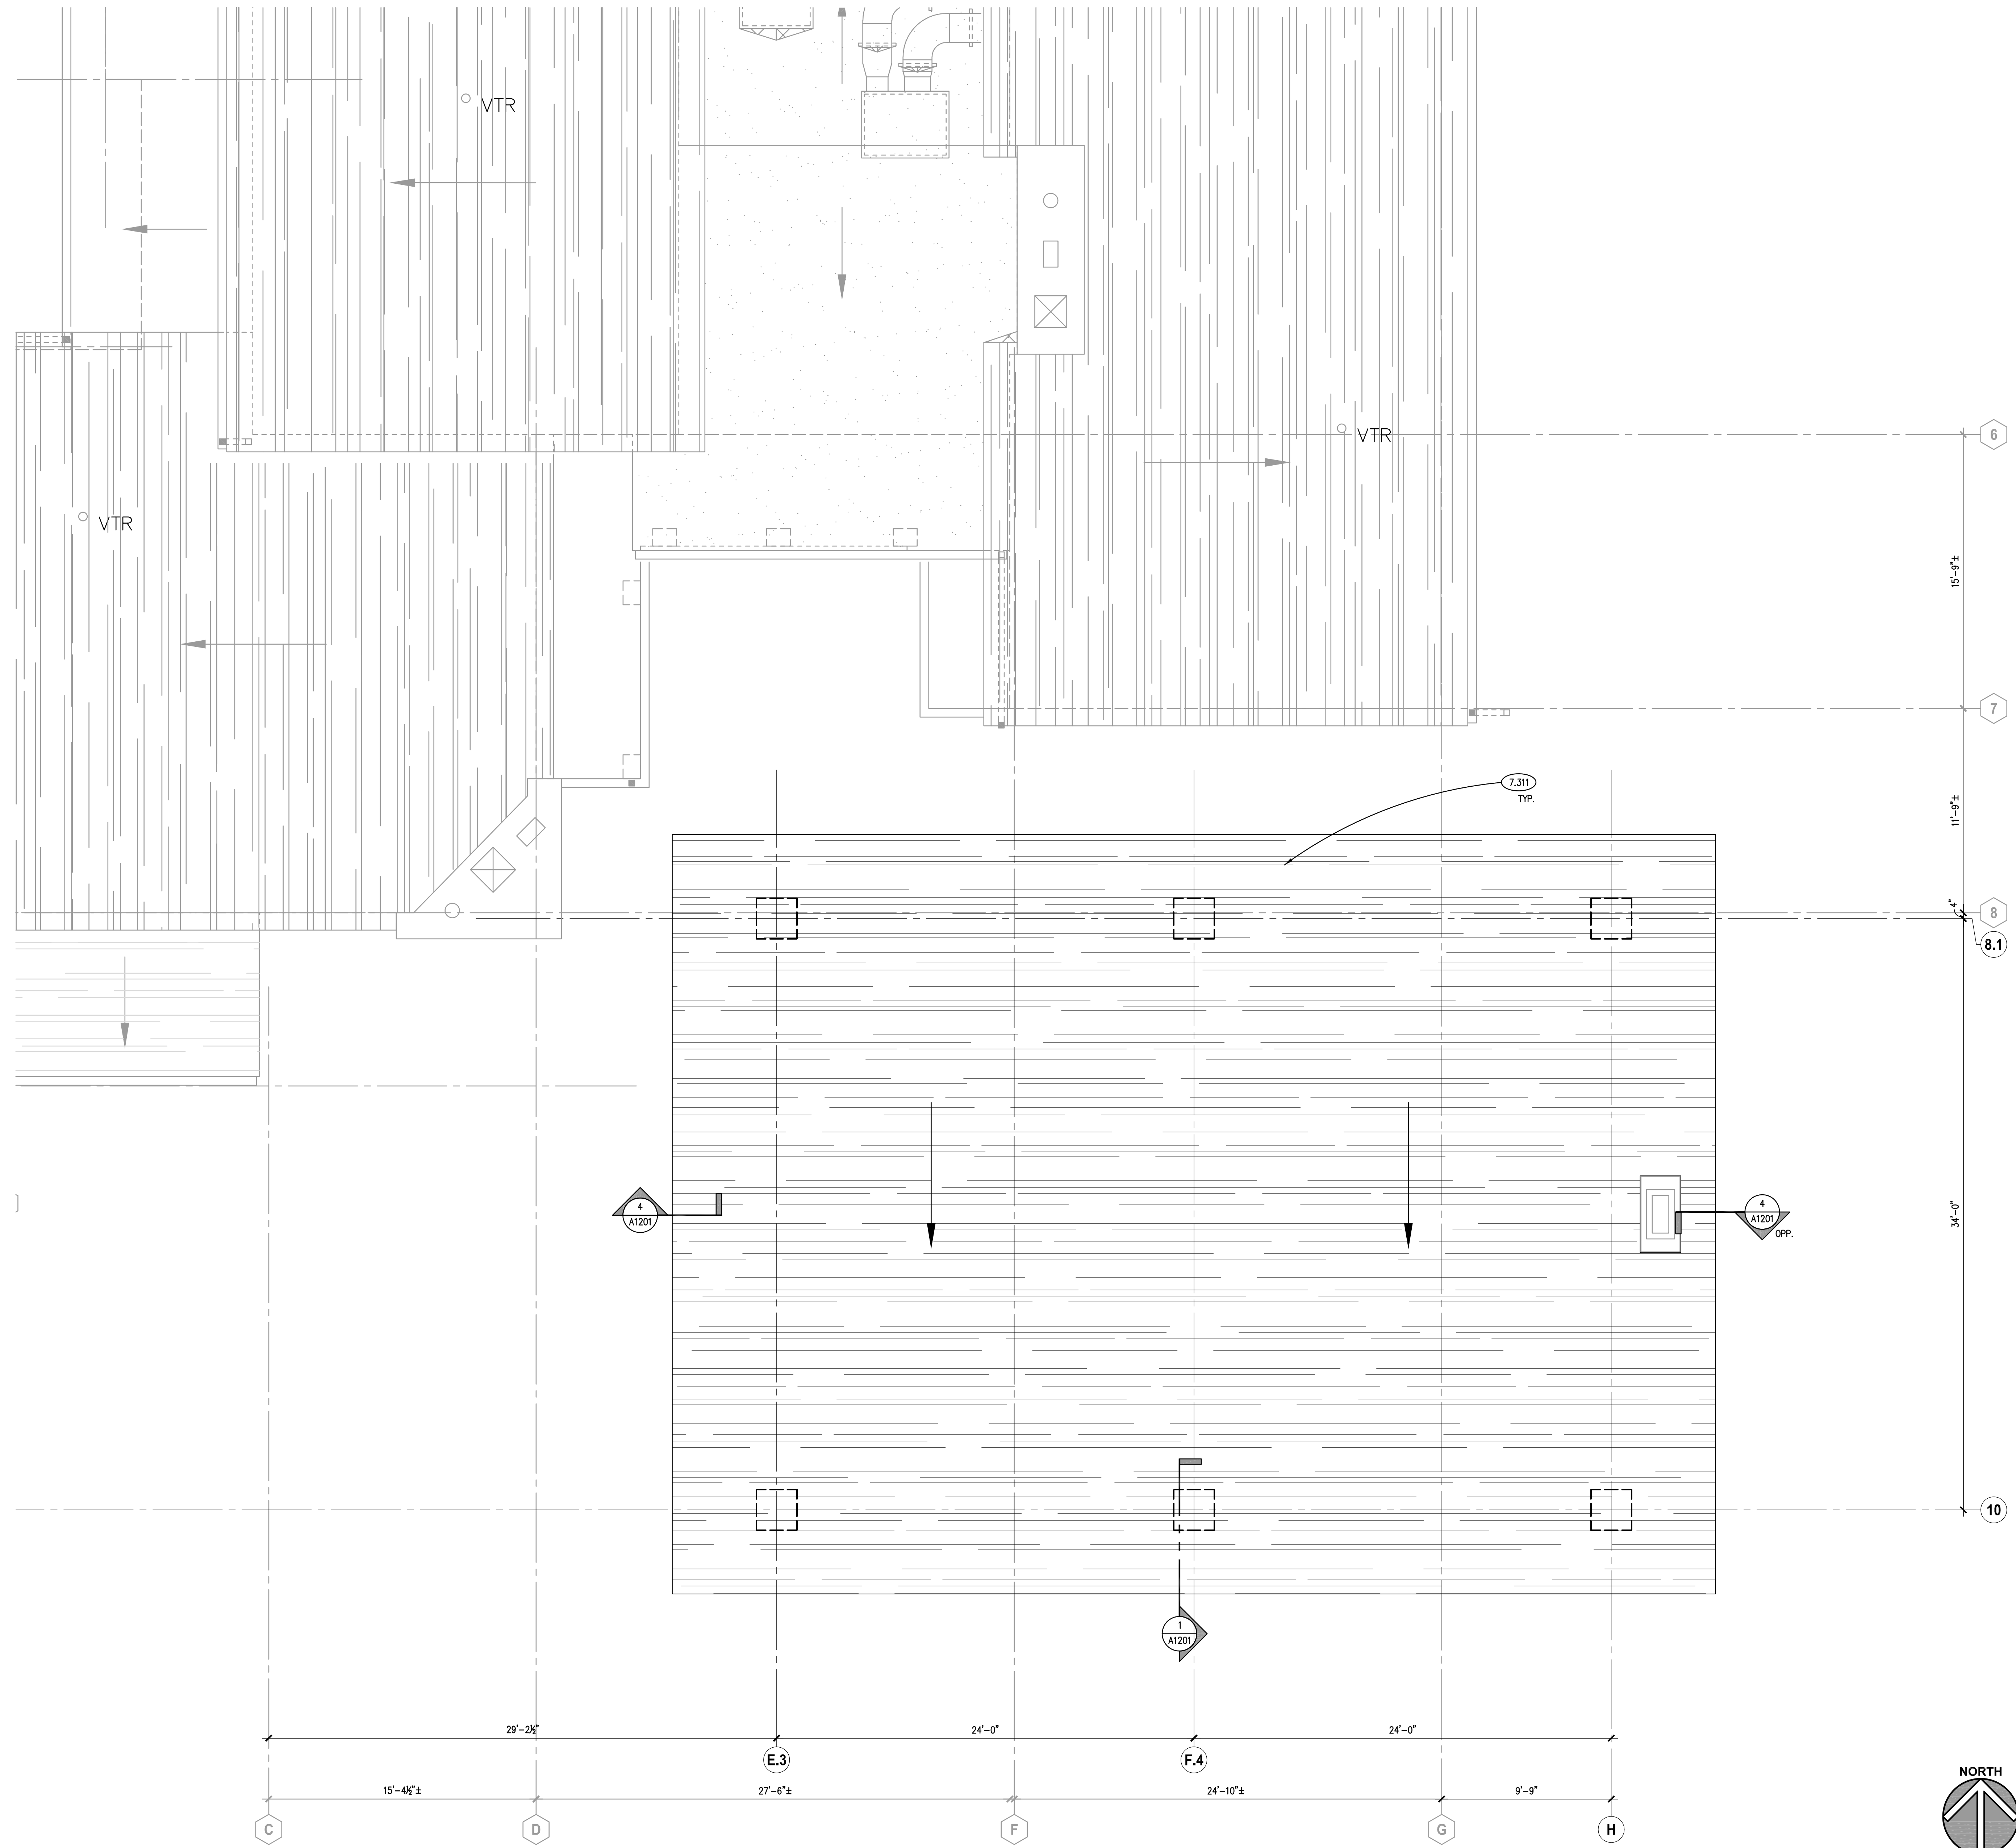ISSUED	
01/06/22	BIB DOCUMENTS

JOB NO.	19-429-1250
DRAWN	PJT
CHECKED	CJH
APPROVED	CJH

SHEET TITLE

CANOPY ROOF PLAN

SHEET NUMBER

A331

KEYNOTES

- KEYNOTES ARE TYPICALLY NOT DUPLICATED WITHIN A GIVEN DETAIL. AN UN-KEYNOTED ITEM IN A DETAIL IS THE SAME AS A KEYNOTED ITEM HAVING THE SAME APPEARANCE WITHIN THE SAME DETAIL.
- 2.059 EXISTING WOOD PANELING.
 - 2.060 EXISTING 2 BY WOOD STUD.
 - 2.067 EXISTING WOOD BEAM.
 - 6.001 ROUGH CARPENTRY: WOOD BLOCKING; DIMENSIONAL LUMBER; SIZE AS INDICATED; REFER TO SCHEDULE FOR TREATMENT.
 - 6.171 WOOD FRAMING ACCESSORY: LIGHT GAUGE WOOD CONSTRUCTION CONNECTOR AS NOTED MANUFACTURED BY SIMPSON STRONG-TIE OR EQUAL. INSTALL PER MANUFACTURER'S RECOMMENDATIONS. PROVIDE NAIL TYPE AND QUANTITIES RESULTING IN THE MAXIMUM TABULATED CAPACITIES.
 - 6.210 FINISH CARPENTRY: 1 X 6 TONGUE & GROOVE SOFFIT MATERIALS; REFER TO SPECIFICATIONS.

CEILING LEGEND


SYMBOL	DESCRIPTION	SYMBOL	DESCRIPTION
	GYPHUM BOARD		MECHANICAL DIFFUSER: SUPPLY
	ACOUSTICAL CEILING TILE: 2' X 2'		MECHANICAL DIFFUSER: RETURN
	TONGUE & GROOVE		MECHANICAL DIFFUSER: EXHAUST
			MECHANICAL DIFFUSER: LINEAR SUPPLY
			COMBINATION LIGHT/EXHAUST FAN
			LIGHT FIXTURE: 15.5" X 48"
			LIGHT FIXTURE: 24" X 24"
			LIGHT TRACK WITH FIXTURE HEADS
			LIGHT FIXTURE: INDUSTRIAL STRIP
	EXIT LIGHT FIXTURES		EMERGENCY LIGHT FIXTURES
	LIGHT FIXTURE		SPRINKLER HEADS A: PENDANT B: UPRIGHT C: CONCEALED D: SIDEWALL
			DOWN LIGHT FIXTURES A: SPOT B: DOWN C: WALL WASHER D: SCORCE

ROOM SCHEDULE


RM. NO.	ROOM NAME	RM. NO.	ROOM NAME
100	EXISTING FOYER		
101	EXISTING FORMAL PARLOR		
102	CORRIDOR		
103	WOMEN'S BATHROOM		
104	MEN'S BATHROOM		
105	NOT USED		
106	EXISTING LIVING ROOM		
107	EXISTING STORAGE		
108	EXISTING STORAGE		
109	EXISTING STORAGE		
110	EXISTING CORRIDOR		
111	EXISTING BATHROOM		
112	EXISTING JANITOR'S CLOSET		
113	EXISTING DINING ROOM		
114	EXISTING KEEPING ROOM		
115	EXISTING PANTRY		
116	EXISTING KITCHEN		
117	EXISTING GREEN HOUSE		
118	EXISTING FOYER		
119	EXISTING GARAGE		
120	EXISTING STORAGE		

GENERAL NOTES

- REFER TO DRAWING G100 FOR PROJECT GENERAL NOTES.
- COORDINATE FIRE RATED ASSEMBLIES INFORMATION CONTAINED ON DRAWING _____ WITH THE WORK OF ALL CONTRACTS.
- SPOT ELEVATIONS ARE DESIGNATED NOMINAL HEIGHTS ABOVE FINISHED FLOOR UNLESS NOTED OTHERWISE. COORDINATE FINAL HEIGHTS OF CEILING ELEMENTS WITH INFORMATION CONTAINED ON STRUCTURAL, MECHANICAL, PLUMBING, FIRE PROTECTION AND ELECTRICAL DRAWINGS.
- PROVIDE GYPSUM BOARD HEADERS TO FORM VERTICAL SOFFITS AT CHANGES OF ACOUSTICAL CEILING HEIGHTS UNLESS NOTED OR DETAILED OTHERWISE.

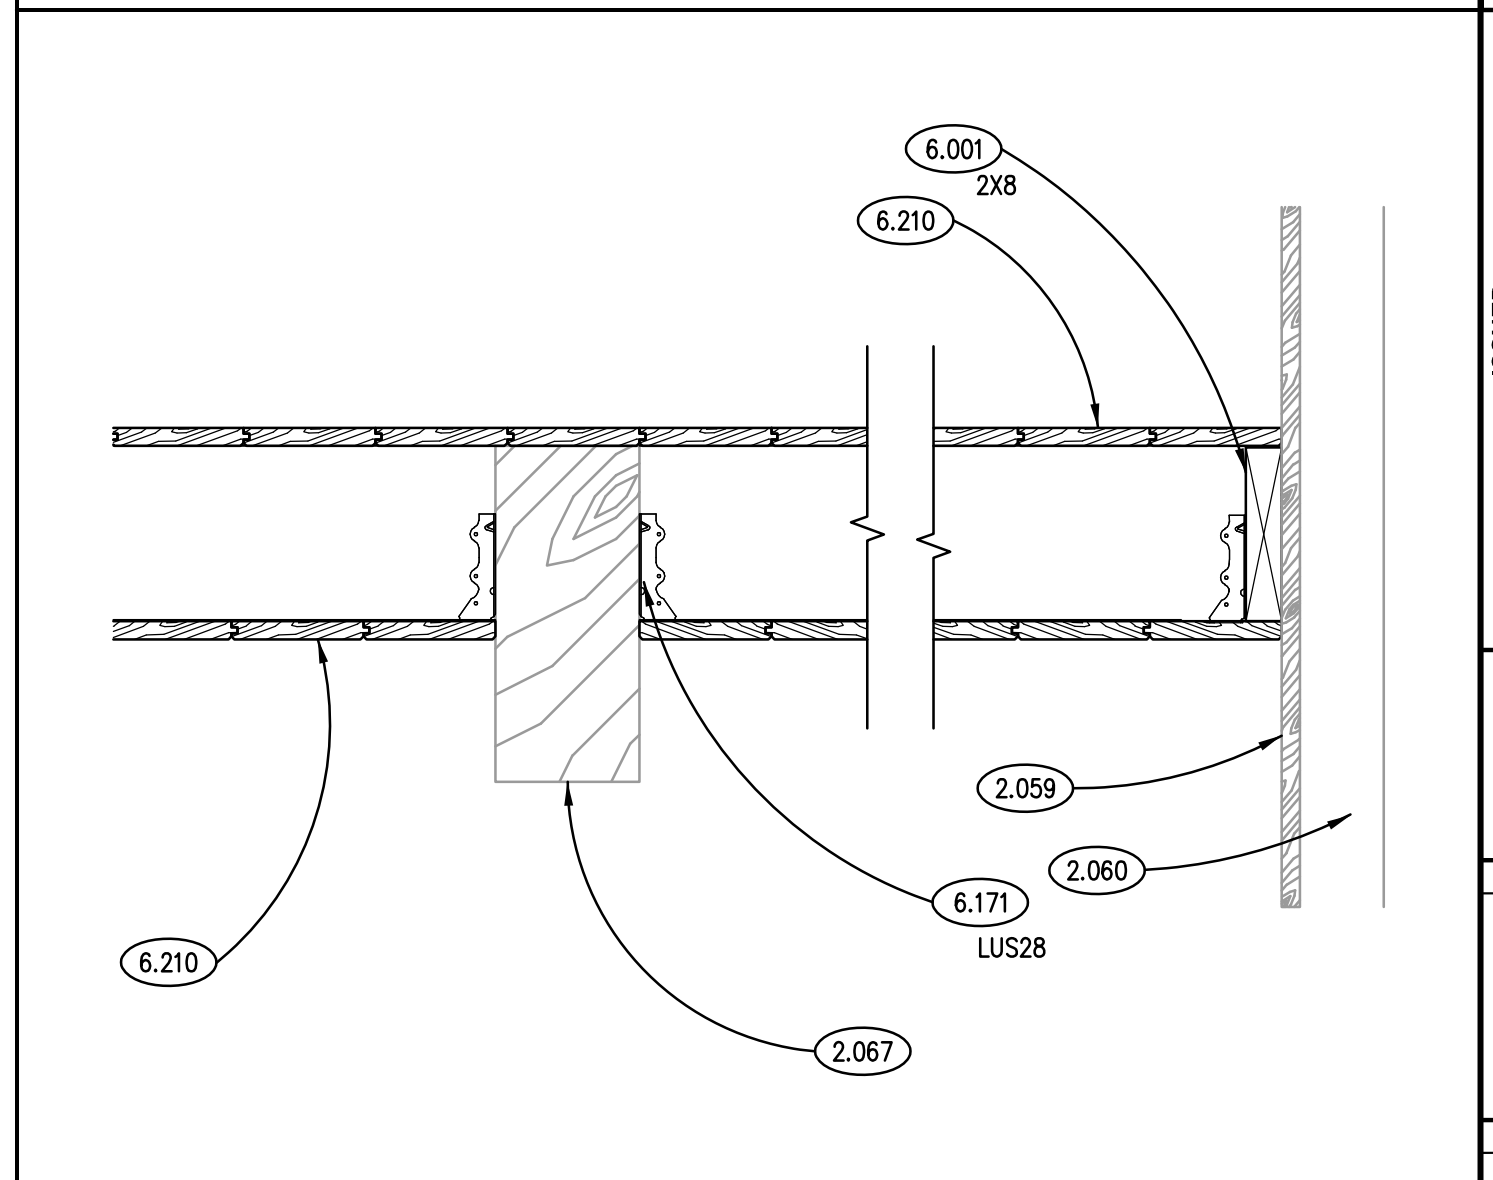

CEILING SECTION DETAIL
SCALE: 1/2" = 1'-0"

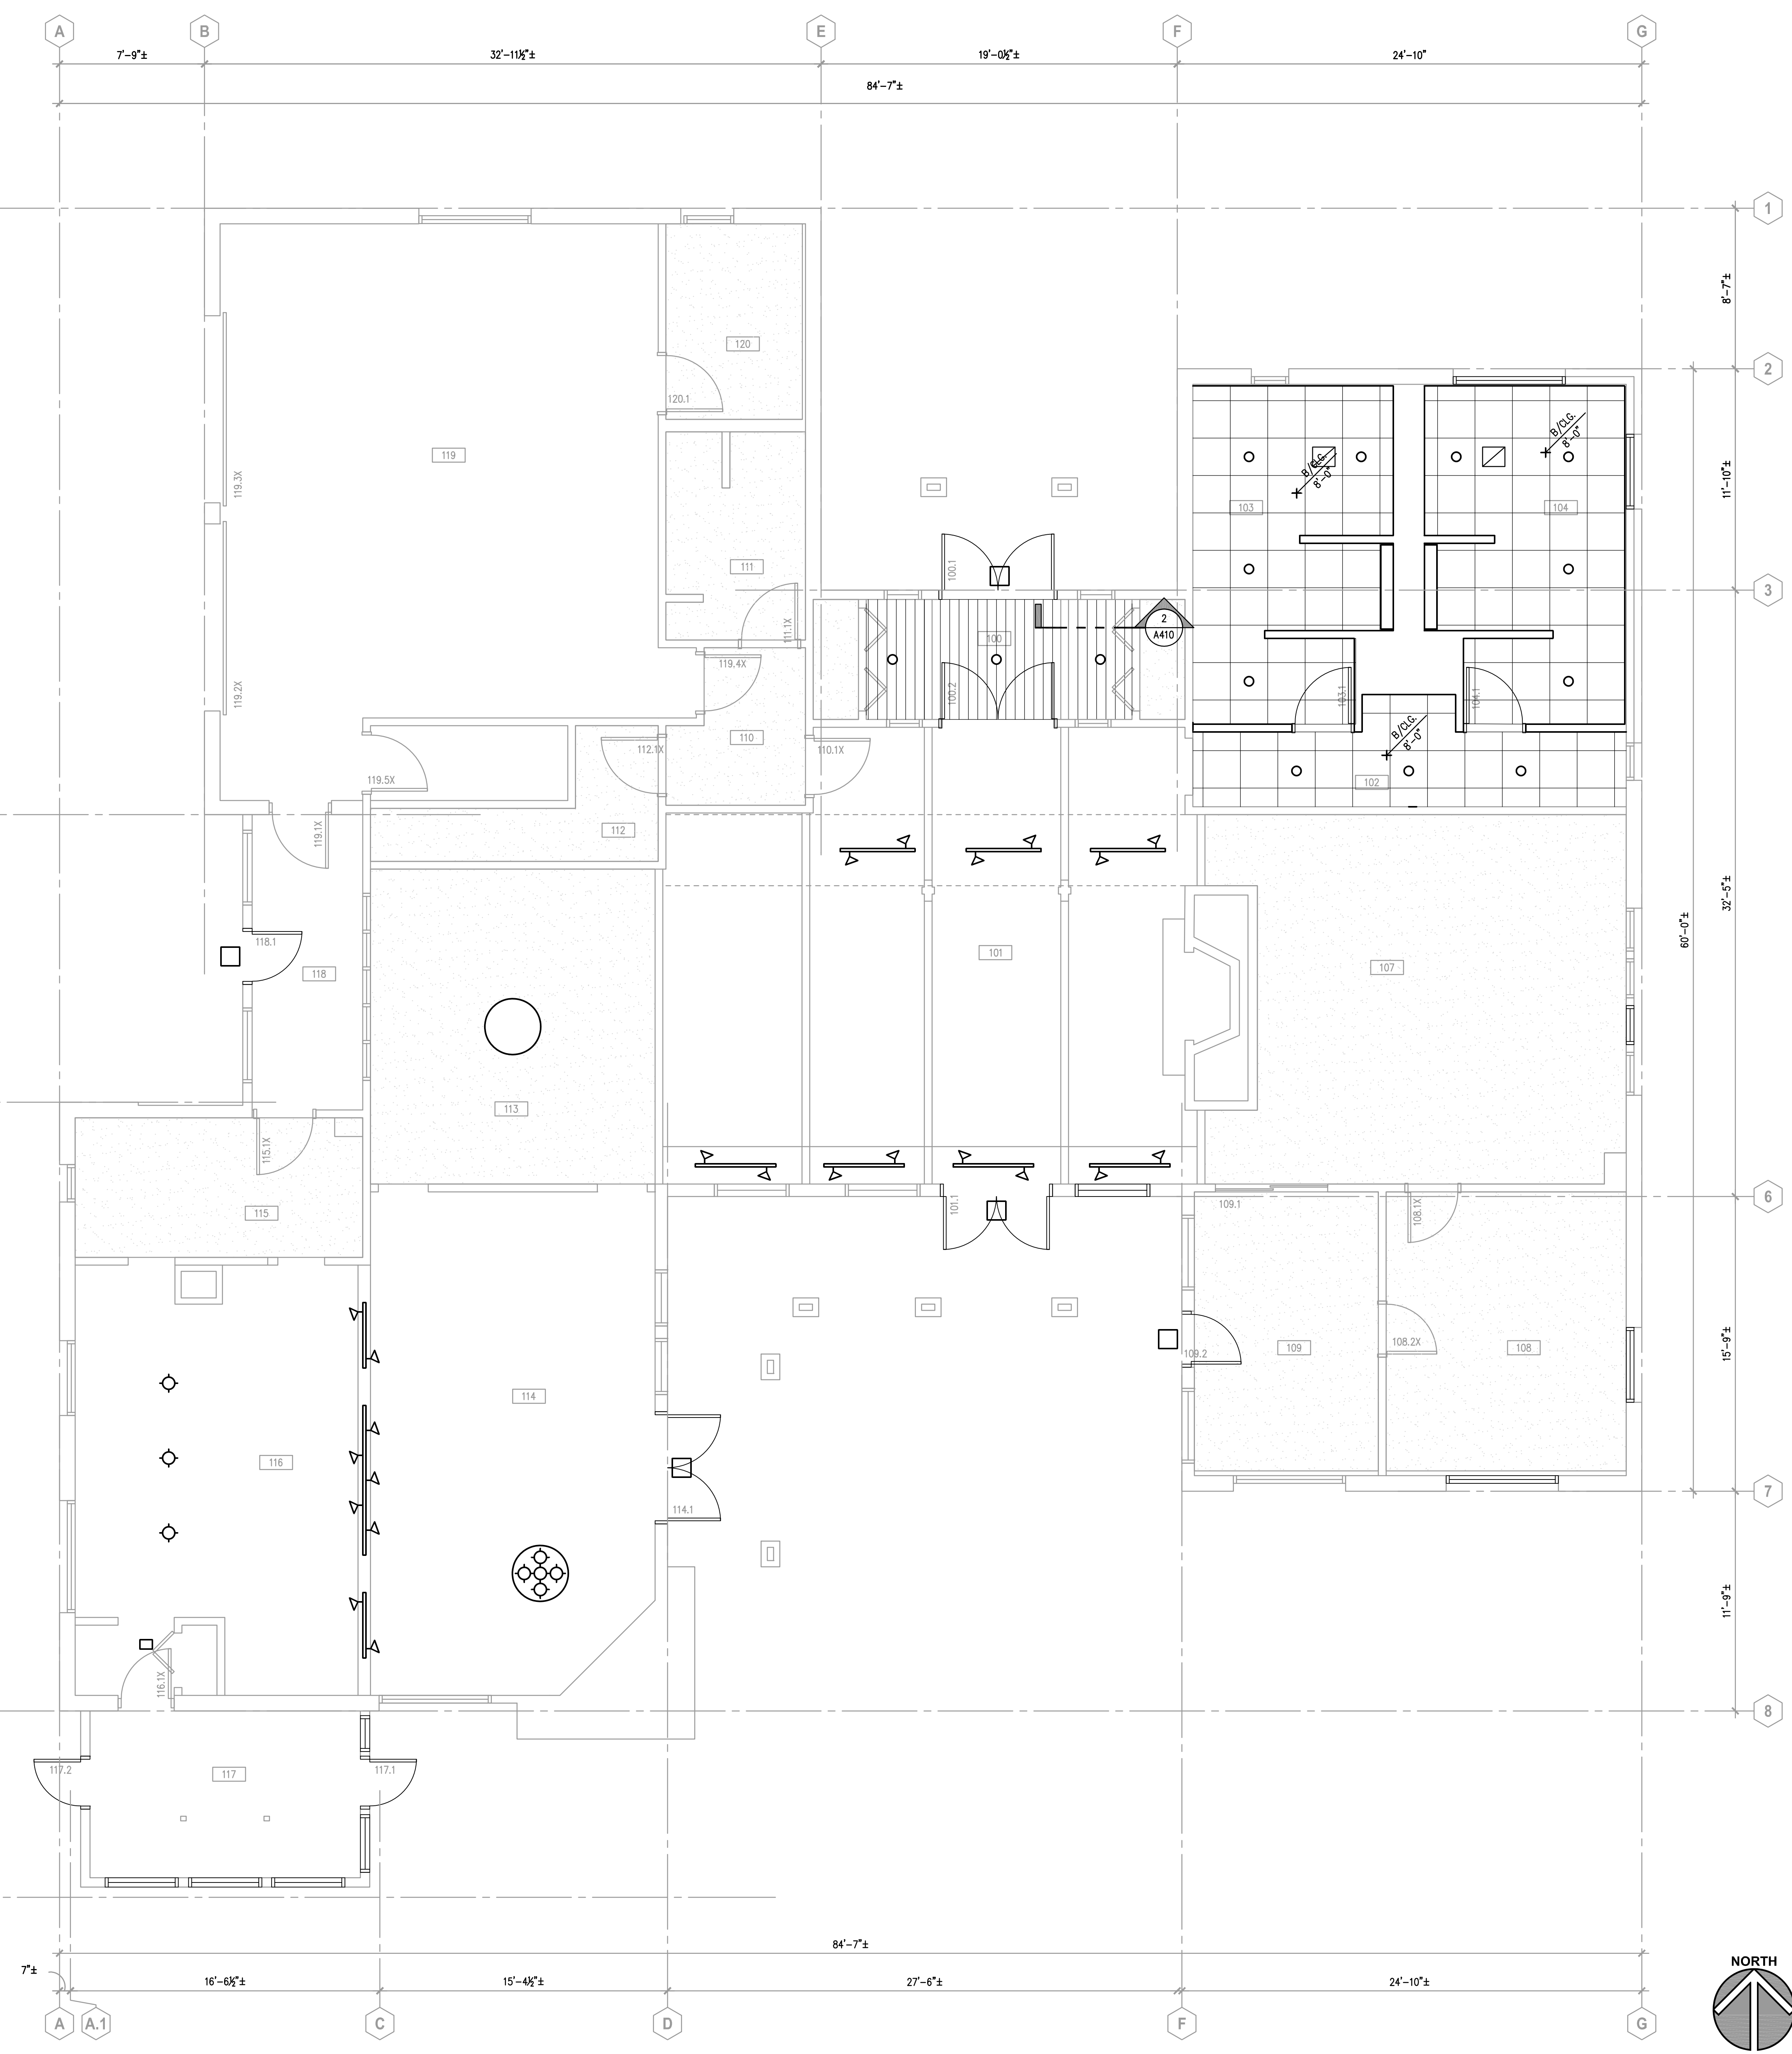

FIRST FLOOR REFLECTED CEILING PLAN
SCALE: 1/4" = 1'-0"

ISSUED	
01/09/22	BID DOCUMENTS

JOB NO.	19-429-1250
DRAWN	PJT
CHECKED	CJH
APPROVED	CJH

SHEET TITLE	FIRST FLOOR REFLECTED CEILING PLAN
SHEET NUMBER	


A410

NOTE: SCALES DEPICTED ON THIS DRAWING ARE NOT CORRECT UNLESS PLOTTED SHEET SIZE IS 30 X 42 INCHES.

KEYNOTES

KEYNOTES ARE TYPICALLY NOT DUPLICATED WITHIN A GIVEN DETAIL. AN UN-KEYNOTED ITEM IN A DETAIL IS THE SAME AS A KEYNOTED ITEM HAVING THE SAME APPEARANCE WITHIN THE SAME DETAIL.

26.001 LIGHT FIXTURE: EXTERIOR UP-DOWN LIGHT; REFER TO ELECTRICAL DRAWINGS.

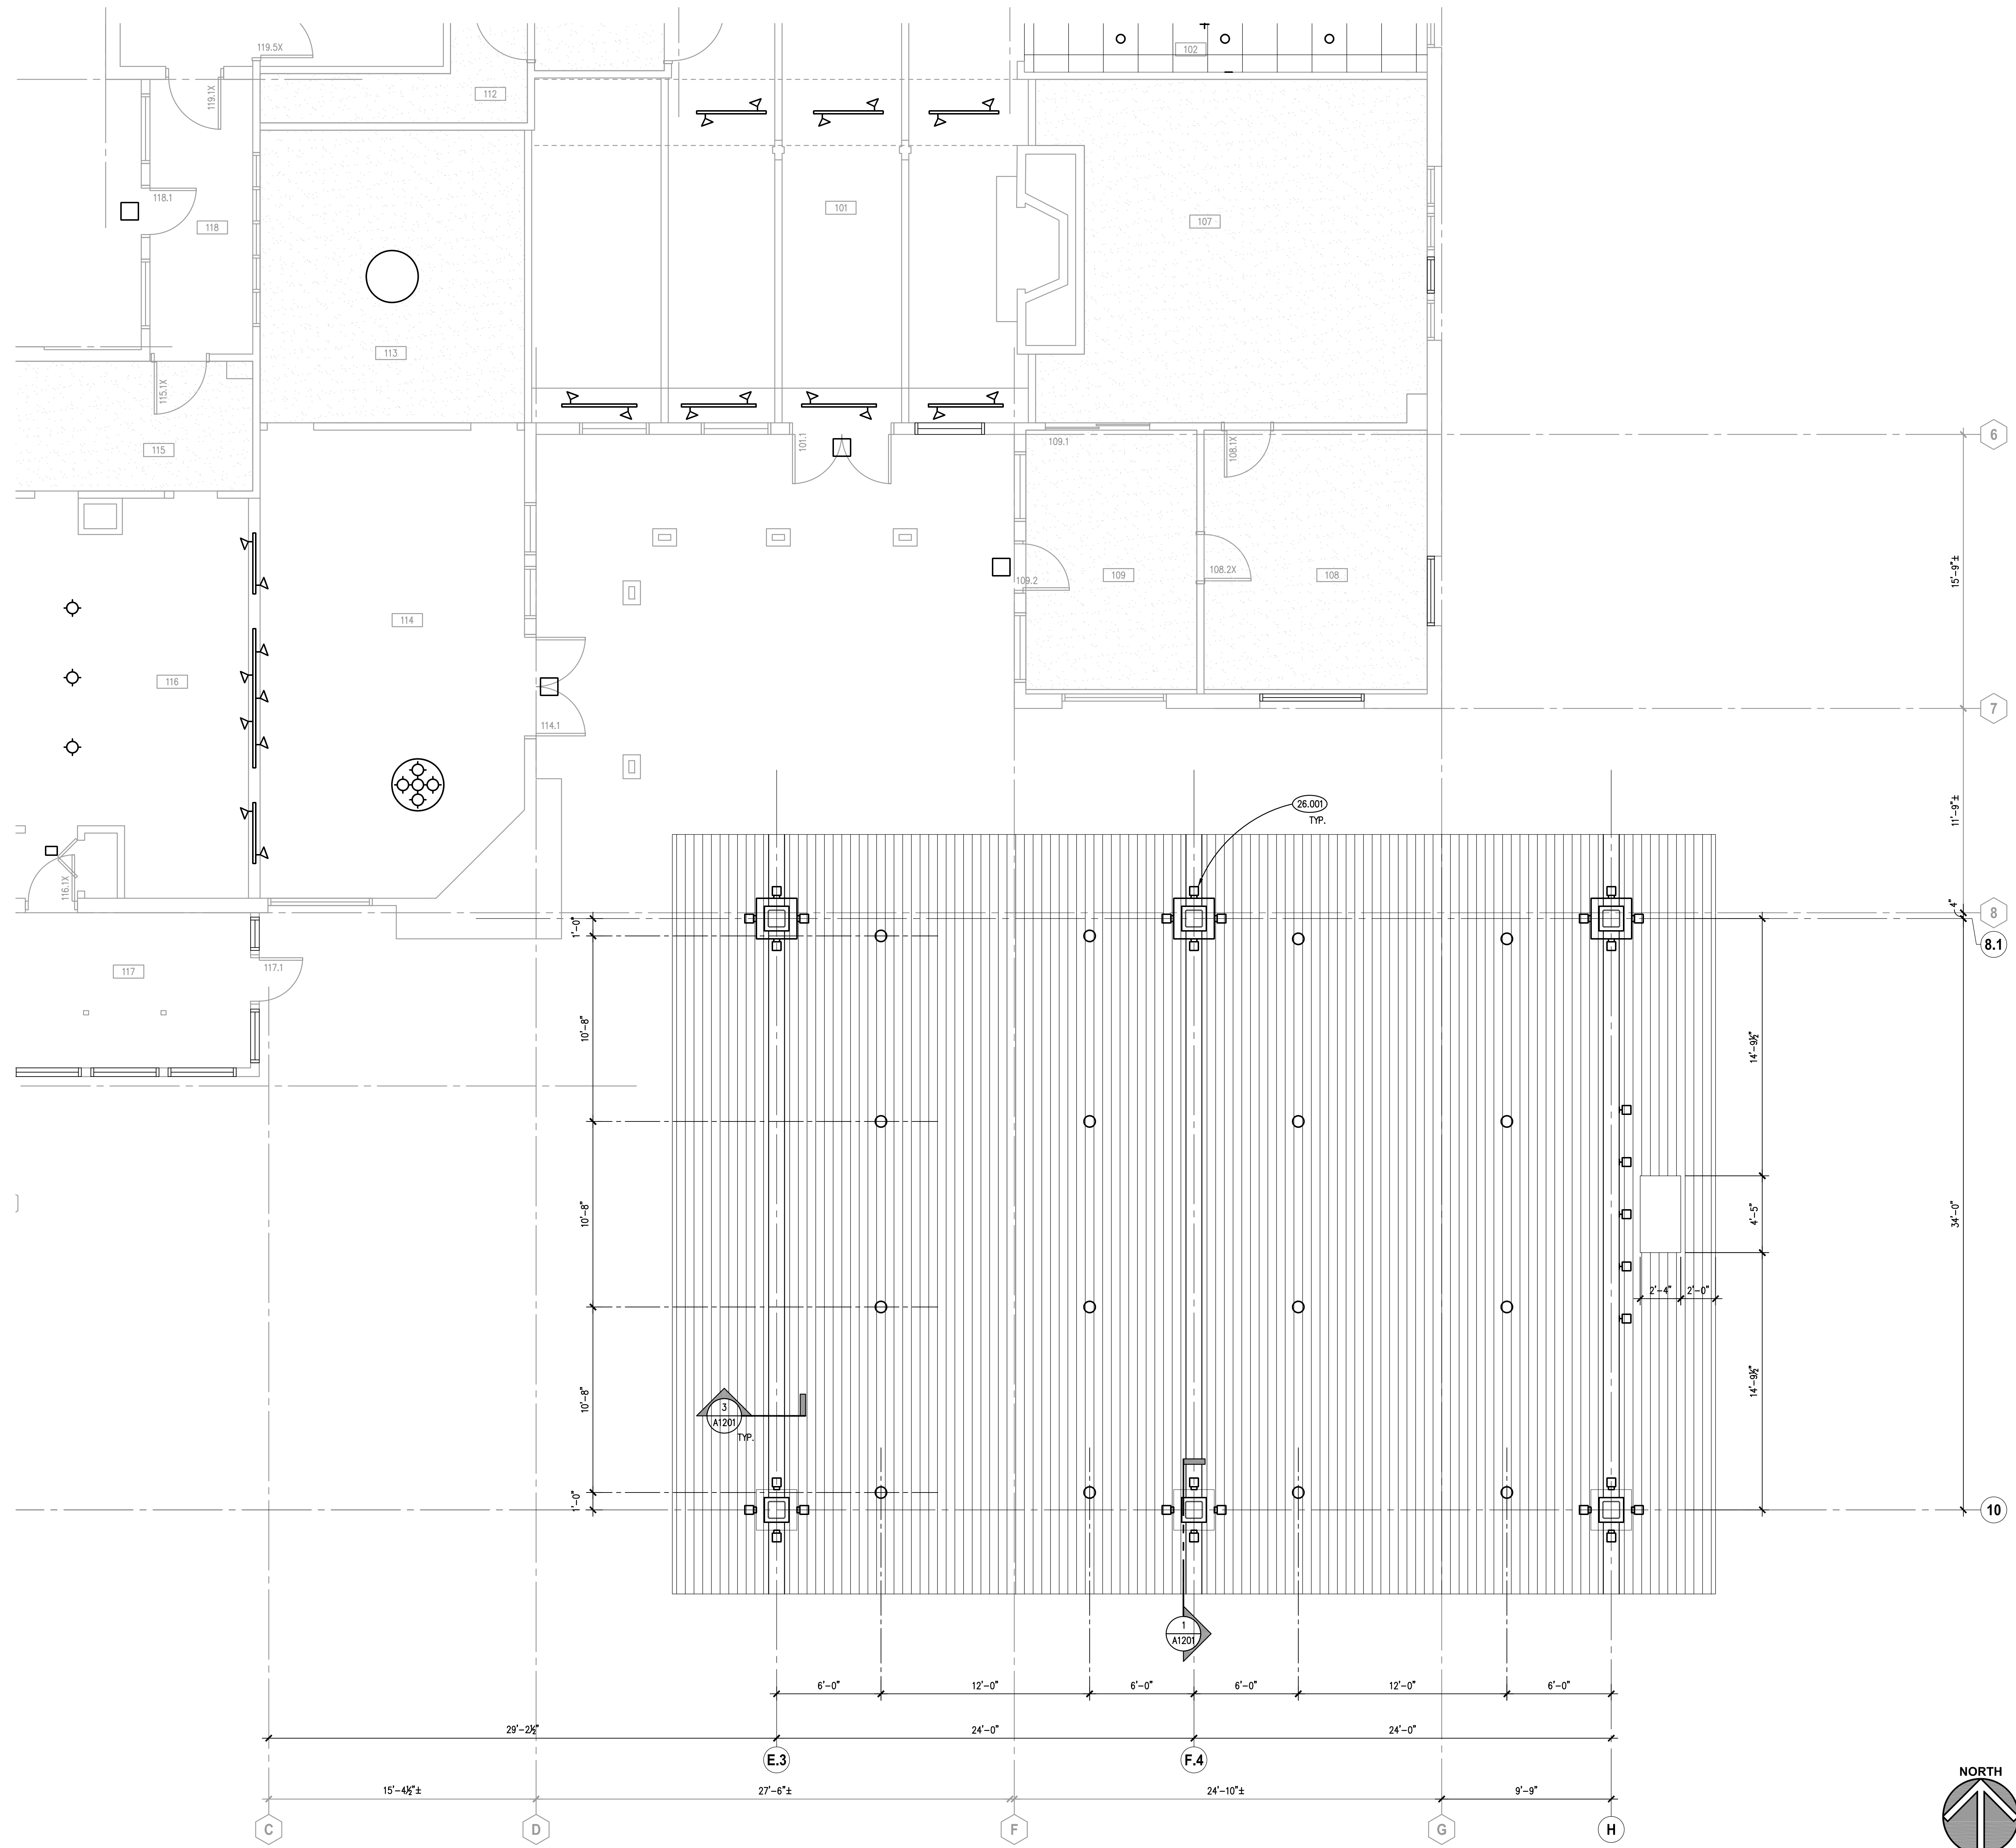

CANOPY REFLECTED CEILING PLAN 1
SCALE: 1/4" = 1'-0"

GENERAL NOTES

1. REFER TO DRAWING G100 FOR PROJECT GENERAL NOTES.

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ISSUED	
01/06/22	BID DOCUMENTS


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APPROVED CJH

SHEET TITLE


CANOPY REFLECTED CEILING PLAN

SHEET NUMBER


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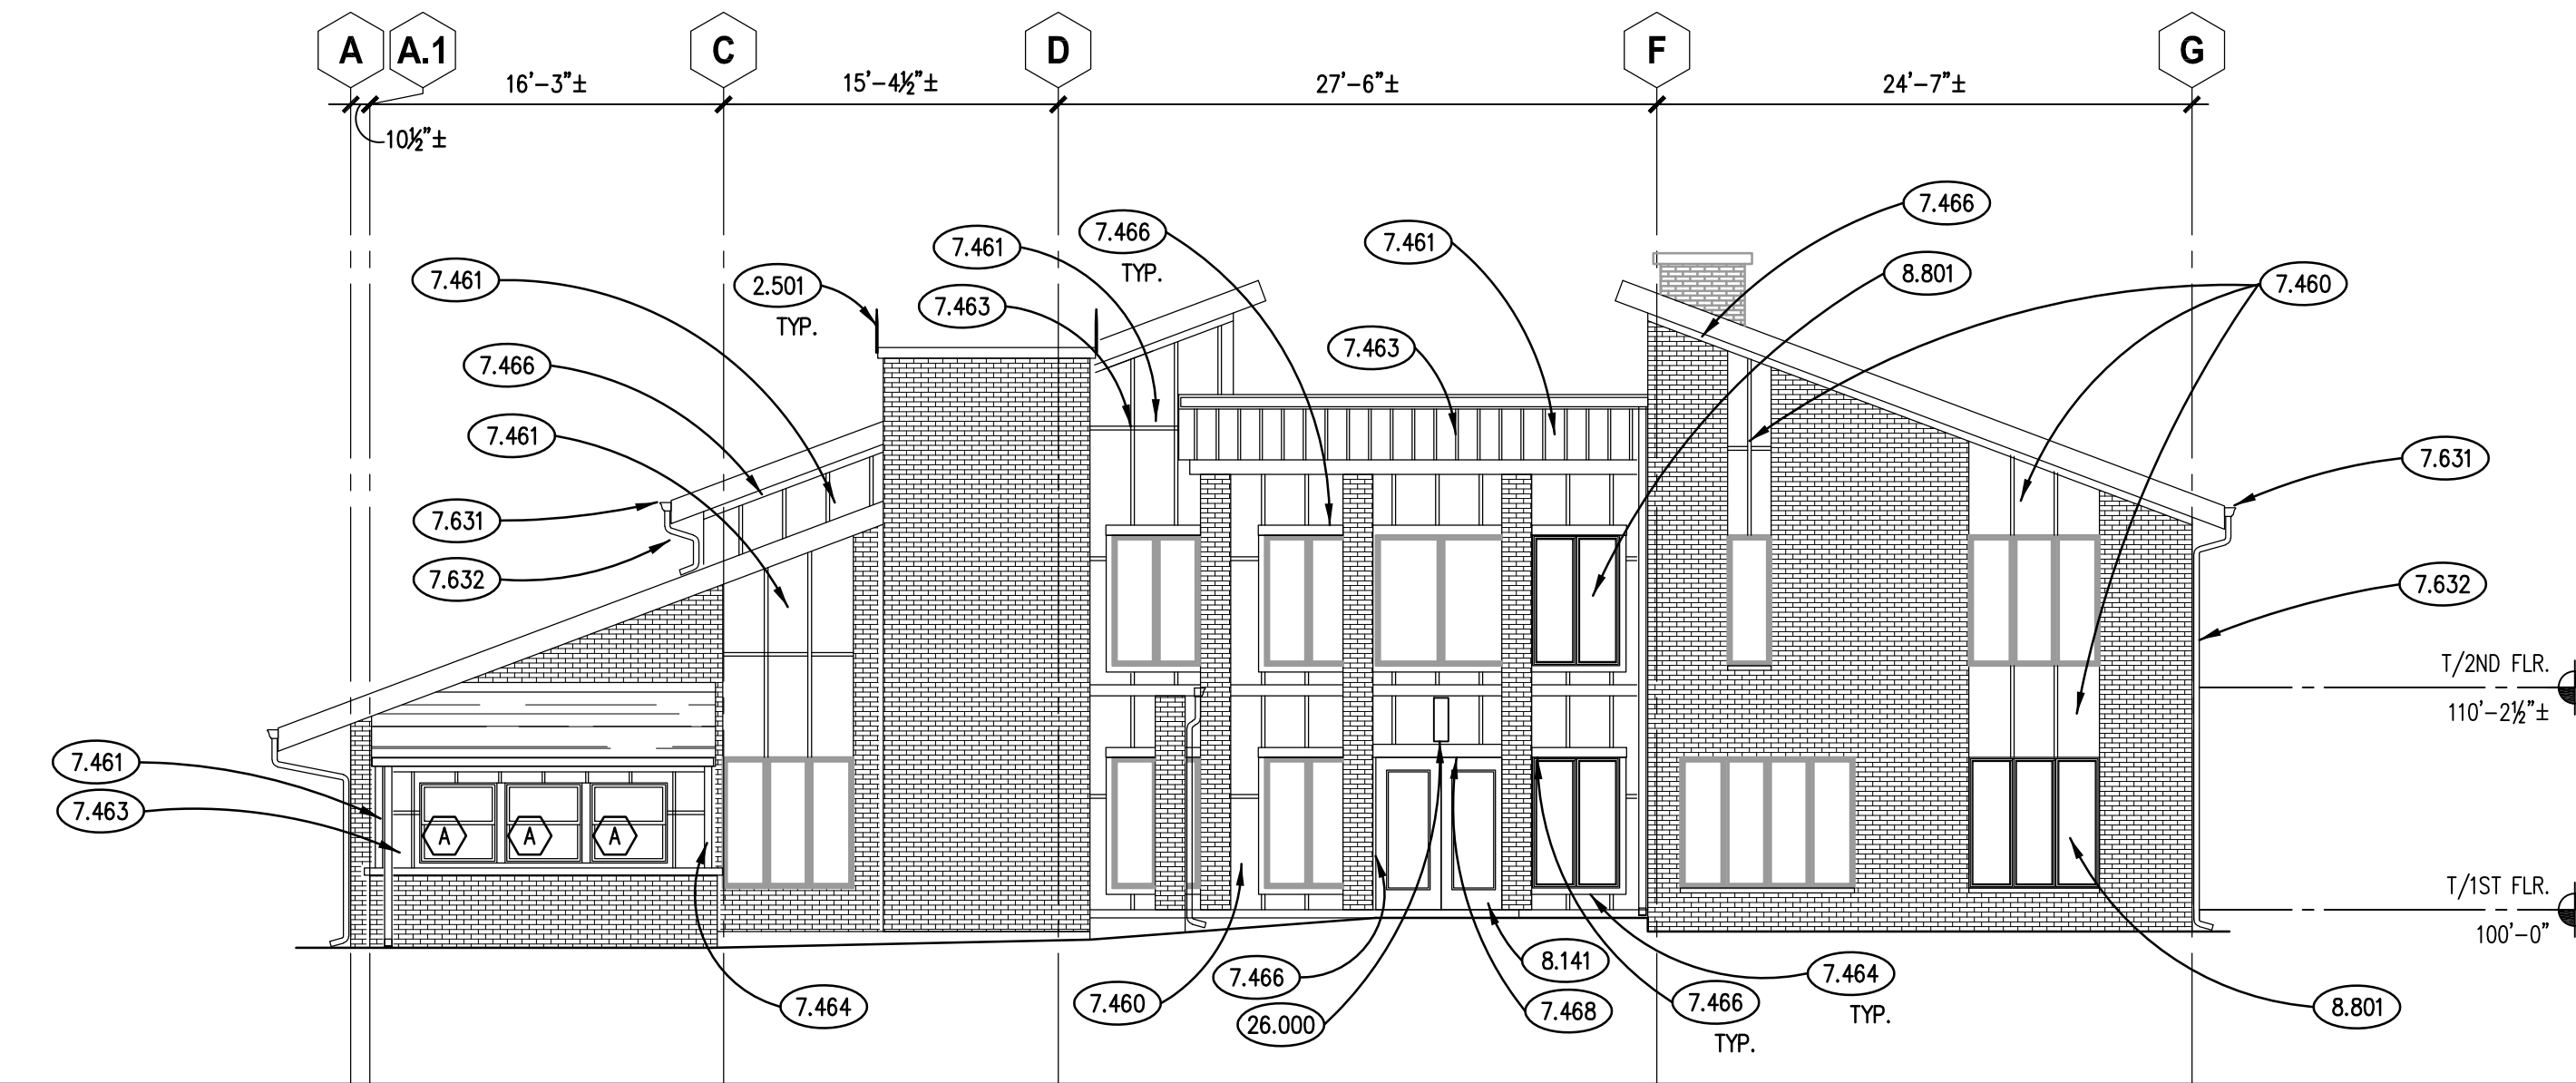
EAST CANOPY ELEVATION 8
SCALE: 1/8" = 1'-0"

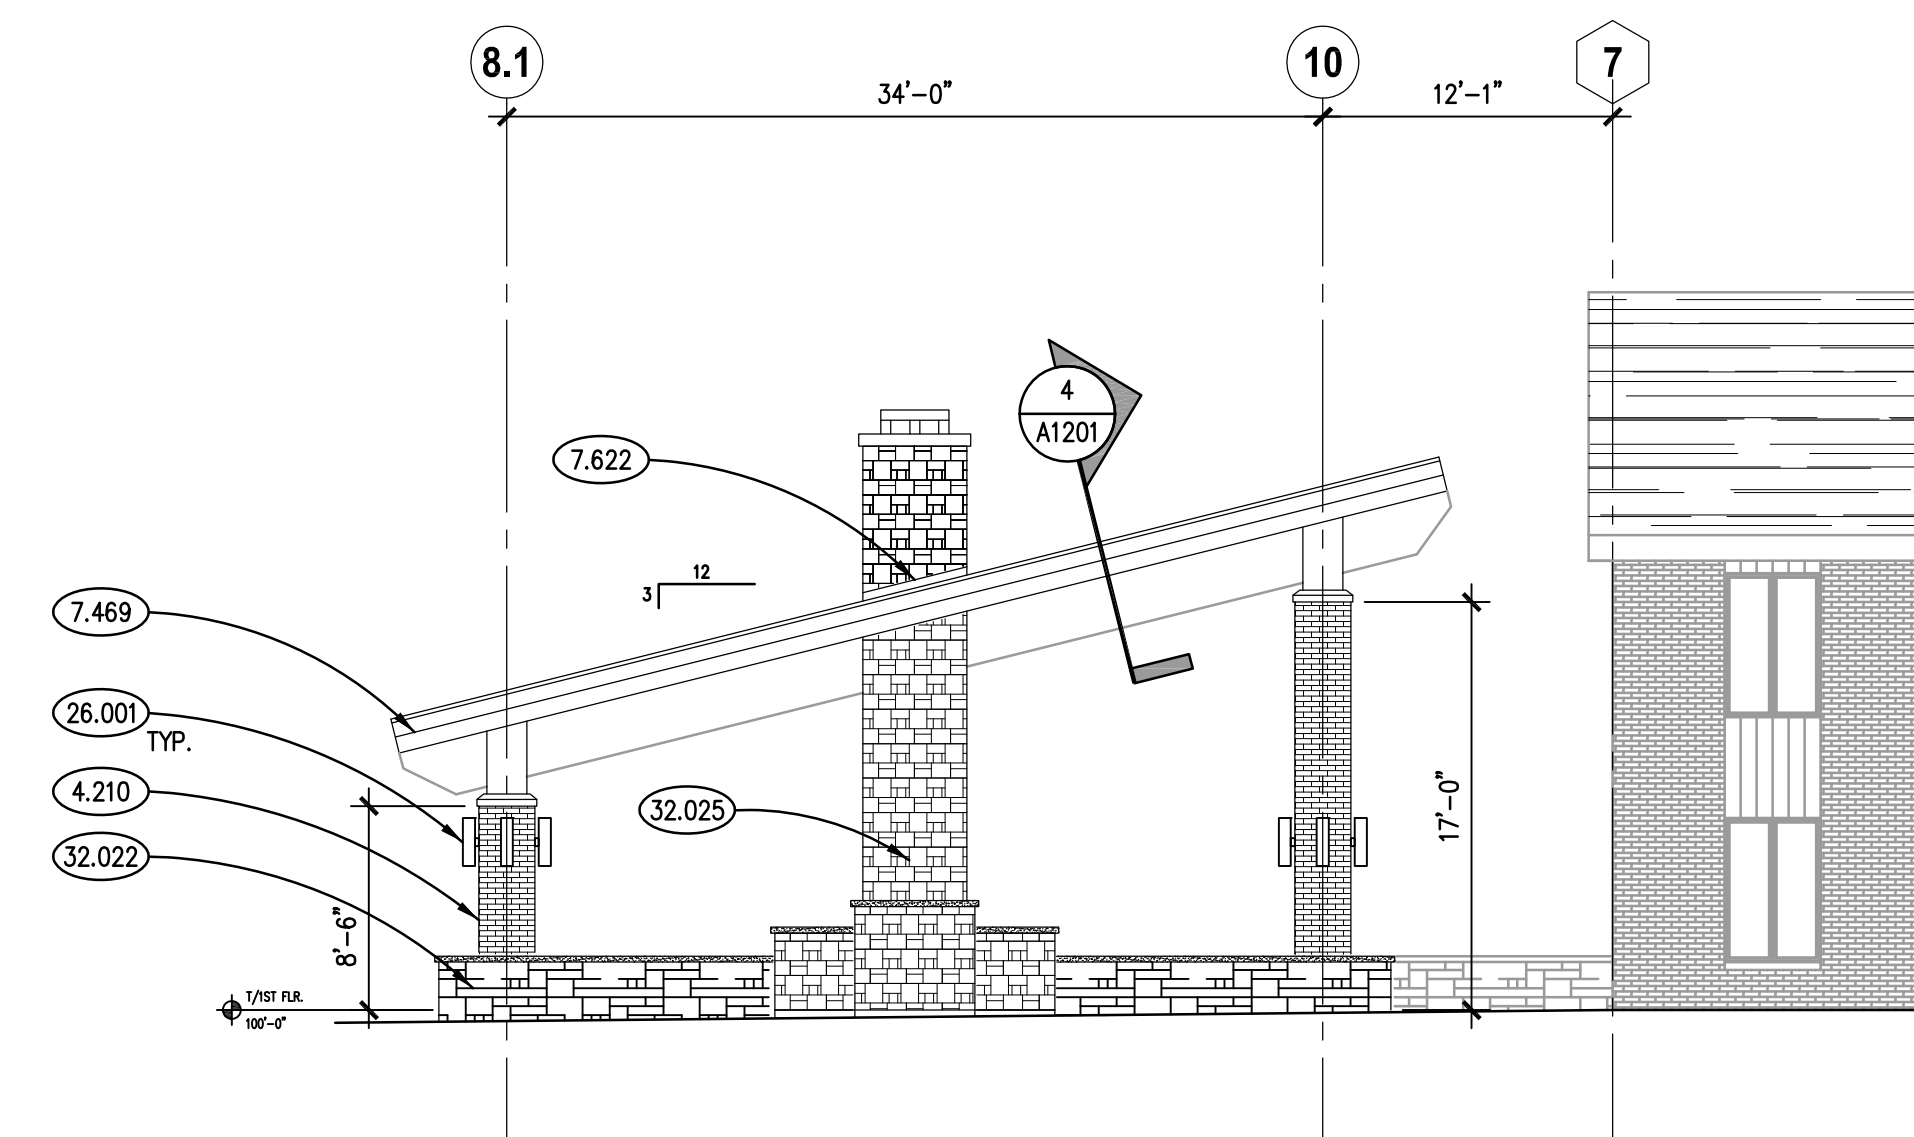


WEST ELEVATION 4
SCALE: 1/8" = 1'-0"

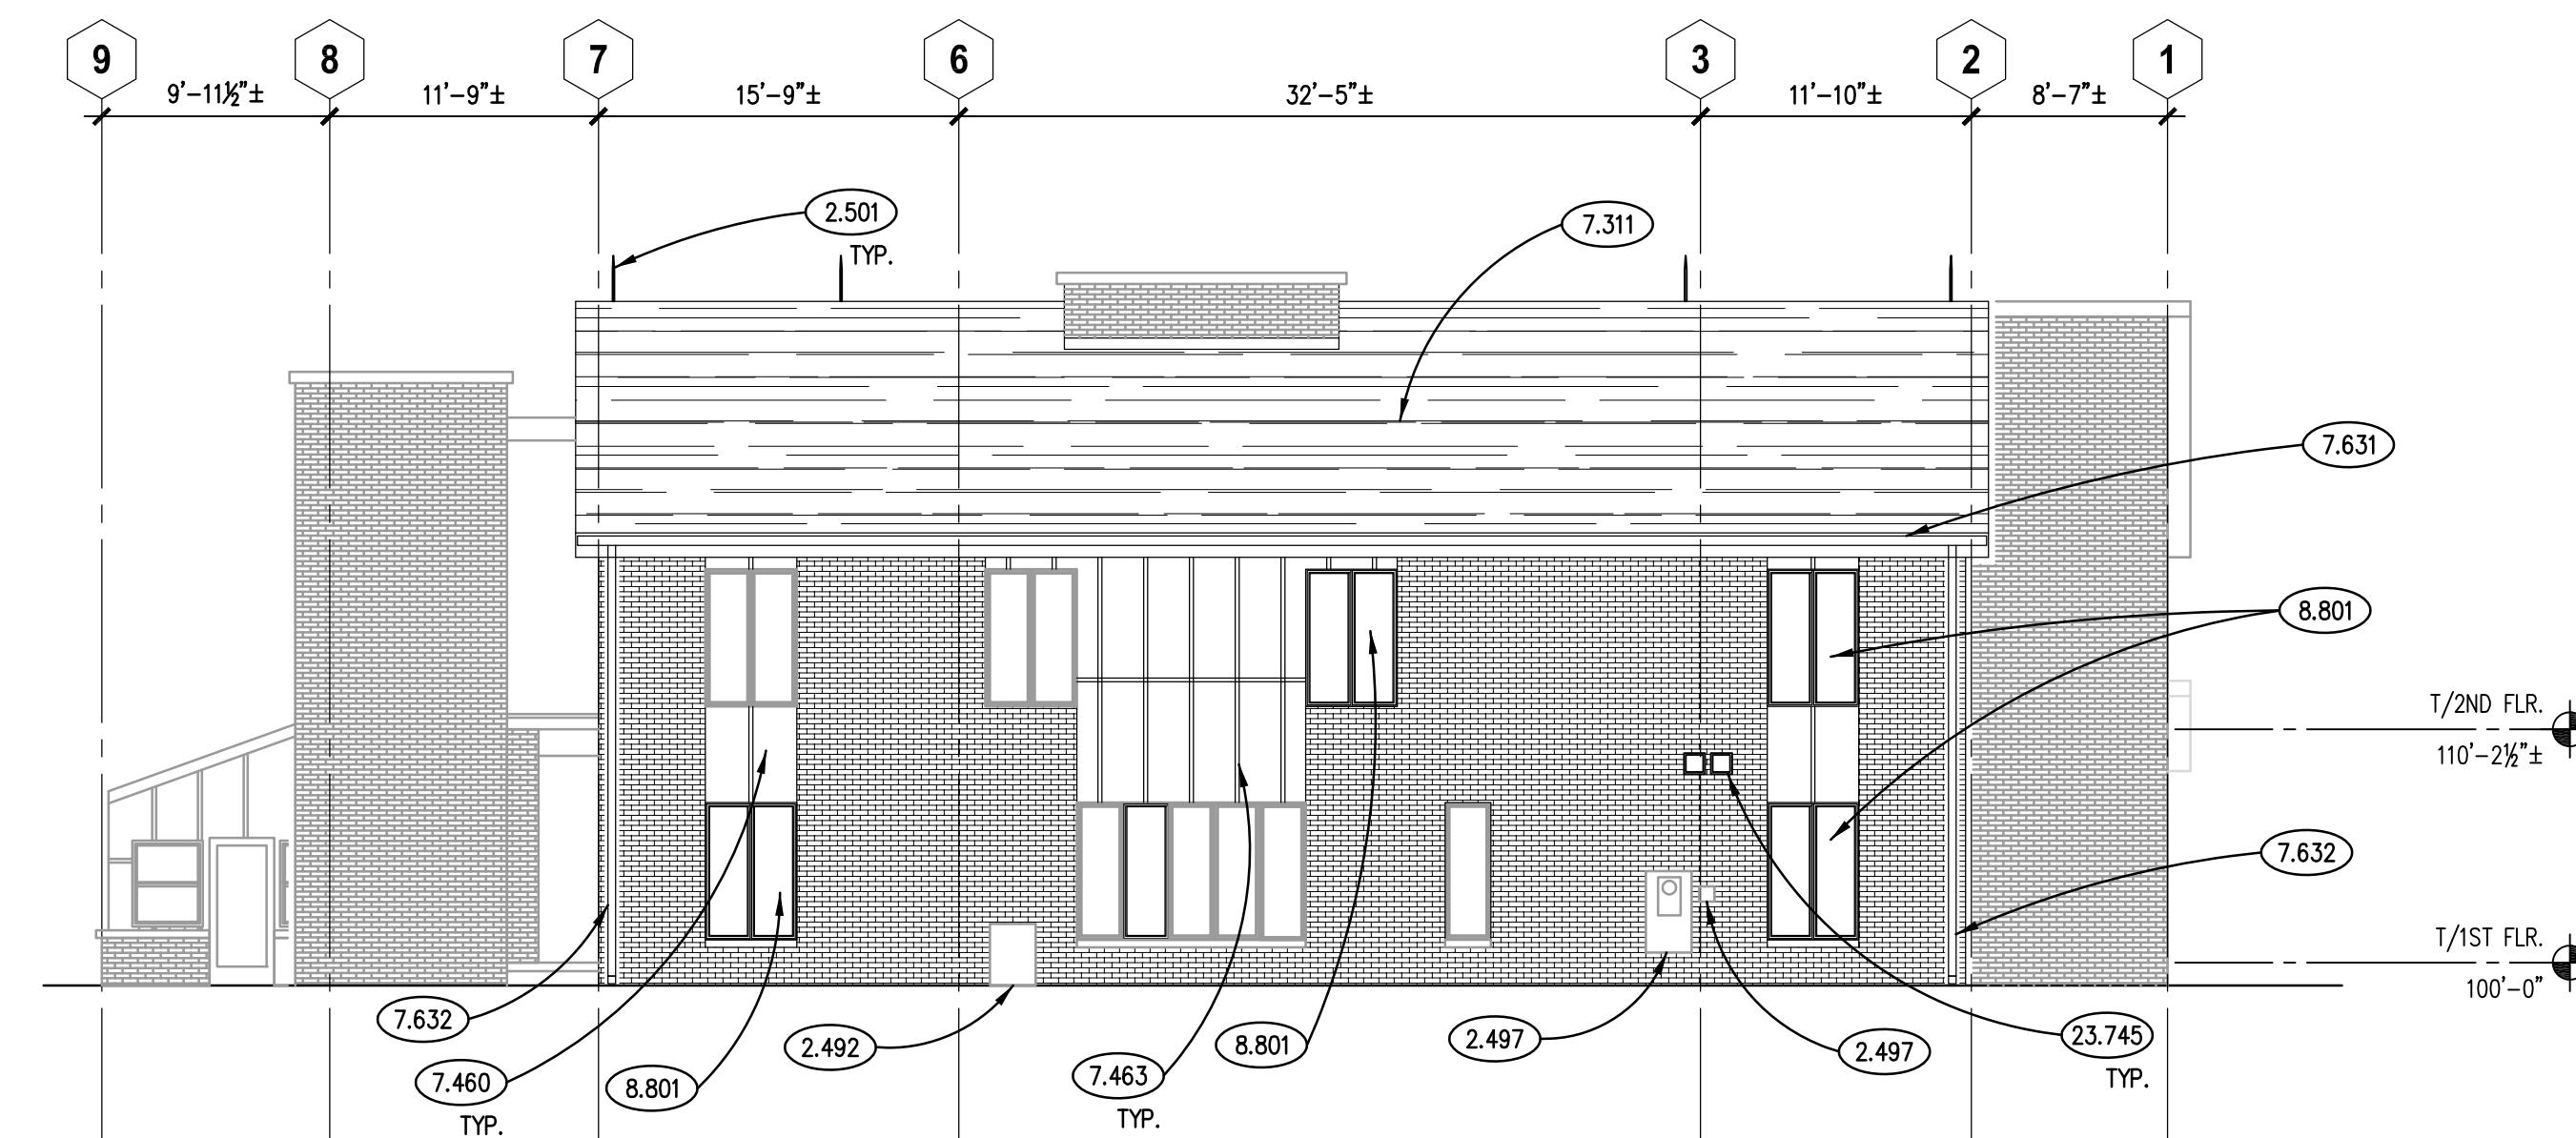


NORTH CANOPY ELEVATION 7
SCALE: 1/8" = 1'-0"

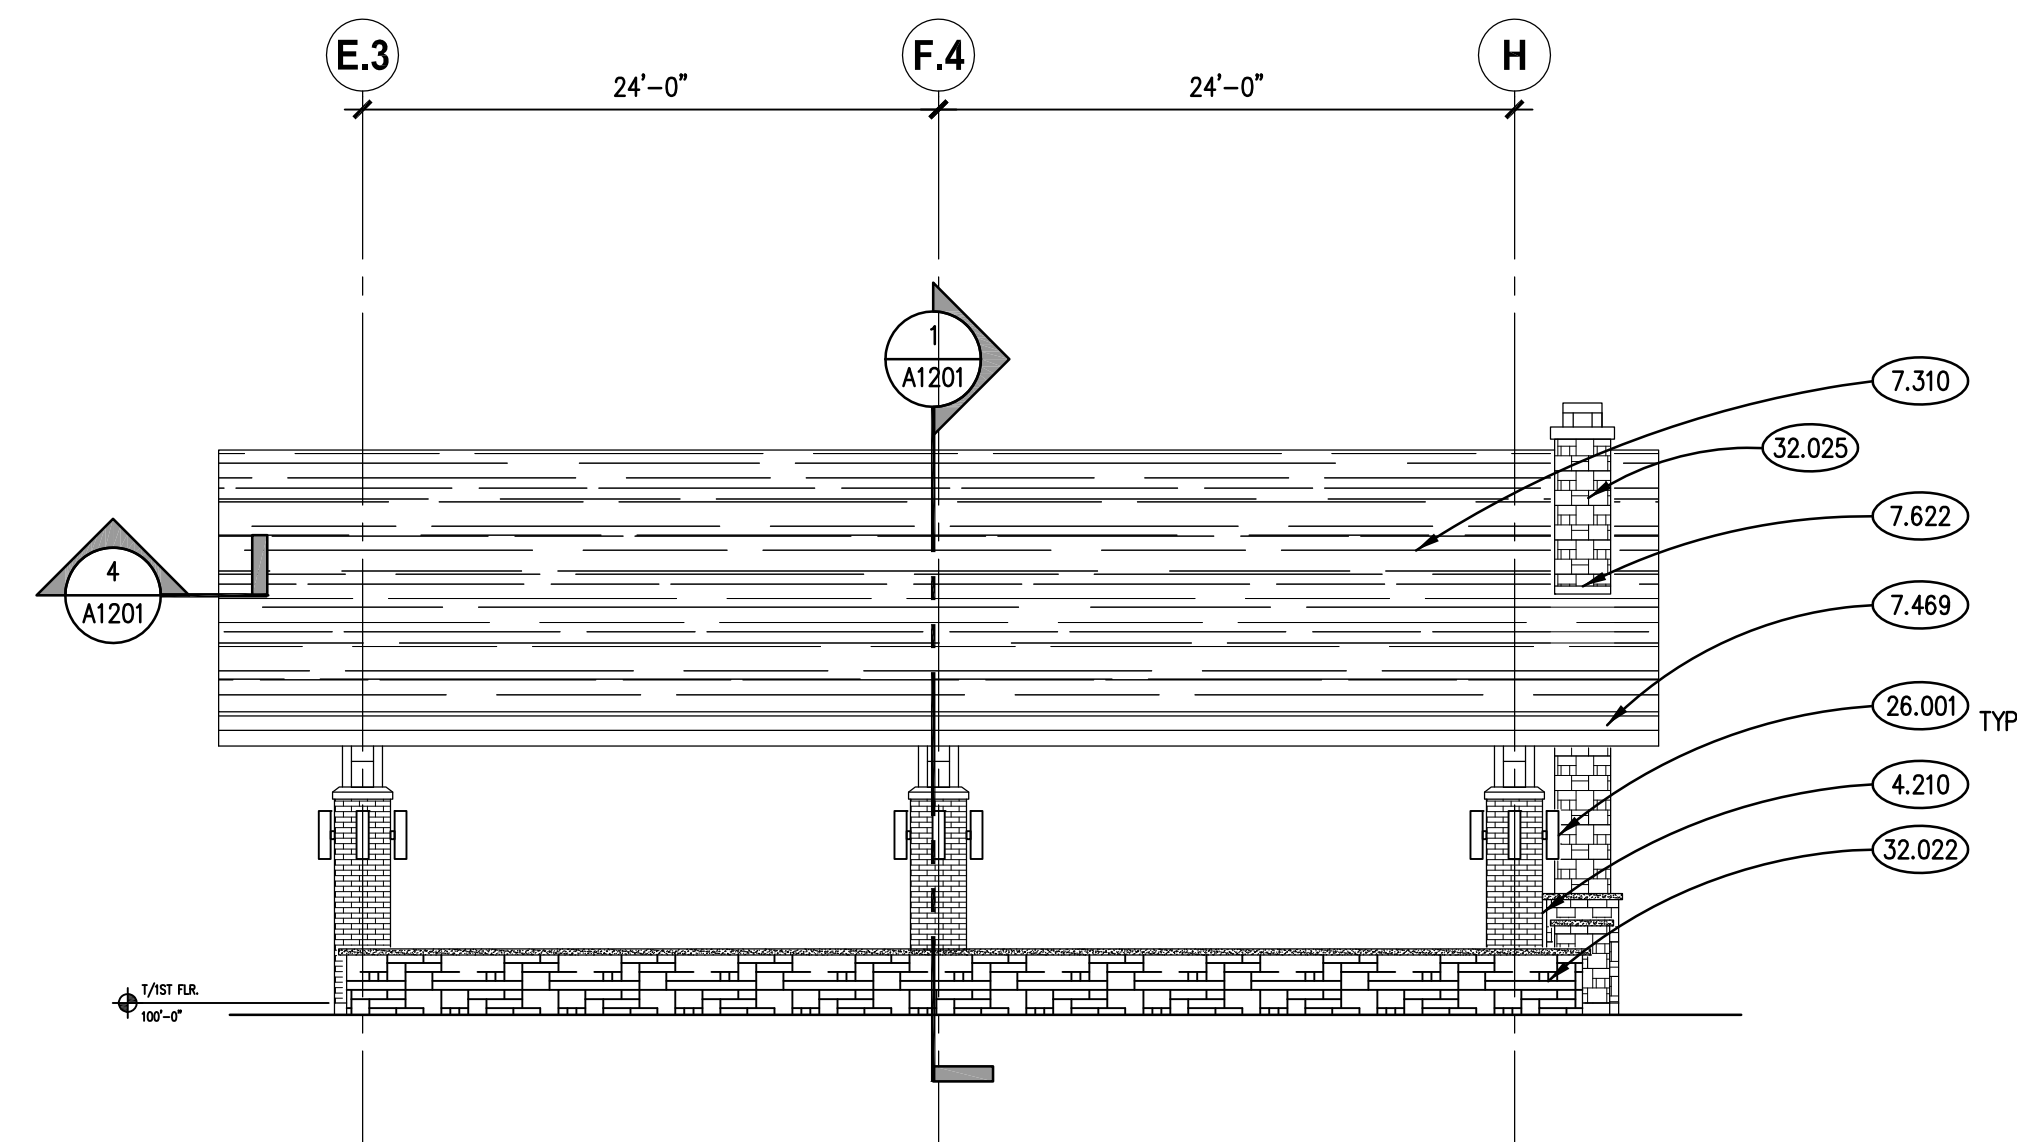


SOUTH ELEVATION 3
SCALE: 1/8" = 1'-0"

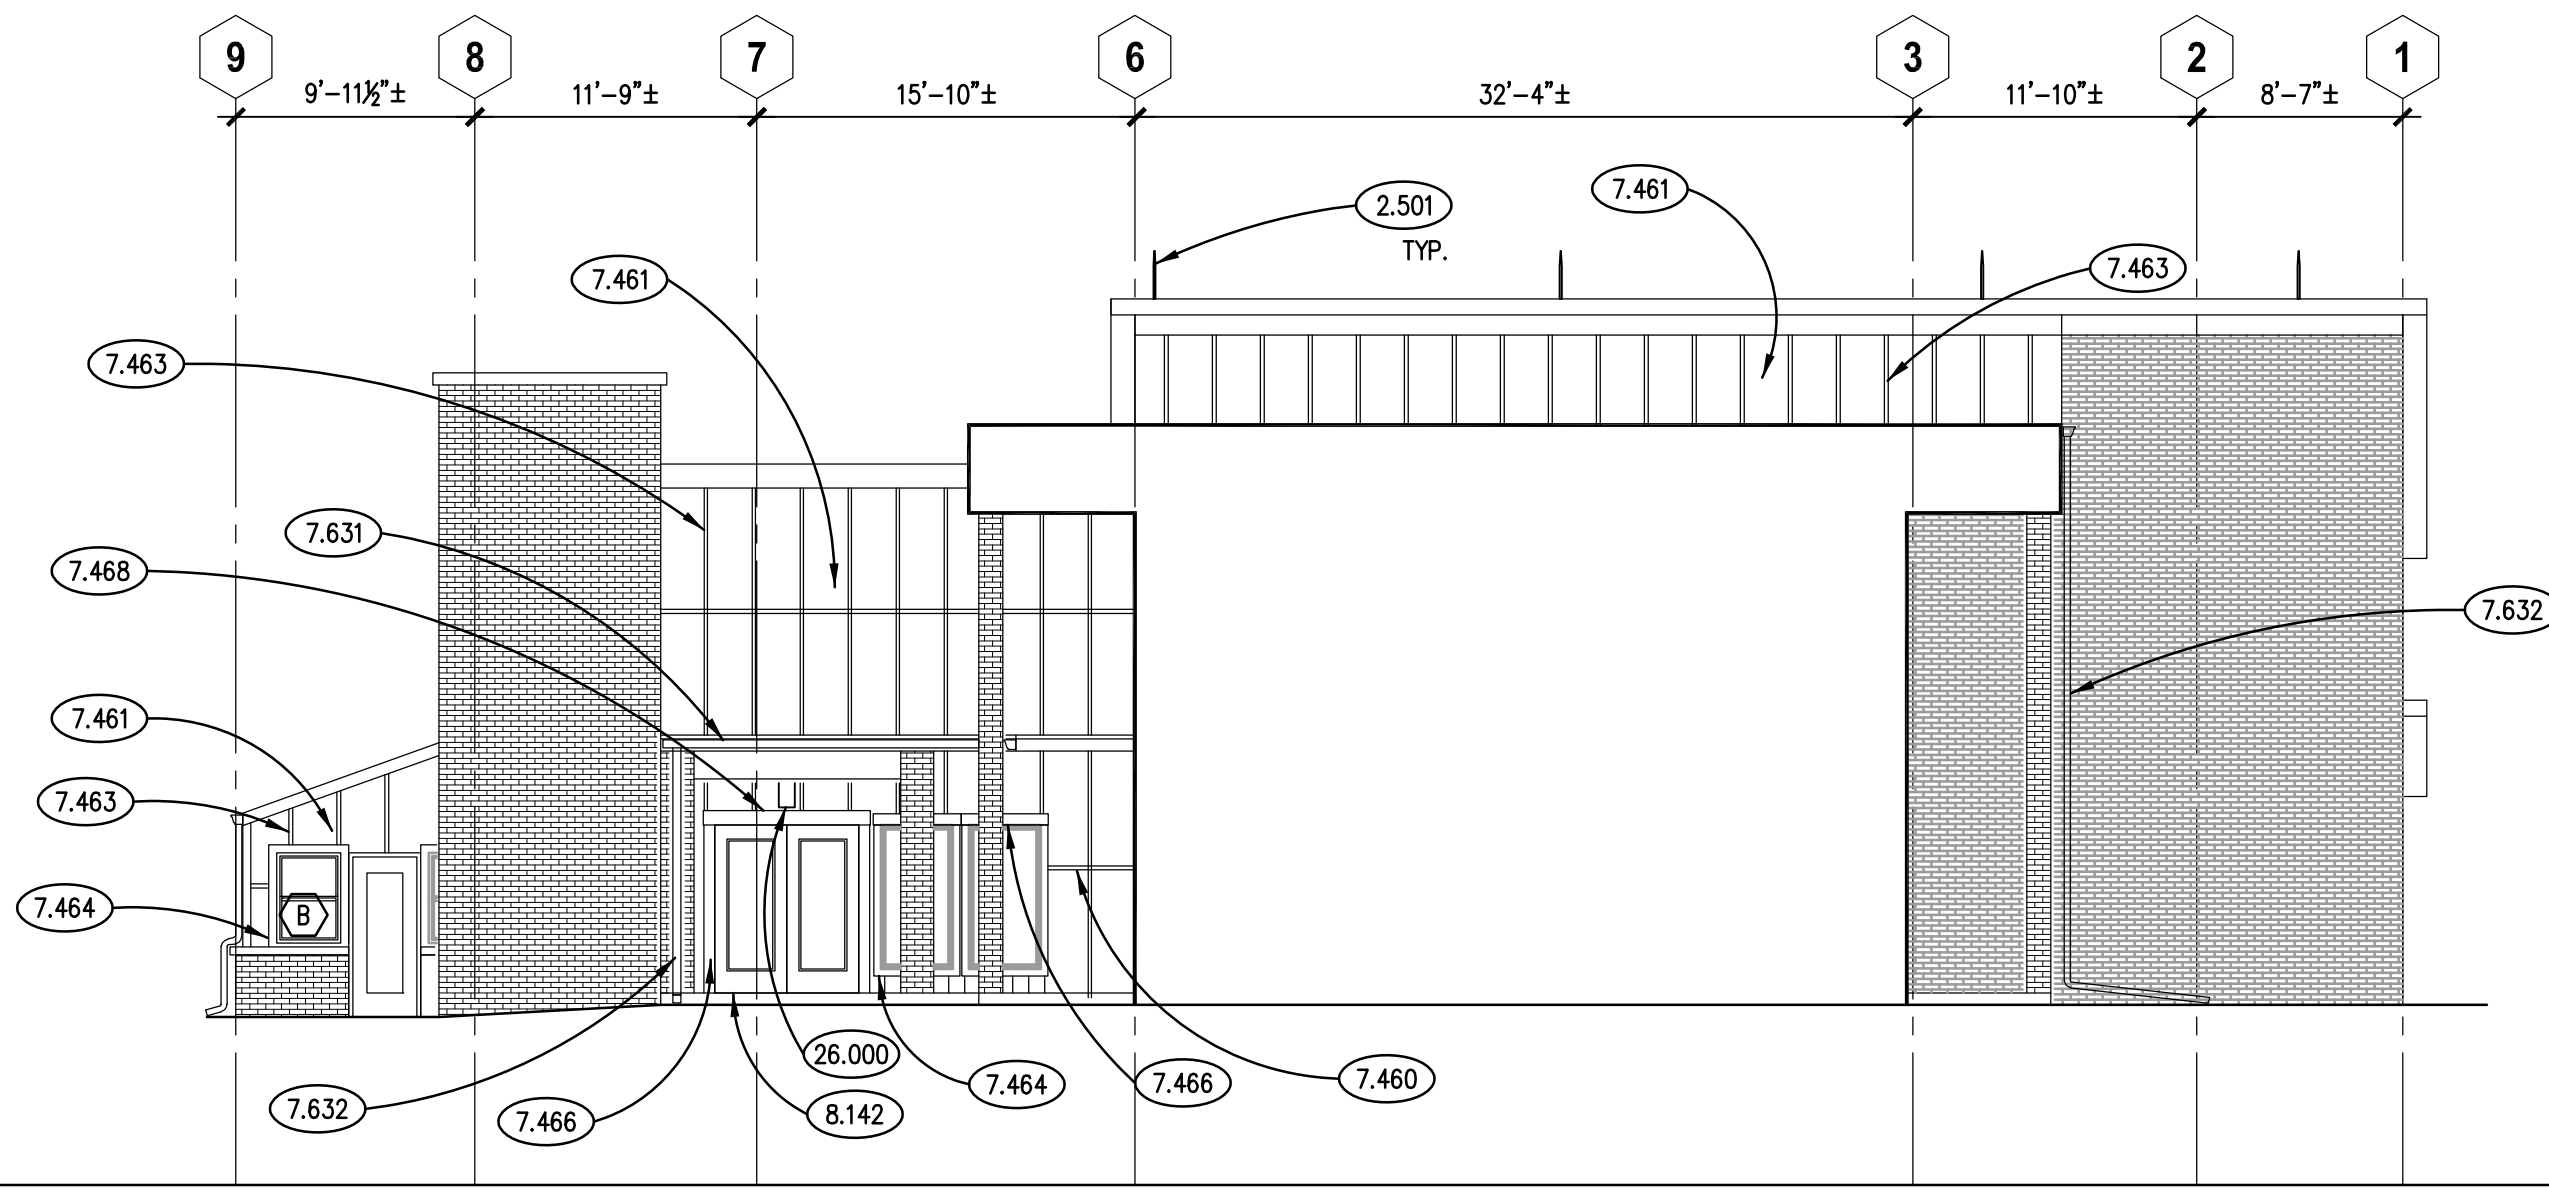


PARTIAL WEST ELEVATION 6
SCALE: 1/8" = 1'-0"

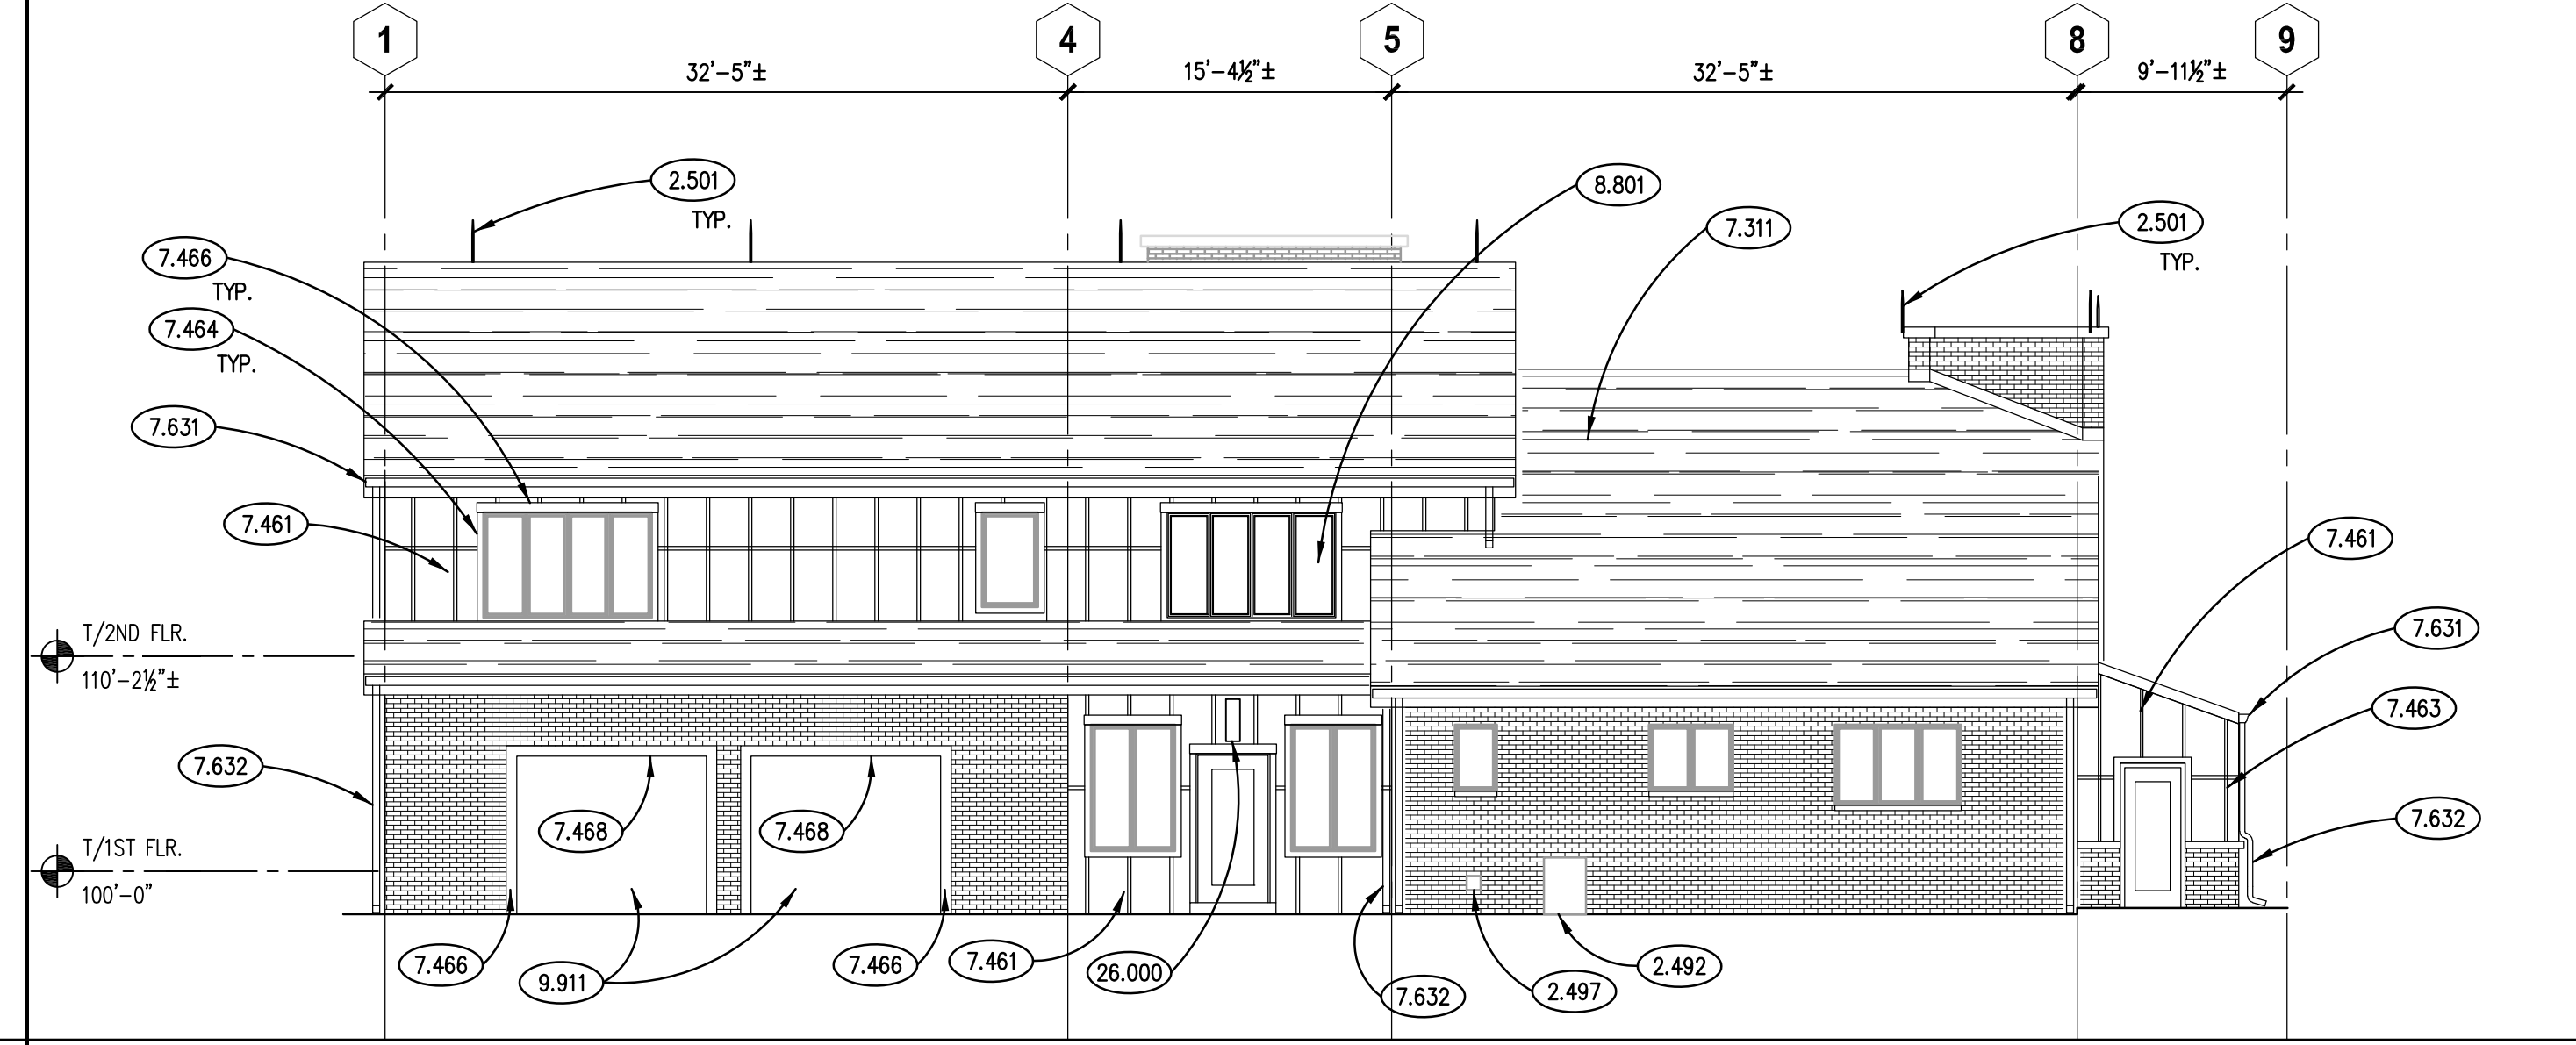

EAST ELEVATION 2
SCALE: 1/8" = 1'-0"

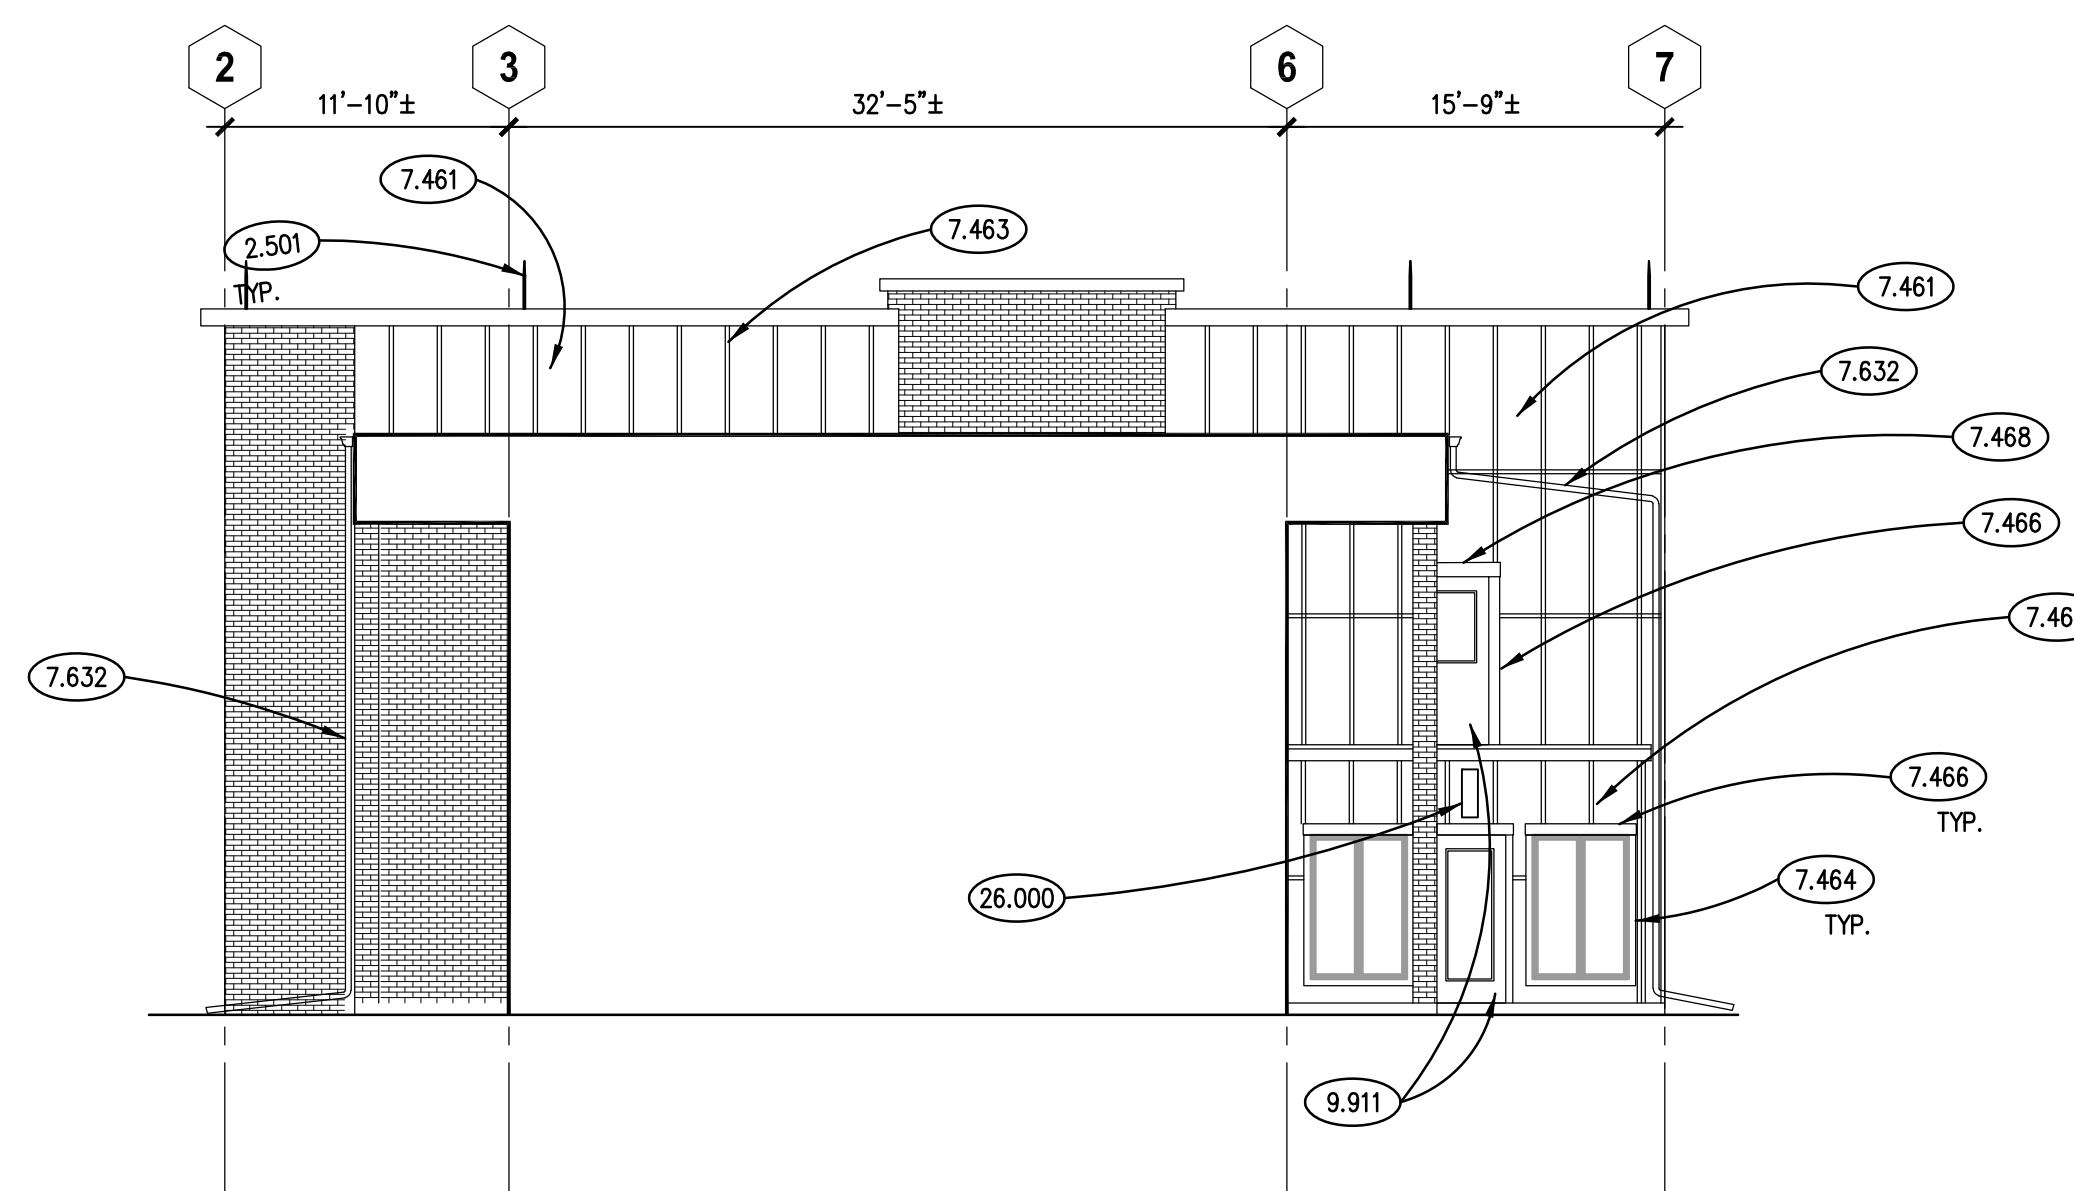

PARTIAL EAST ELEVATION 5
SCALE: 1/8" = 1'-0"

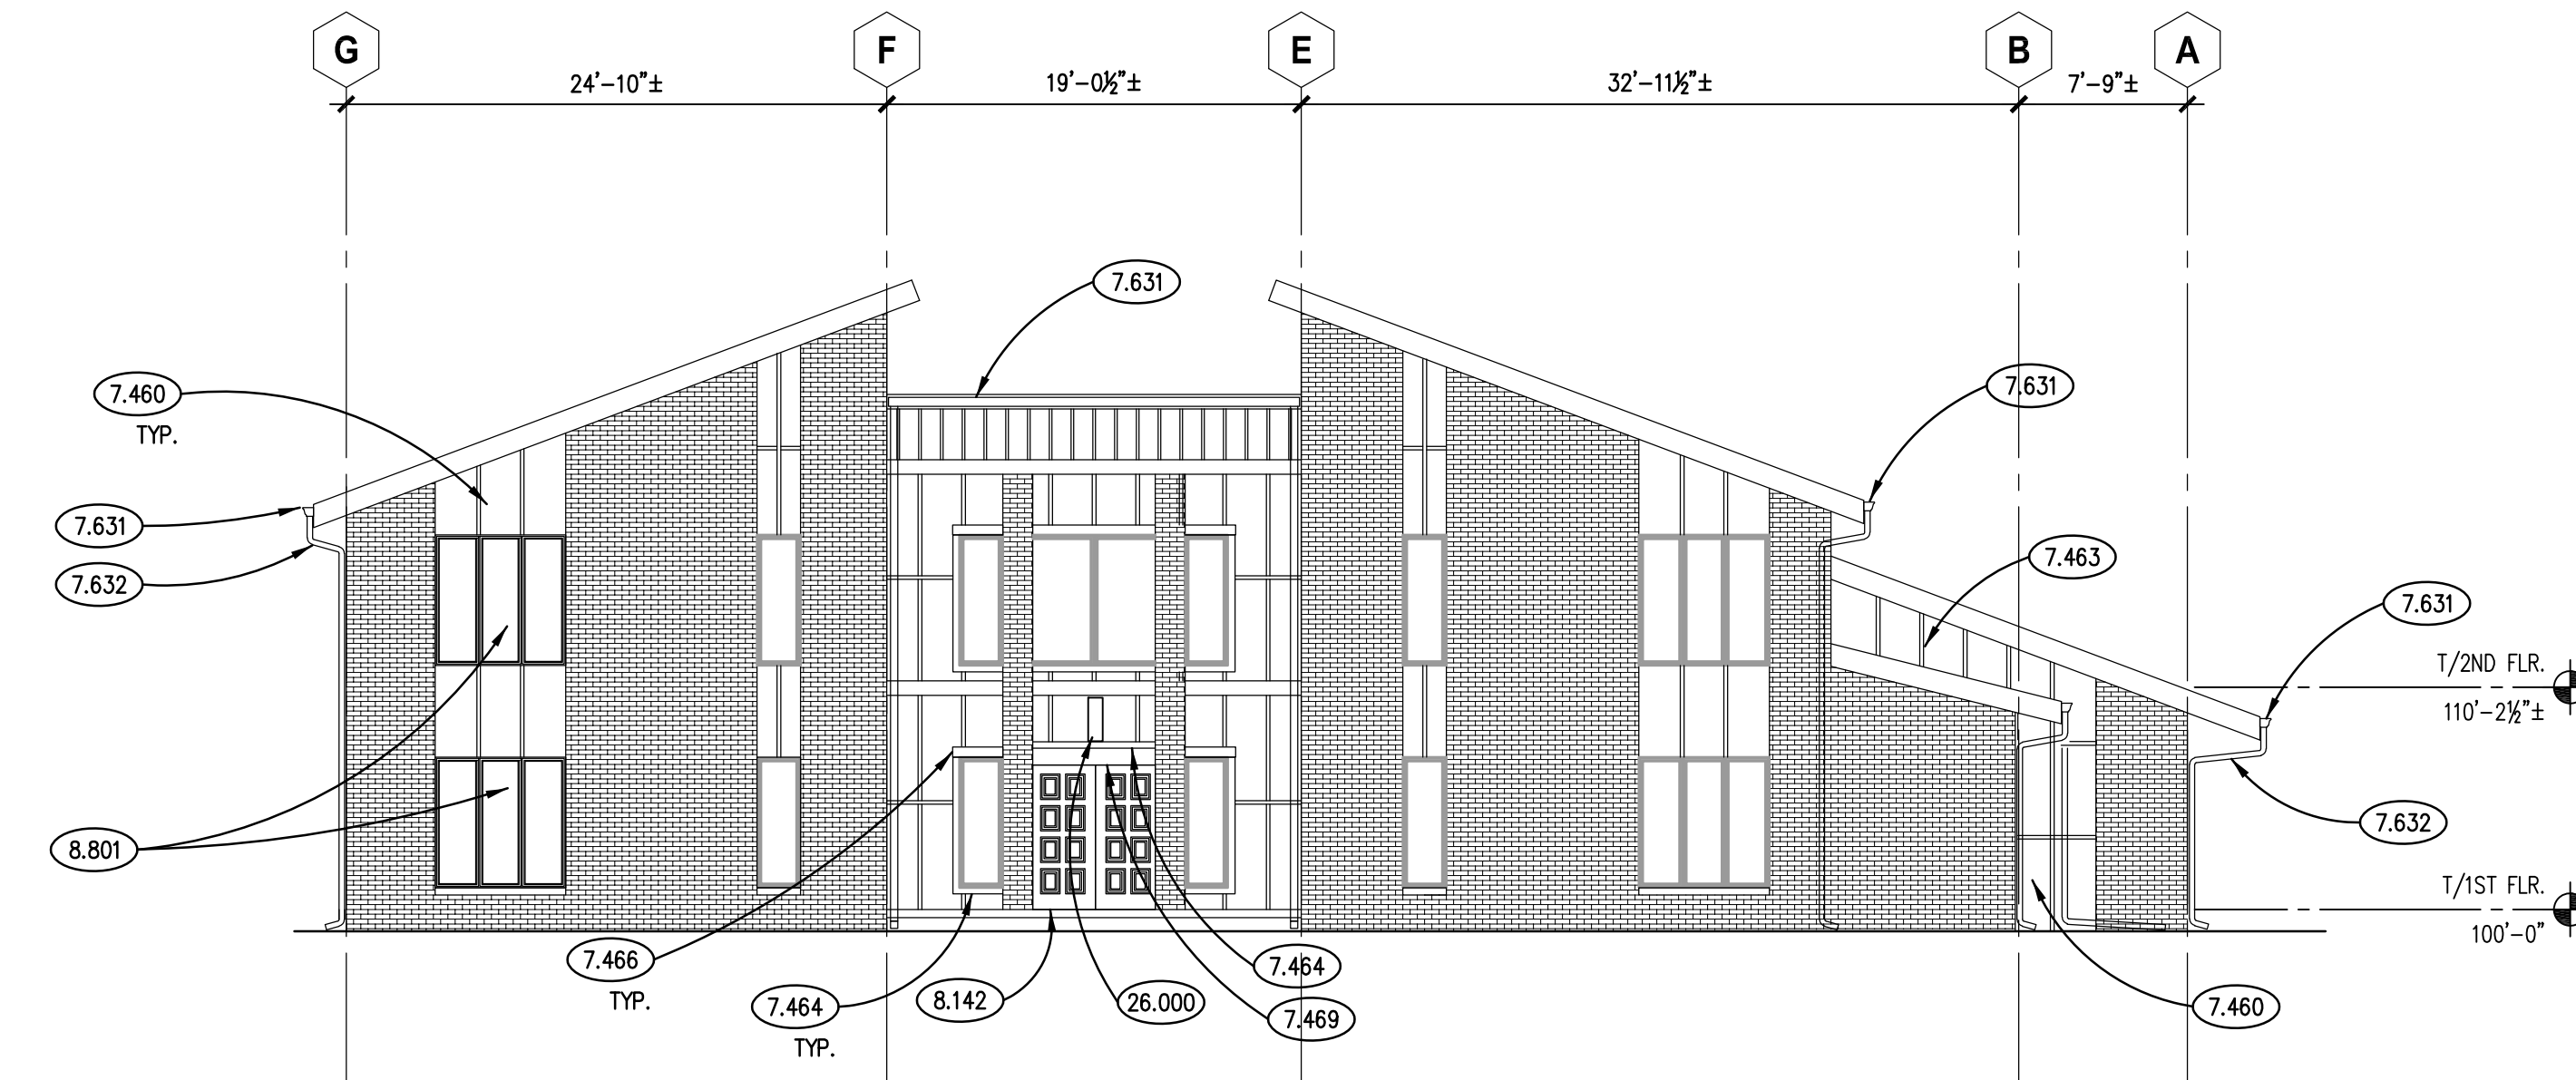

NORTH ELEVATION 1
SCALE: 1/8" = 1'-0"

KEYNOTES

KEYNOTES ARE TYPICALLY NOT DUPLICATED WITHIN A GIVEN DETAIL. AN UN-KEYNOTED ITEM IN A DETAIL IS THE SAME AS A KEYNOTED ITEM HAVING THE SAME APPEARANCE WITHIN THE SAME DETAIL.

- 2.492 REMOVE EXISTING MECHANICAL SYSTEM COMPONENT: CEILING DIFFUSER/GRILLE.
- 2.497 REMOVE EXISTING ELECTRICAL SYSTEM COMPONENT: AS INDICATED; REFER TO ELECTRICAL DRAWINGS FOR ADDITIONAL INFORMATION.
- 2.501 SALVAGE AND REINSTALL EXISTING LIGHTING ROD AFTER ROOF CONSTRUCTION.
- 4.210 BRICK MASONRY: MODULAR TYPE; REFER TO SPECIFICATIONS.
- 7.310 ASPHALT SHINGLE ROOFING SYSTEM: REFER TO SPECIFICATIONS.
- 7.311 ASPHALT SHINGLES.
- 7.460 FIBER CEMENT SIDING: VERTICAL SIDING PANEL WITH 1X2-1/2" BATTENS; SIMULATED ROUGH-SAWN WOOD GRAIN TEXTURE; COLOR FC1; REFER TO SPECIFICATIONS.
- 7.461 FIBER CEMENT SIDING: VERTICAL SIDING PANEL WITH 1X2-1/2" BATTENS; SIMULATED ROUGH-SAWN WOOD GRAIN TEXTURE; COLOR FC2; REFER TO SPECIFICATIONS.
- 7.463 FIBER CEMENT SIDING: BATTEN STRIPS; 3/4" X 2-1/2"; SIMULATED ROUGH-SAWN WOOD GRAIN TEXTURE; SPACED AT 7" O.C. U.N.O.
- 7.464 FIBER CEMENT SIDING: TRIM BOARD; 5/4" X 3-1/2" (ACTUAL); SIMULATED ROUGH-SAWN WOOD GRAIN TEXTURE; REFER TO SPECIFICATIONS.
- 7.466 FIBER CEMENT SIDING: TRIM BOARD; 5/4" X 5-1/2" (ACTUAL); SIMULATED ROUGH-SAWN WOOD GRAIN TEXTURE; REFER TO SPECIFICATIONS.
- 7.468 FIBER CEMENT SIDING: TRIM BOARD; 5/4" X 7-1/4" (ACTUAL); SIMULATED ROUGH-SAWN WOOD GRAIN TEXTURE; REFER TO SPECIFICATIONS.
- 7.469 FIBER CEMENT SIDING: TRIM BOARD; 5/4" X 9-1/4" (ACTUAL); SIMULATED ROUGH-SAWN WOOD GRAIN TEXTURE; REFER TO SPECIFICATIONS.
- 7.622 METAL FLASHING SYSTEM: FLASH CHIMNEY IN ACCORDANCE WITH SMACNA FIGURE 4-14.
- 7.631 METAL GUTTER: MATERIAL, THICKNESS AND FINISH AS SPECIFIED.
- 7.632 METAL DOWNSPOUT: MATERIAL, THICKNESS AND FINISH AS SPECIFIED.
- 8.141 WOOD EXTERIOR SWING ENTRANCE DOOR AND FRAME WITH APPLIED TRIM APPLICAE' TO MATCH EXISTING PROFILES; REFER TO DOOR, FRAME AND BORROWED LIGHT SCHEDULE.
- 8.142 METAL CLAD EXTERIOR WOOD SWING DOOR; REFER TO DOOR, FRAME AND BORROWED LIGHT SCHEDULE.
- 8.801 INSULATED GLASS UNITS: TOUCH UP STAINS ON WINDOW STRIPS AFTER INSTALLATION.
- 9.911 EXTERIOR PAINTING: PRIME AND TWO COATS PAINT ALL EXTERIOR GARAGE AND MAIN DOORS; REFER TO SPECIFICATIONS.
- 23.745 PROVIDE PENETRATIONS THROUGH EXTERIOR WALL FOR NEW MECHANICAL DUCTS; REFER TO MECHANICAL DRAWINGS.
- 26.000 LIGHT FIXTURE: REFER TO ELECTRICAL DRAWINGS.
- 26.001 LIGHT FIXTURE: EXTERIOR UP-DOWN LIGHT; REFER TO ELECTRICAL DRAWINGS.
- 32.022 PRECAST CONCRETE DIMENSIONAL STONE SEAT WALL STONE BASE; MIN. 18 INCHES THICK.
- 32.025 PRE-MANUFACTURED CHIMNEY W/ WOOD BOX; REFER TO SPECIFICATIONS.


GENERAL NOTES

1. REFER TO DRAWING G100 FOR PROJECT GENERAL NOTES.
2. PREP, 2 COAT PRIME & PAINT ALL TRIM, DOORS, UNDERSIDE OF ROOF RAFTER TAILS AND TONGUE & GROOVE DECKING. TYPICAL.


DOOR AND FRAME SCHEDULE

ROOM NO.	ROOM NAME	DOOR NO.	QTY.	DOOR										FRAME				DETAILS			HDWR SET	FIRE RATING (MIN.)	REMARKS											
				W	H	THK.	TYPE	HAND	MAT.	STEEL DOORS		WOOD DOORS				FINISH	GLASS	TYPE	MAT.	GA.				FINISH	GLASS	HEAD	JAMB	SILL						
										GA.	MDL.	CORE	GRD.	CORE	VEENER														CUT	MATCH				
100	EXISTING FOYER	100.1	2	3'-0"	6'-8"	1 3/4"	FD	RHR	-	-	-	-	-	-	-	-	-	-	-	-	6/A840	5/A840	-	1	-	-								
101	EXISTING FORMAL PARLOR	100.2	2	3'-0"	6'-8"	1 3/4"	FGB	RHR	WD	-	-	P	-	OR	R	RAN	SI	*	2	WD*	-	S1	-	2/A840	1/A840	-	1	-	-					
102	CORRIDOR	101.1	2	2'-10"	6'-8"	1 3/4"	FG	RHR	WD*	-	-	-	-	-	-	-	-	-	-	-	4/A840	3/A840	-	3	-	-								
103	WOMEN'S BATHROOM	103.1	1	3'-0"	6'-8"	1 3/4"	FA	RH	WD	-	-	P	-	OR	R	RAN	SI	-	1	WD*	-	S1	-	2/A840	1/A840	-	2	-	-					
104	MEN'S BATHROOM	104.1	1	3'-0"	6'-8"	1 3/4"	FA	LH	WD	-	-	P	-	OR	R	RAN	SI	-	1	WD*	-	S1	-	2/A840	1/A840	-	2	-	-					
105	NOT USED																																	
106	NOT USED																																	
107	EXISTING LIVING ROOM																																	
108	EXISTING STORAGE																																	
109	EXISTING STORAGE	109.2	1	3'-0"	6'-8"	1 3/4"	FG	RH	WD*	-	-	-	-	-	-	-	-	-	-	-	S1	*	1	WD*	-	P2	-	4/A840	3/A840	SIM	-	4	-	-
110	EXISTING CORRIDOR																																	
111	EXISTING BATHROOM																																	
112	EXISTING JANITOR'S CLOSET																																	
113	EXISTING DINING ROOM																																	
114	EXISTING KEEPING ROOM	114.1	2	2'-10"	6'-8"	1 3/4"	FG	RHR	WD*	-	-	-	-	-	-	-	-	-	-	-	-	S1	*	2	WD*	-	P2	-	4/A840	3/A840	-	3	-	-
115	EXISTING PANTRY																																	
116	EXISTING KITCHEN																																	
117	EXISTING GREEN HOUSE	117.1	1	2'-8"	6'-8"	1 3/4"	FG	RHR	WD*	-	-	-	-	-	-	-	-	-	-	-	-	S1	*	1	WD*	-	P2	-	4/A840	SIM.3/A840	SIM	-	-	
		117.2	1	2'-8"	6'-8"	1 3/4"	FG	LHR	WD*	-	-	-	-	-	-	-	-	-	-	-	-	S1	*	1	WD*	-	P2	-	4/A840	SIM.3/A840	SIM	-	-	
118	EXISTING FOYER	118.1	1	3'-0"	6'-8"	1 3/4"	FG	RHR	WD*	-	-	-	-	-	-	-	-	-	-	-	-	S1	*	1	WD*	-	P2	-	4/A840	SIM.3/A840	SIM	-	-	
119	EXISTING GARAGE																																	
120	EXISTING STORAGE																																	
203.1	EXISTING CLOSET	203.1	1	2'-8"	6'-8"	1 3/4"	F	RHR	WD*	-	-	-	-	-	-	-	-	-	-	-	-	S1	-	1	WD*	-	P2	-	4/A840	SIM.3/A840	SIM	-	-	


DOOR TYPES

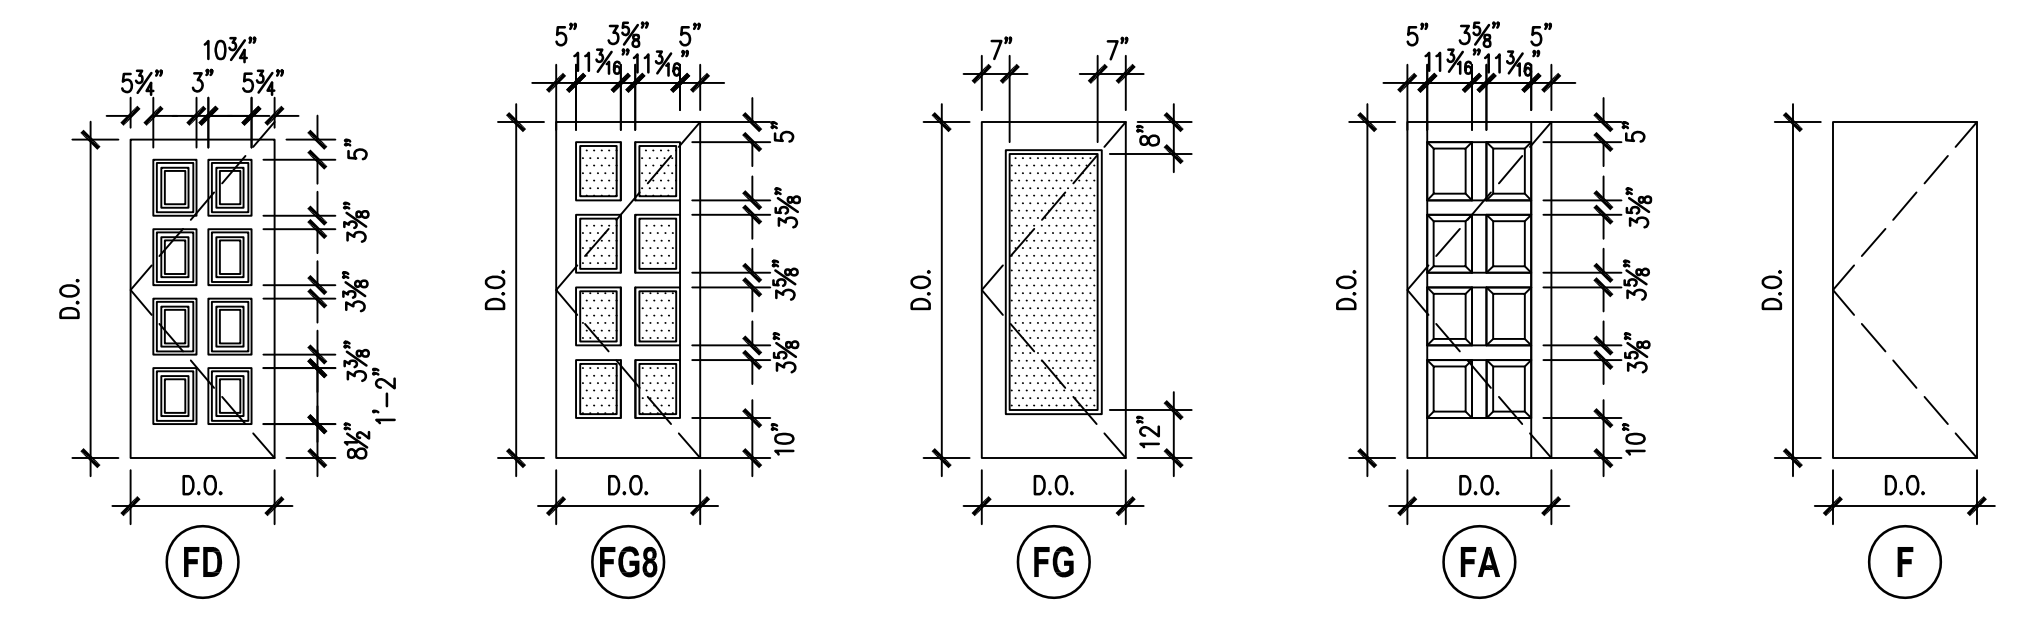

FRAME TYPES

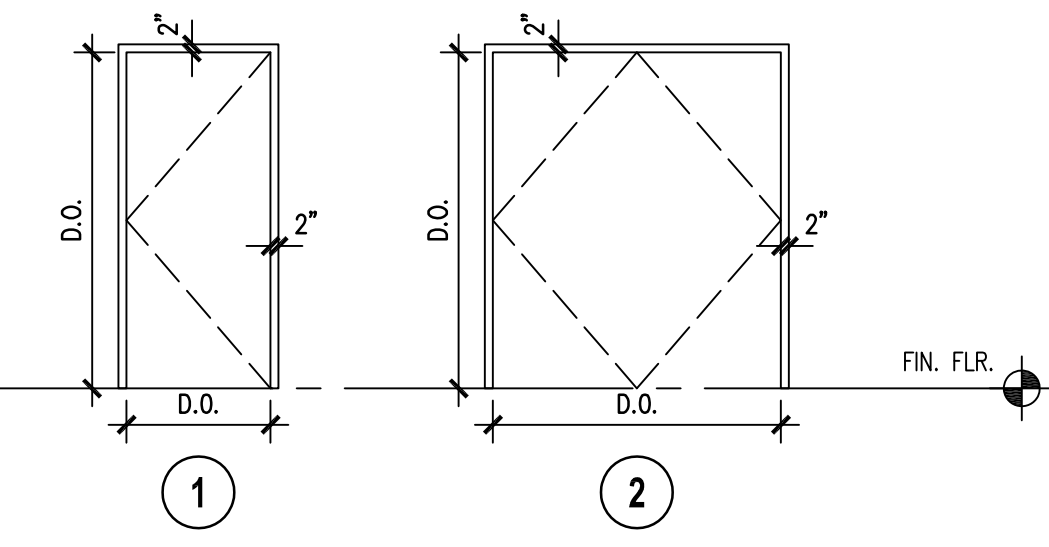

WINDOW TYPES

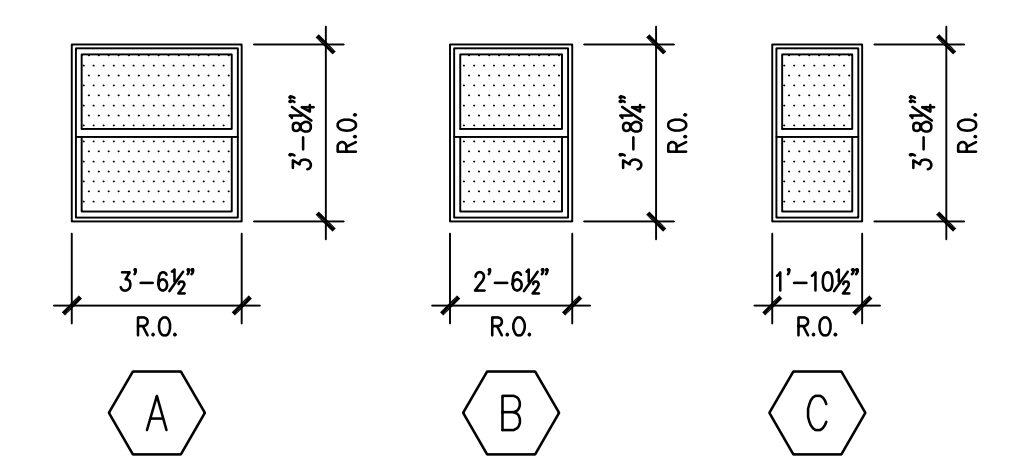

DOOR HARDWARE SCHEDULE

SET NO.	HINGES	LOCK SET	EXIT DEVICE	CLOSER	HOLDER	STOP	THRES-HOLD	KICK PLATE	MOP PLATE	WEATHER STRIPPING	SWEEP	PUSH/PULL	REMOV. MULLION	REMARKS
1	BUTTS	YES	YES	YES	YES	YES	YES	-	-	YES	YES	-	YES	1
2	BUTTS	-	-	YES	-	YES	-	-	-	-	-	-	YES	2
3	BUTTS	YES	YES	YES	YES	YES	YES	-	-	YES	YES	-	YES	3
4	BUTTS	YES	-	-	-	-	YES	-	-	YES	YES	-	-	4

DOOR SCHEDULE REMARKS

1. PREP DOOR AND FRAME FOR ELECTRIC STRIKE.

HARDWARE SCHEDULE REMARKS

- PROVIDE EXIT DEVICE.
- PROVIDE CLOSER WITH CUSHION STOP FUNCTION.
- PROVIDE REMOVABLE MULLION.
-

DOOR SCHEDULE ABBREVIATIONS

DOOR / FRAME MATERIAL	STEEL DOOR GAGE	WOOD DOOR GRADE	WOOD DOOR VENEER CUTS
AL ALUMINUM	20 LEVEL 1 - STD. DUTY	P PREMIUM	PS PLAIN SLICED
STL STEEL	18 LEVEL 2 - HEAVY DUTY	C CUSTOM	QS QUARTER SLICED
WD WOOD	16 LEVEL 3 - EXTRA HVY. DUTY	E ECONOMY	RC RIFT CUT
SPECIAL DOOR TYPES	14 LEVEL 4 - MAXIMUM DUTY	W WOOD DOOR CORE	R ROTARY CUT
AC ACCORDION		HC HONEYCOMB	
AP ACCESS PANEL	1 FULL FLUSH	MB MINERAL BOARD	WOOD DOOR VENEER MATCHING
DK DARKROOM REVOLVING	2 SEAMLESS	PCS 5-PLY PARTICLE BOARD	BK BOOK MATCH
HS OVERHEAD HIGH-SPEED	3 STILE & RAIL	SC SOUND-RATED	SL SLIP MATCH
OR OVERHEAD ROLLING			RAN RANDOM MATCH
OS OVERHEAD SECTIONAL			E END MATCH
RV REVOLVING			
SG OVERHEAD SECURITY GRILLE	MB MINERAL BOARD	BW BIRCH - WHITE (SAPWOOD)	CON CONTINUOUS MATCH
DOOR / FRAME FINISHES	PS POLYSTYRENE	HB PRIMED HARDBOARD	RUN RUNNING MATCH
	PU POLYURETHANE	HPDL DECORATIVE LAMINATE	BAL BALANCE MATCH
	SS STEEL STIFFENERS	MW MAPLE - WHITE (SAPWOOD)	CB CENTER BALANCE MATCH
P_ PAINTED - SEE FIN. SCHED.		OR RED OAK	P PAIR MATCH
S_ STAINED - SEE FIN. SCHED.		OW WHITE OAK	S SET MATCH
		PO POPLAR	

HARDWARE MOUNTING HEIGHTS

HARDWARE COMPONENT	PREFERRED MOUNTING HEIGHT FROM BOTTOM OF DOOR FRAME	ACCEPTABLE RANGE IF PREFERRED MOUNTING HEIGHT NOT POSSIBLE
LOOKSETS, LATCHSETS	39" TO CENTERLINE OF LEVER	38" TO 42"
EXIT DEVICES	39" TO CENTERLINE OF PUSH PAD	38" TO 42"
DEADBOLT LOCKS	46" TO CENTERLINE OF CYLINDER	30" TO 48"
PUSH PLATES	45" TO CENTERLINE OF PUSH PLATE	N/A
PULLS, COMBINATION PUSH/PULL BARS	42" TO CENTERLINE OF PULL/BAR	N/A
ROLLER LATCHES	45" TO CENTERLINE OF LATCH STRIKE	N/A

KEYNOTES

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GENERAL NOTES

- REFER TO A400 SERIES REFLECTED CEILING PLANS FOR CEILING HEIGHTS.
- REFER TO ROOM FINISH SCHEDULE FOR SPECIFIC DOOR AND FRAME FINISHES AND GLAZING TYPES.
- PROVIDE FRP FACED ALUMINUM DOORS IN ALUMINUM FRAMES.

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KENDALL COUNTY FOREST PRESERVE DISTRICT
110 W. MADISON STREET
YORKVILLE, IL 60560

ISSUED	
01/06/22	BID DOCUMENTS

JOB NO.	19-429-1250
DRAWN	SKF
CHECKED	CJH
APPROVED	CJH

SHEET TITLE
DOOR, FRAME & HARDWARE SCHEDULES


SHEET NUMBER

A800


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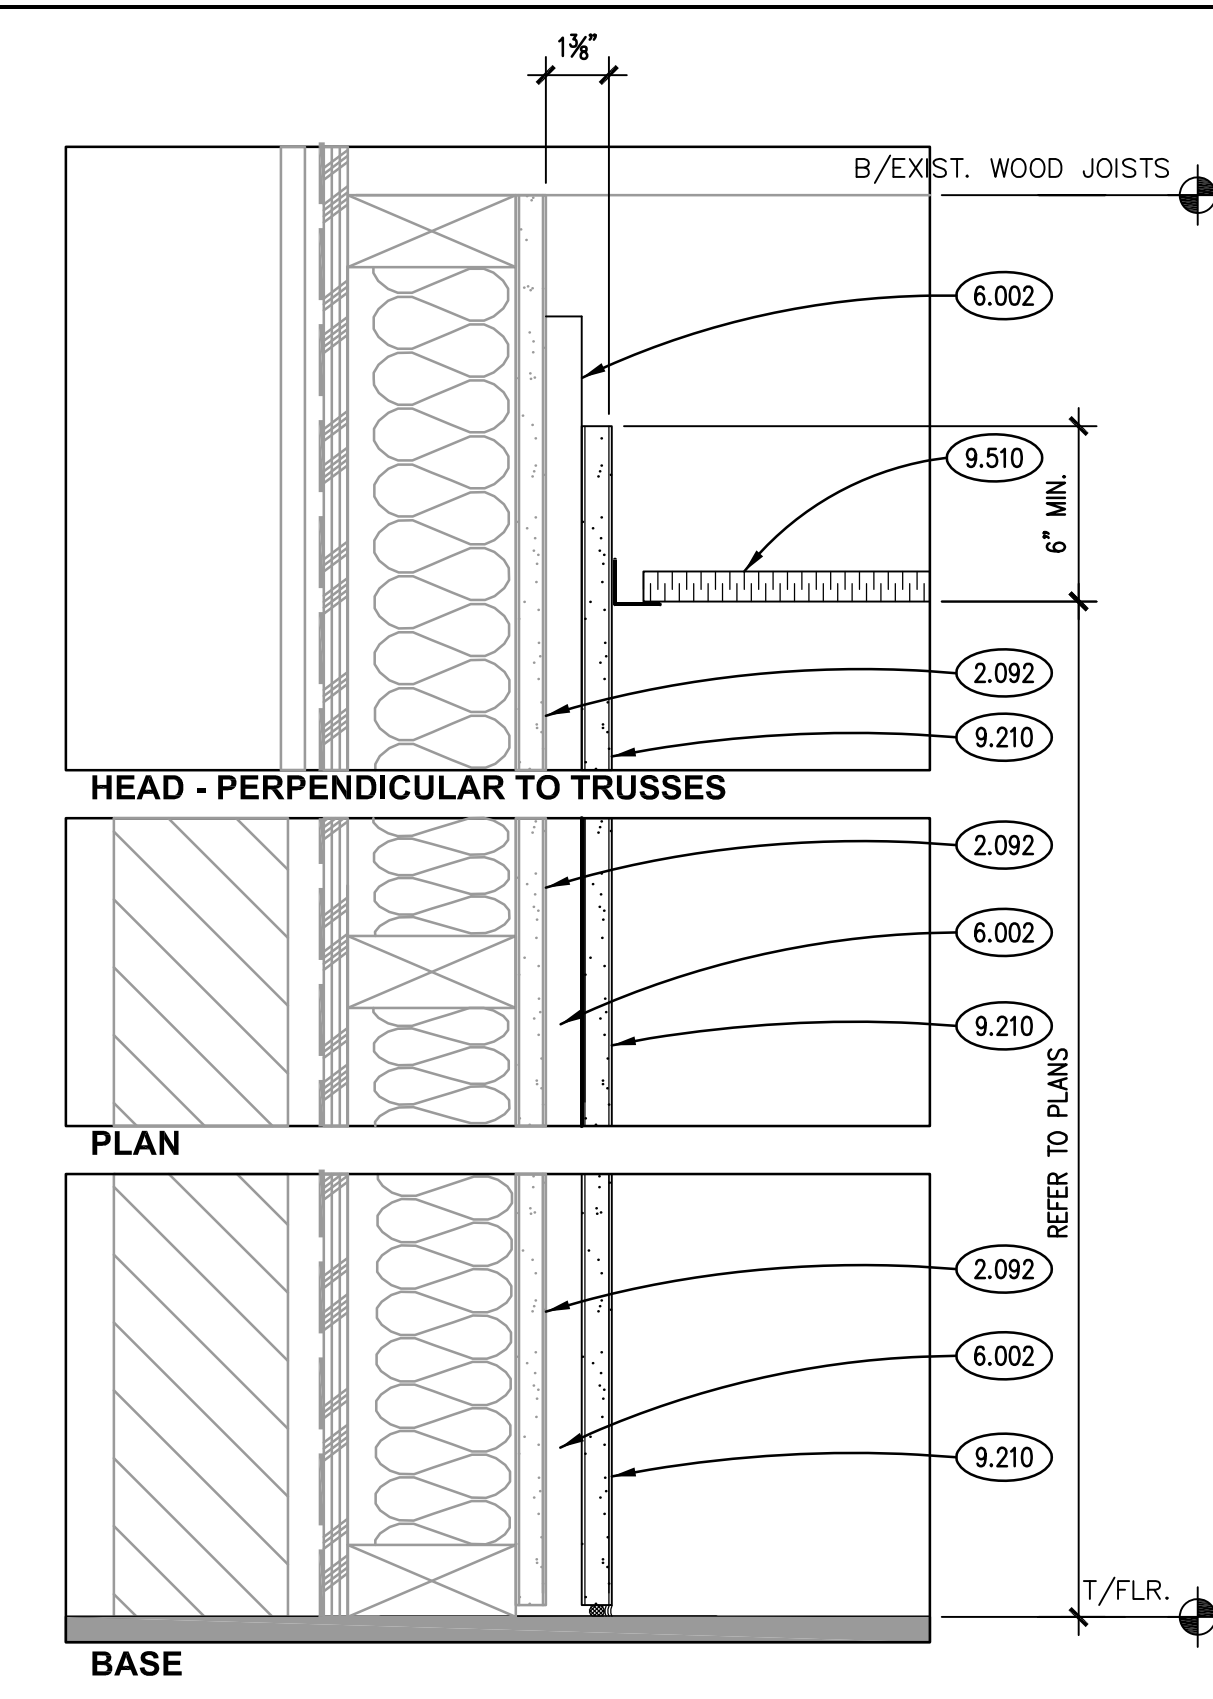
- 2.040 EXISTING BRICK VENEER.
- 2.064 EXISTING PLYWOOD SHEATHING.
- 2.080 EXISTING WINDOW.
- 2.091 EXISTING DRYWALL CONSTRUCTION.
- 2.092 EXISTING GYPSUM BOARD.
- 6.002 ROUGH CARPENTRY: WOOD BLOCKING; DIMENSIONAL LUMBER; SIZE AS REQUIRED; REFER TO SCHEDULE FOR TREATMENT.
- 6.007 ROUGH CARPENTRY: PLYWOOD; 3/4" THICK; FIELD PAINTED BLACK PRIOR TO INSTALLATION; REFER TO SPECIFICATIONS.
- 6.014 DIMENSIONAL LUMBER: STUD FRAMING; 2X4 @ 16" O.C.
- 6.204 FINISH CARPENTRY: SOFTWOOD TRIM; 3/4" x 3" (ACTUAL); REFER TO SPECIFICATIONS.
- 6.205 FINISH CARPENTRY: SOFTWOOD TRIM; 3/4" x 4-1/2" (ACTUAL); REFER TO SPECIFICATIONS.
- 6.206 FINISH CARPENTRY: SOFTWOOD TRIM; 3/4" x 5-1/2" (ACTUAL); REFER TO SPECIFICATIONS.
- 6.207 FINISH CARPENTRY: SOFTWOOD TRIM; 3/4" x 6" (ACTUAL); REFER TO SPECIFICATIONS.
- 7.252 WEATHER BARRIER SHEET MEMBRANE; REFER TO SPECIFICATIONS.
- 7.462 FIBER CEMENT SIDING; 5/16" THK; VERTICAL SIDING PANEL; REFER TO SPECIFICATIONS.
- 7.464 FIBER CEMENT SIDING; TRIM BOARD; 5/4" x 3-1/2" (ACTUAL); SIMULATED ROUGH-SAWN WOOD GRAIN TEXTURE; REFER TO SPECIFICATIONS.
- 7.466 FIBER CEMENT SIDING; TRIM BOARD; 5/4" x 5-1/2" (ACTUAL); SIMULATED ROUGH-SAWN WOOD GRAIN TEXTURE; REFER TO SPECIFICATIONS.
- 7.468 FIBER CEMENT SIDING; TRIM BOARD; 5/4" x 7-1/4" (ACTUAL); SIMULATED ROUGH-SAWN WOOD GRAIN TEXTURE; REFER TO SPECIFICATIONS.
- 7.469 FIBER CEMENT SIDING; TRIM BOARD; 5/4" x 9-1/4" (ACTUAL); SIMULATED ROUGH-SAWN WOOD GRAIN TEXTURE; REFER TO SPECIFICATIONS.
- 8.142 METAL CLAD EXTERIOR WOOD SWING DOOR; REFER TO DOOR, FRAME AND BORROWED LIGHT SCHEDULE.
- 8.413 STILE AND RAIL WOOD INTERIOR DOOR; REFER TO DOOR, FRAME AND BORROWED LIGHT SCHEDULE.
- 9.210 GYPSUM BOARD; 5/8" THICK; TYPE "X".
- 9.214 GYPSUM BOARD ACCESSORY: ACOUSTICAL SEALANT.
- 9.215 GYPSUM BOARD ACCESSORY: ACOUSTICAL INSULATION; SOUND ATTENUATION BATTS; THICKNESS AS SPECIFIED.
- 9.510 ACOUSTICAL CEILING PANELS AND GRID.




NON-RATED PARTITION G5o
SCALE: 3" = 1'-0"

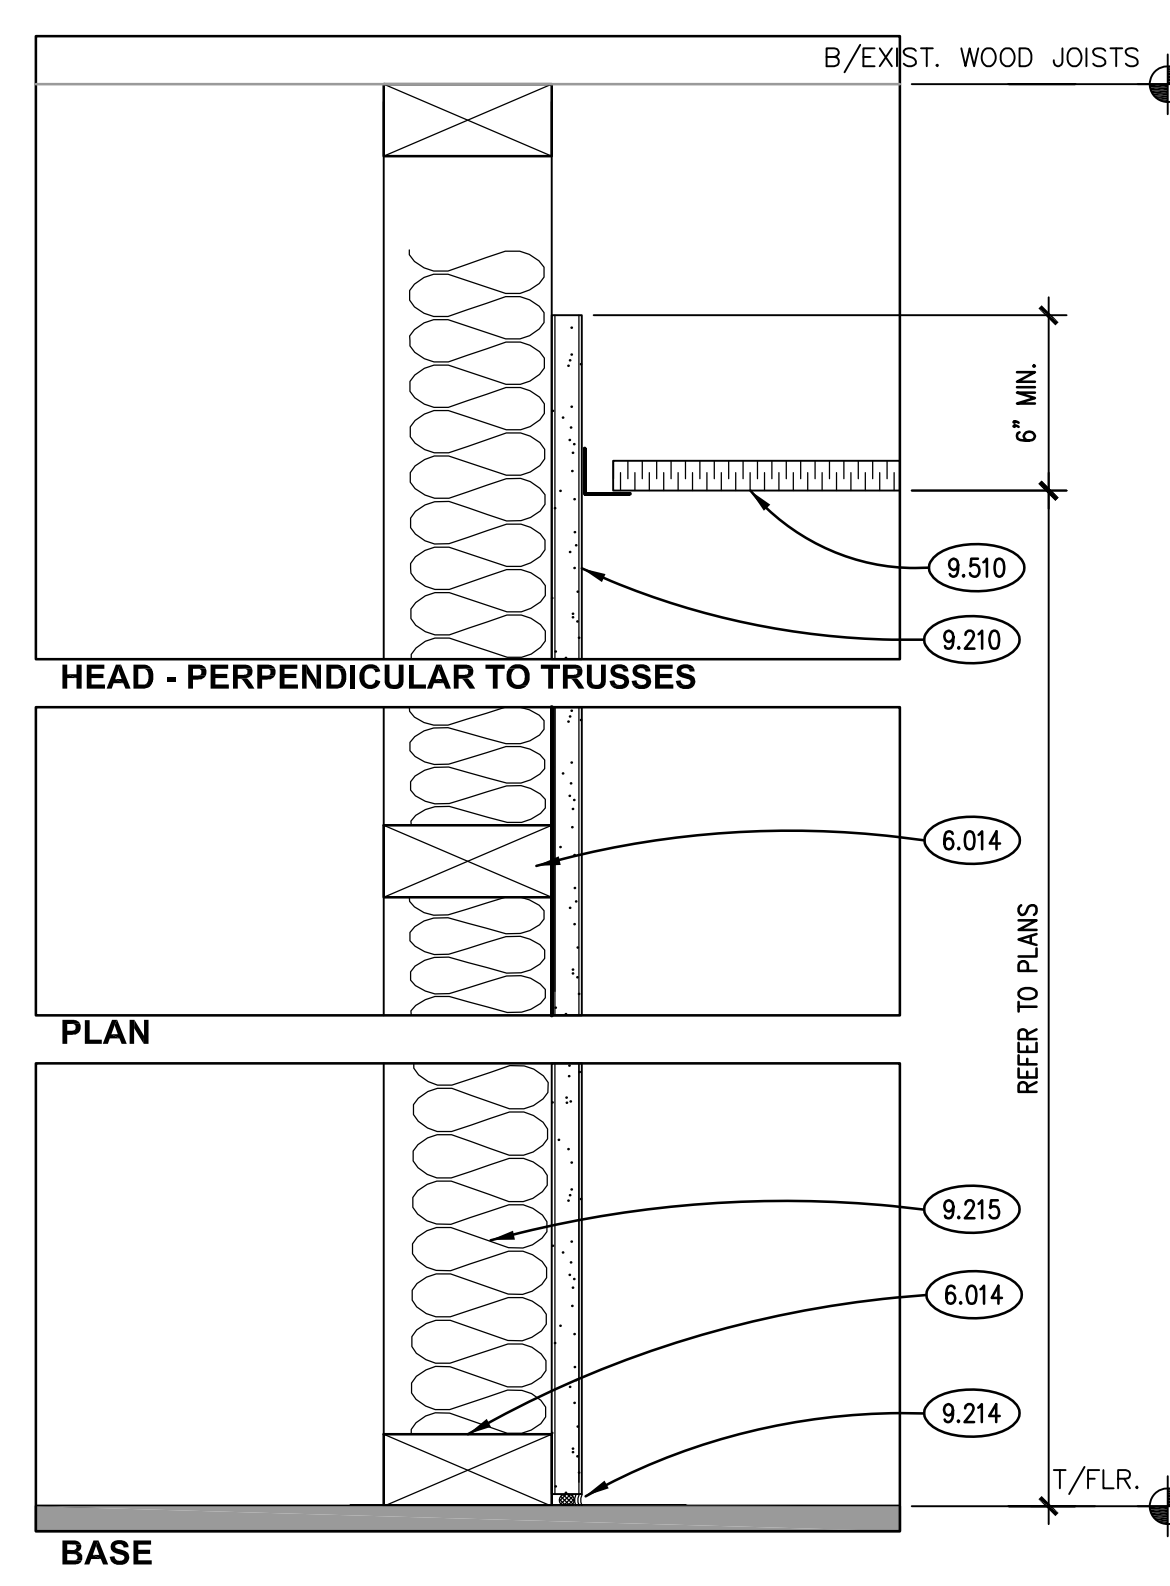


NON-RATED PARTITION G5e
SCALE: 3" = 1'-0"

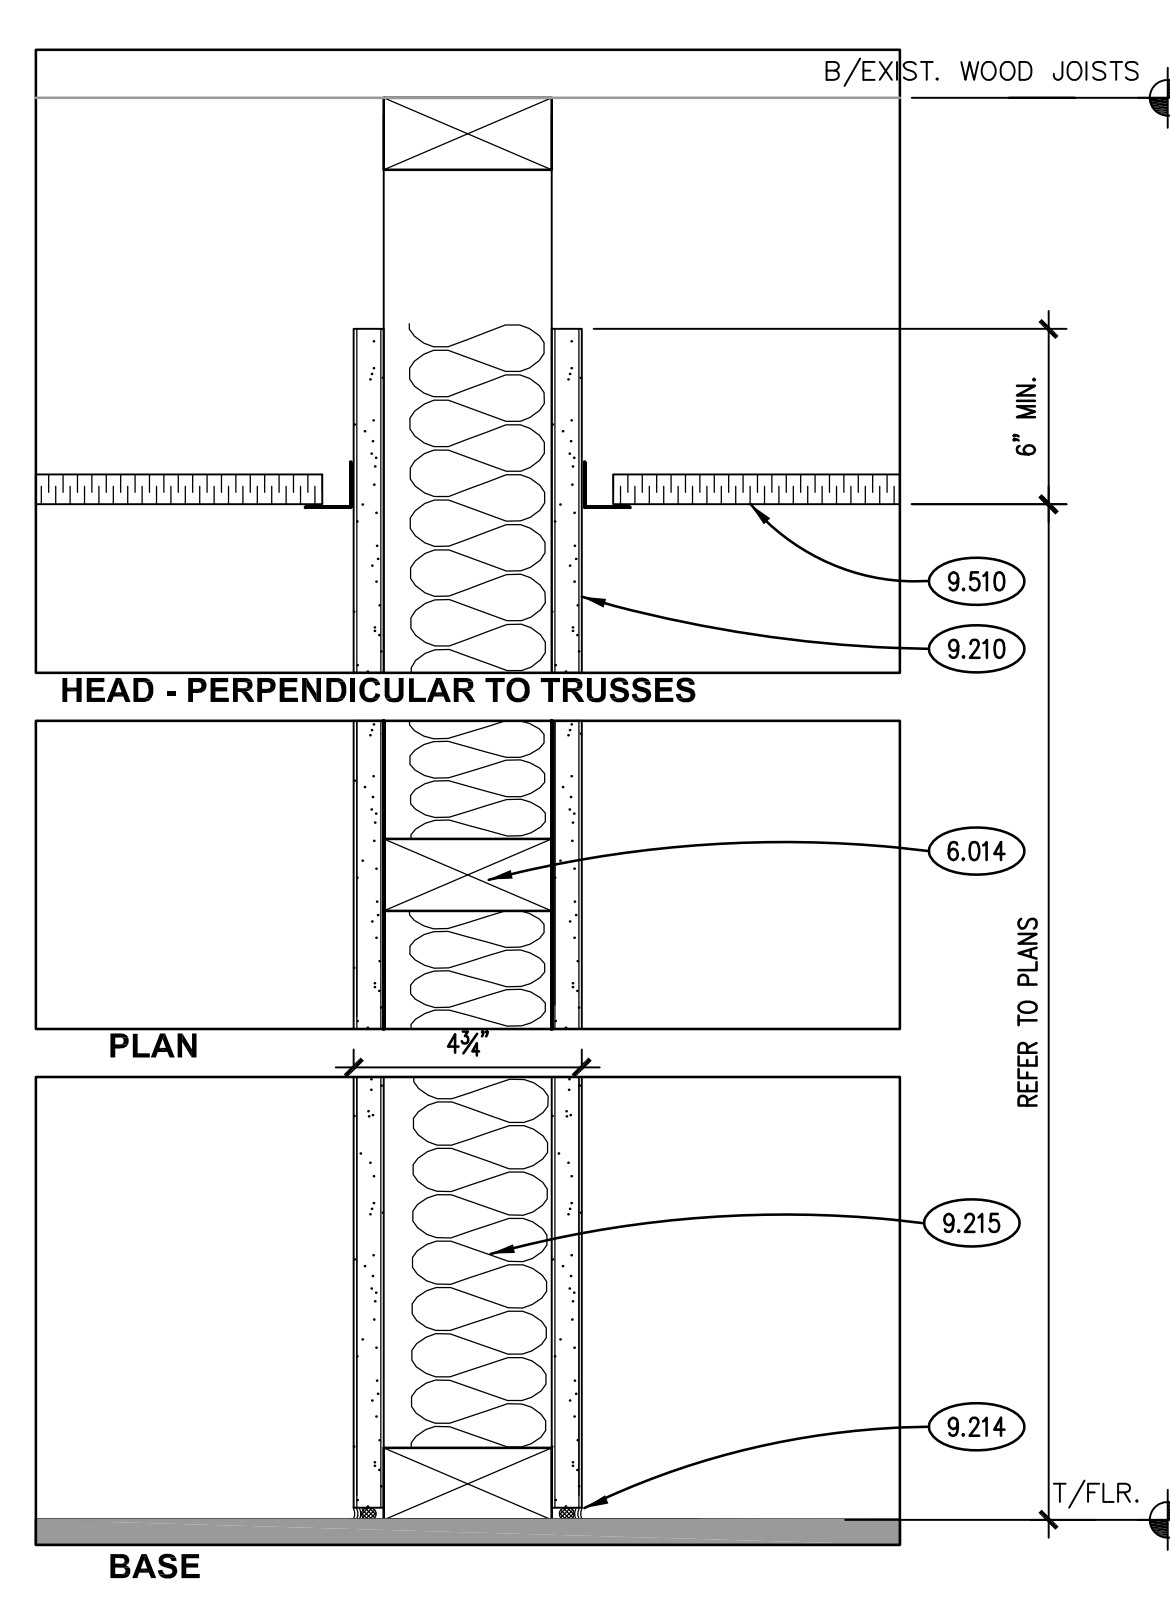


NON-RATED PARTITION G1
SCALE: 3" = 1'-0"

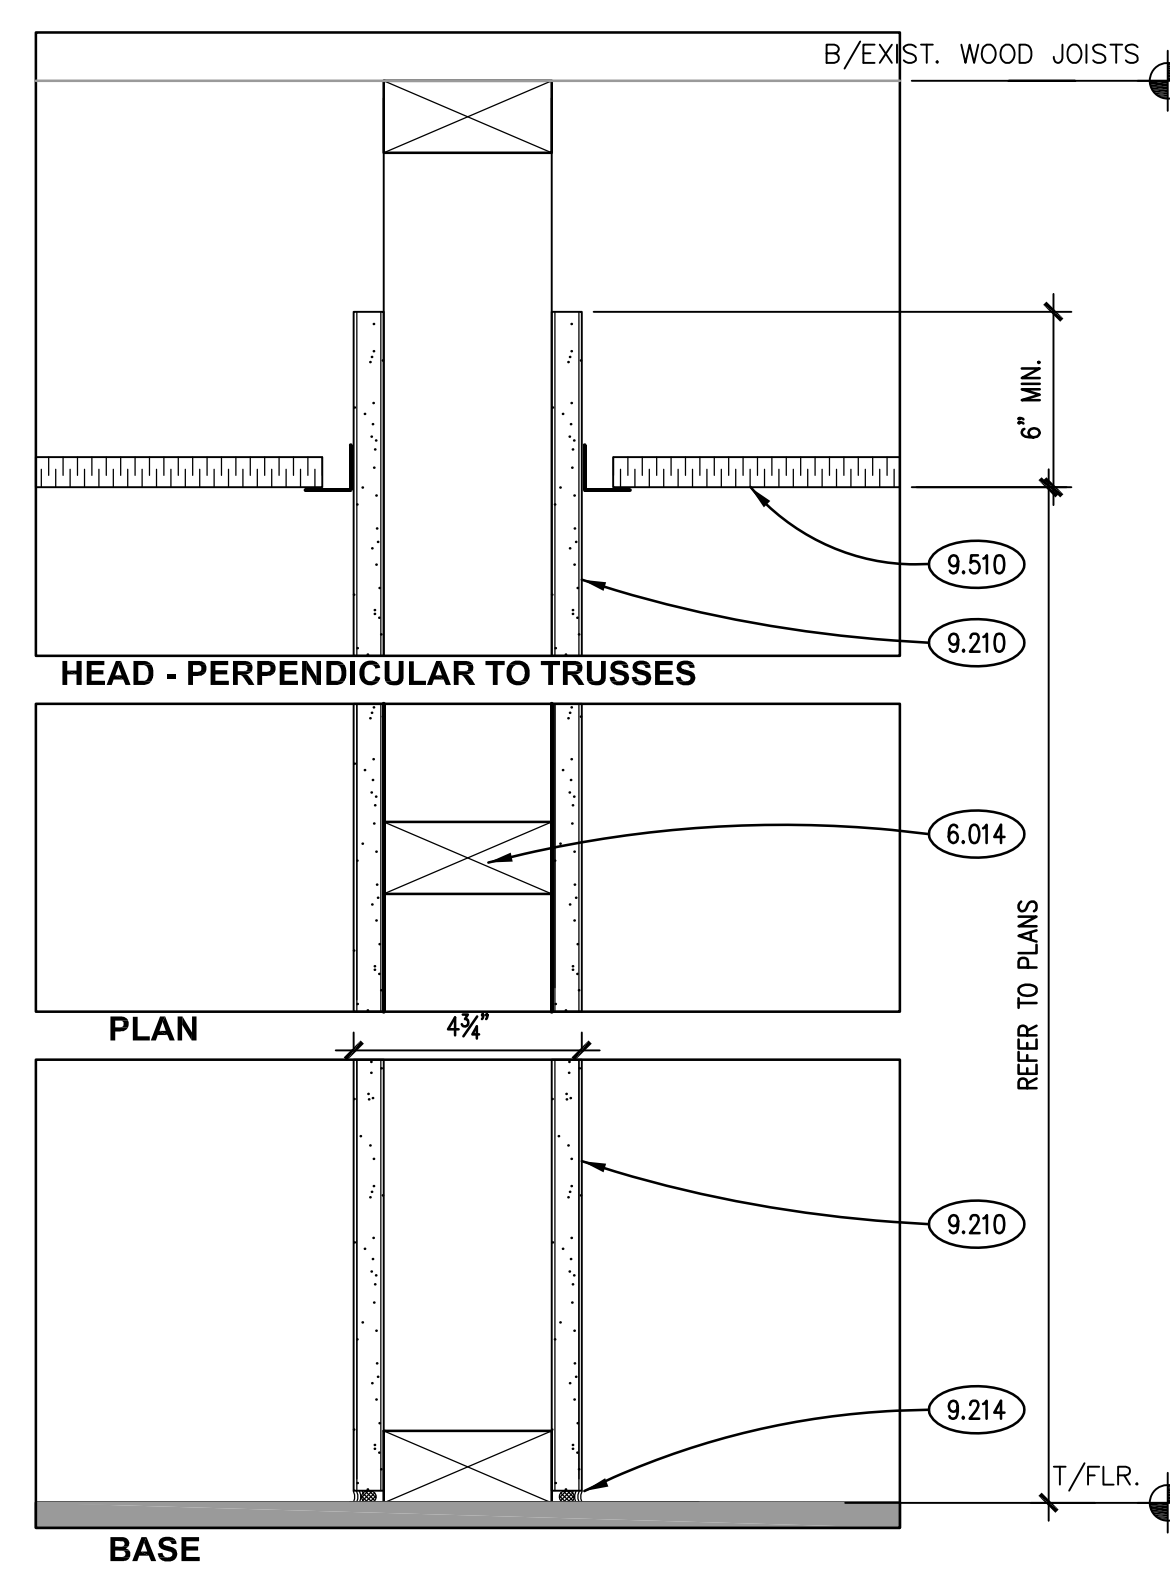


NON-RATED PARTITION G5
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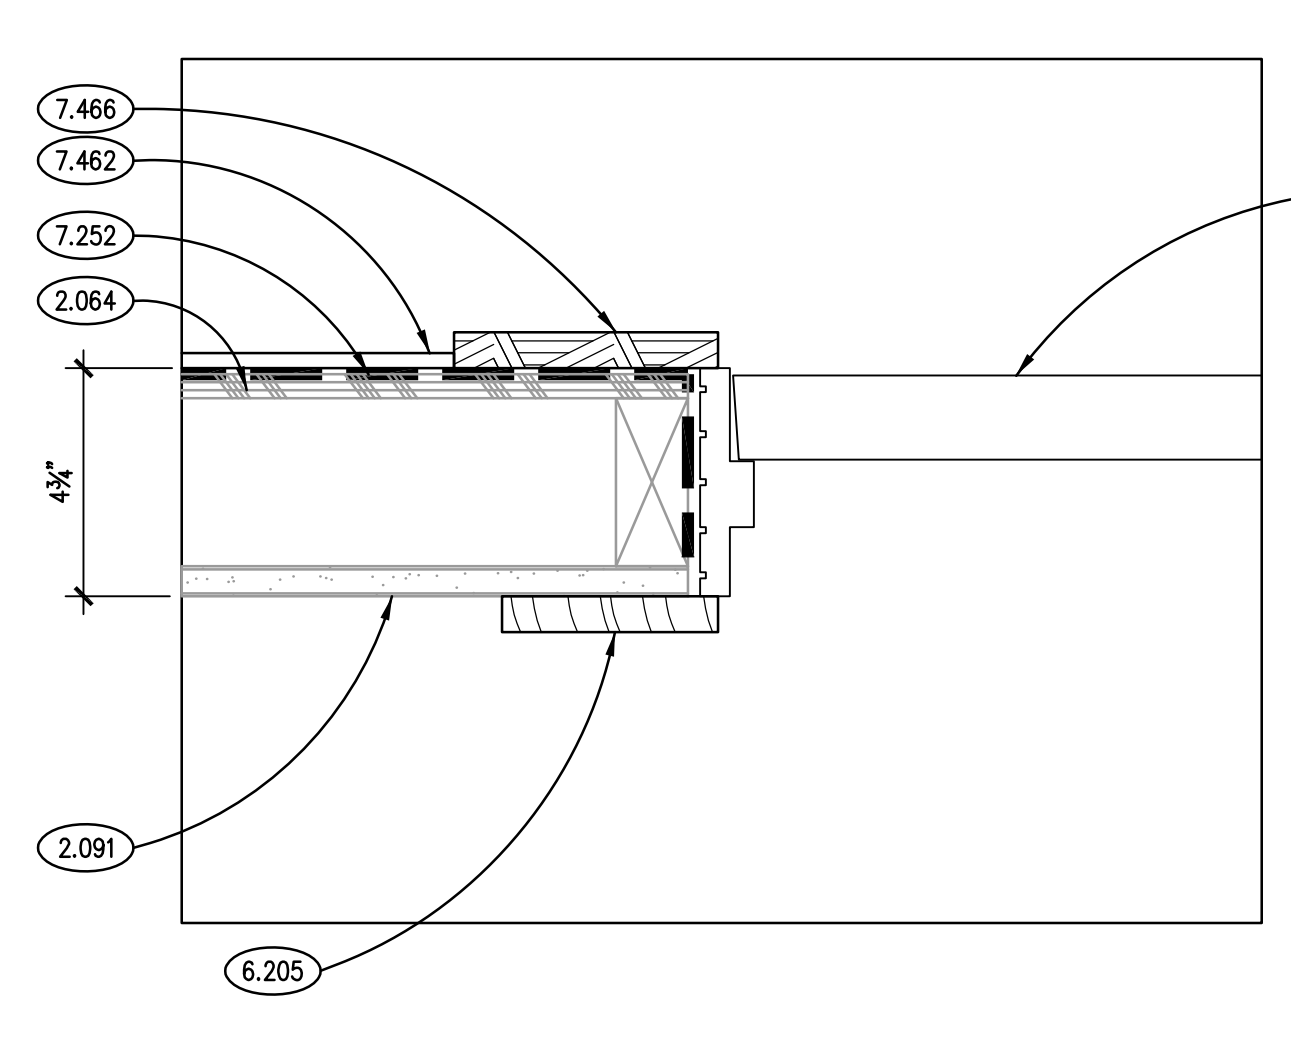
NOT USED 8
SCALE: 3" = 1'-0"

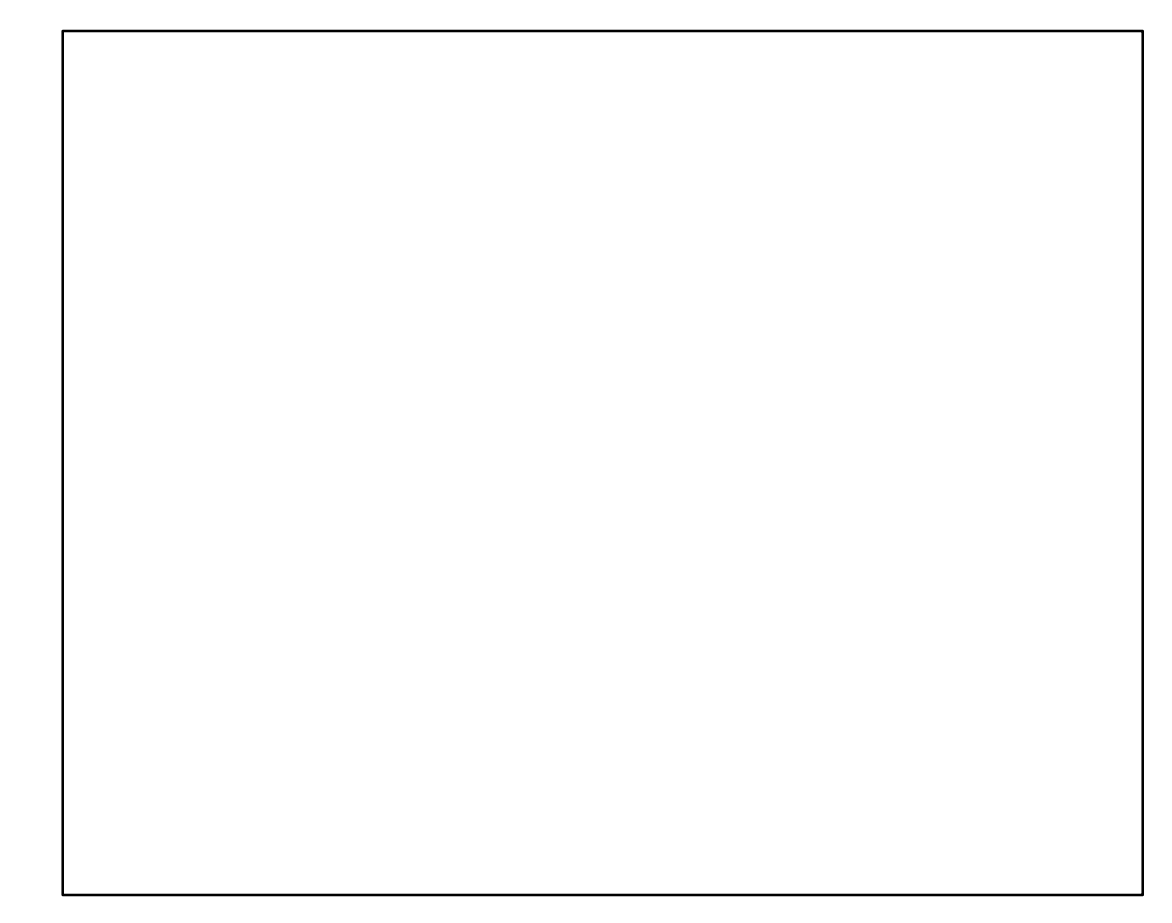


PLAN DETAIL 7
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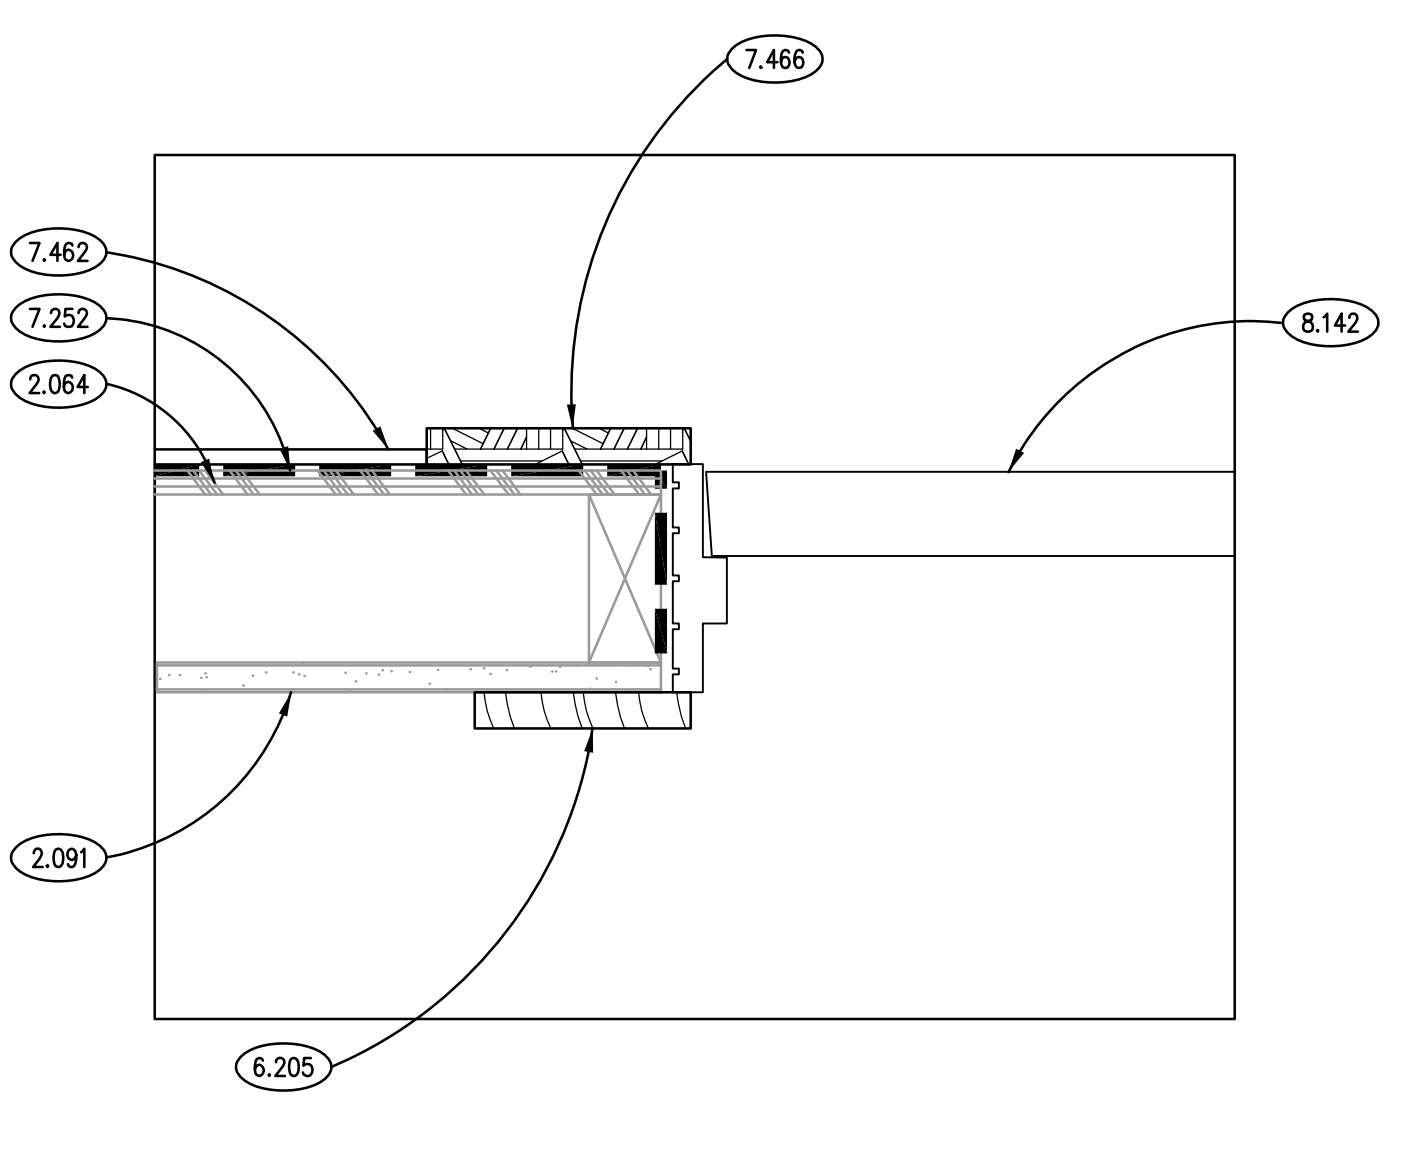
DETAIL 6
SCALE: 3" = 1'-0"

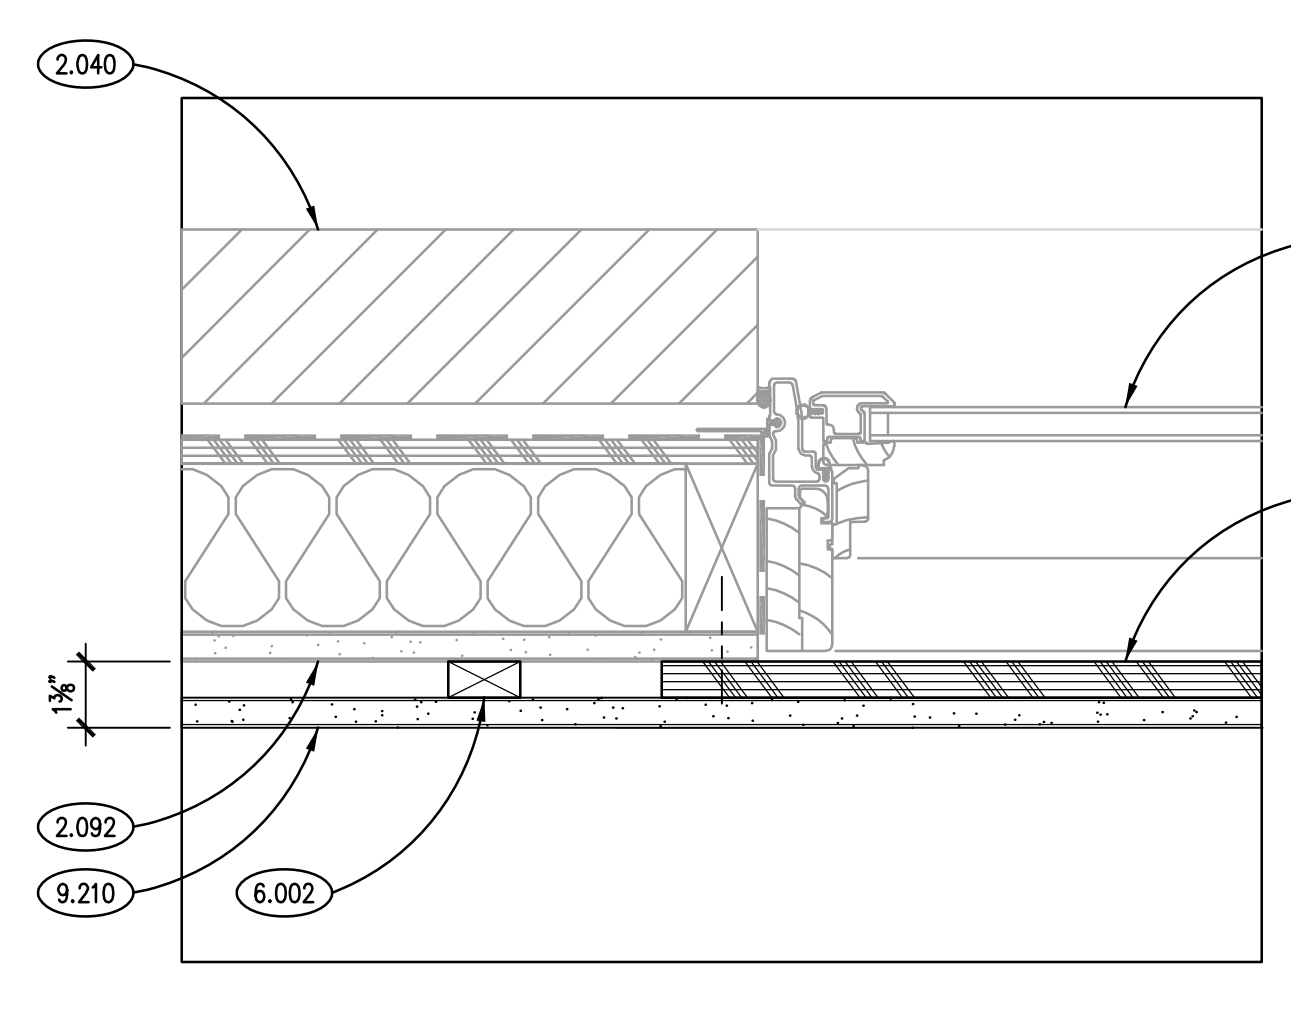


DETAIL 5
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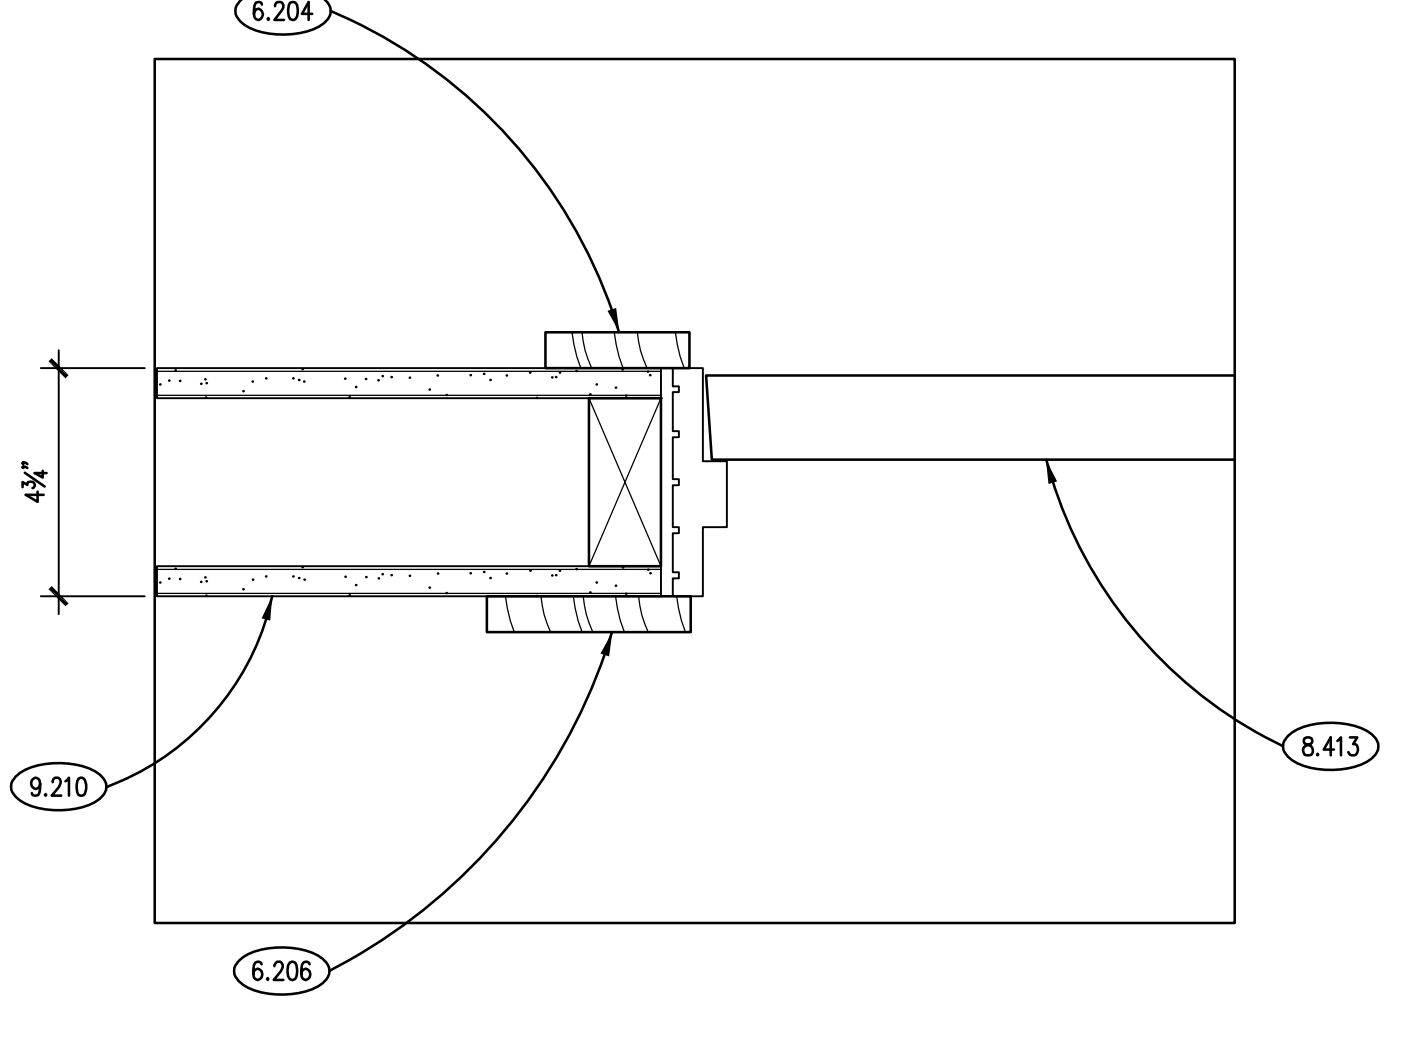
HEAD DETAIL 4
SCALE: 3" = 1'-0"

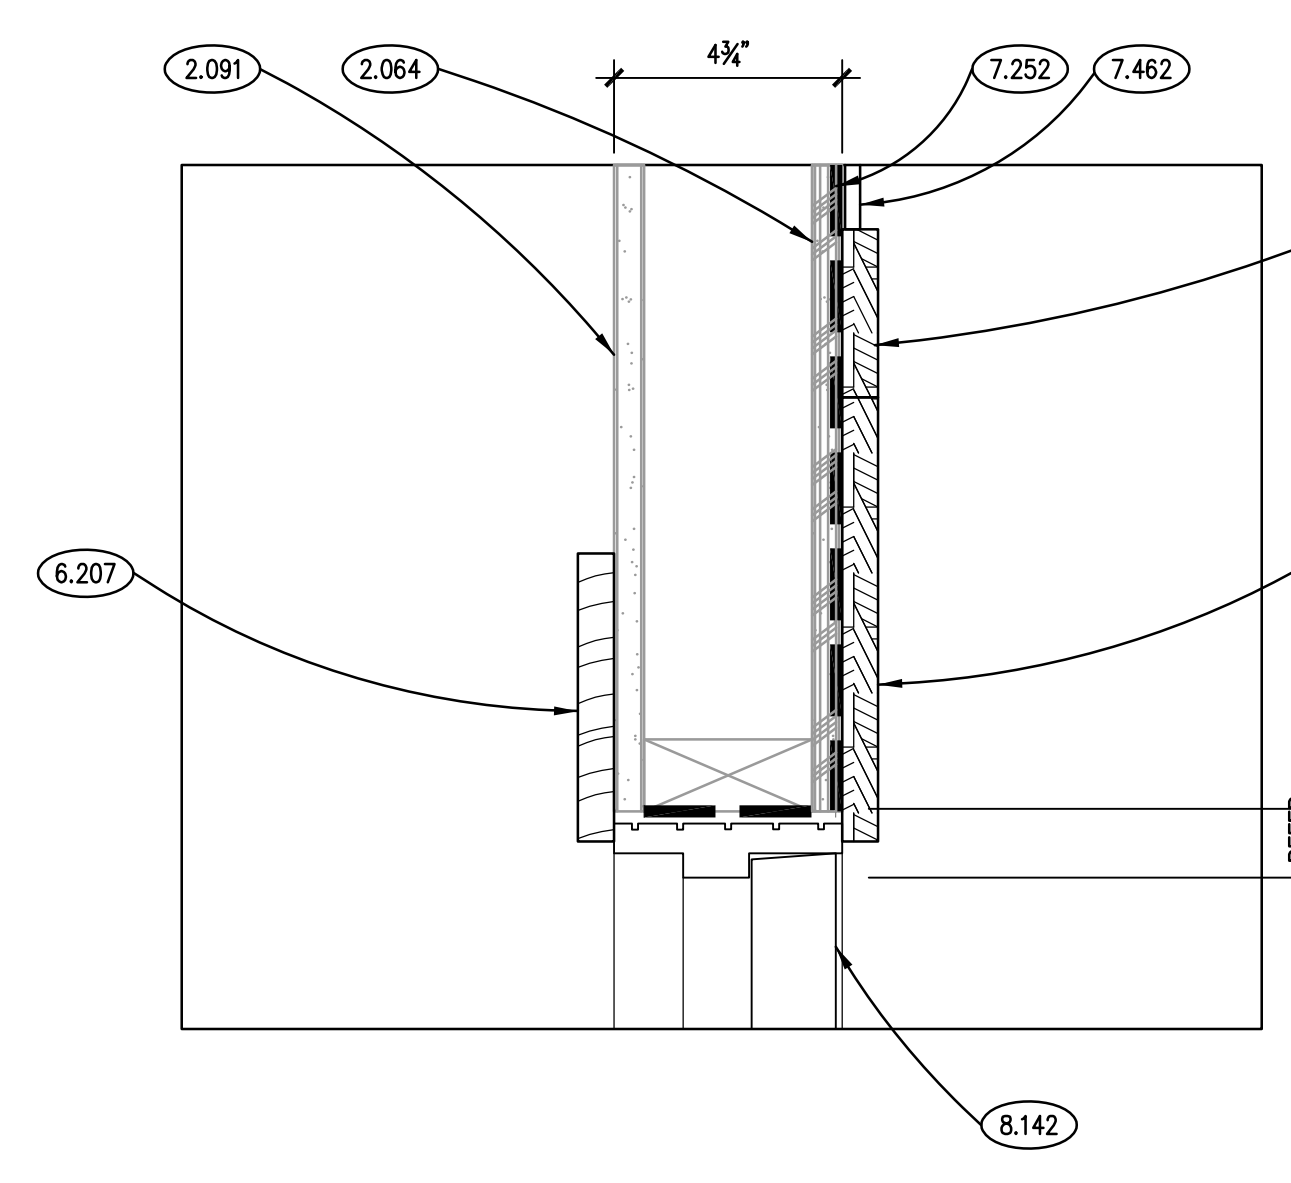

JAMB DETAIL 3
SCALE: 3" = 1'-0"

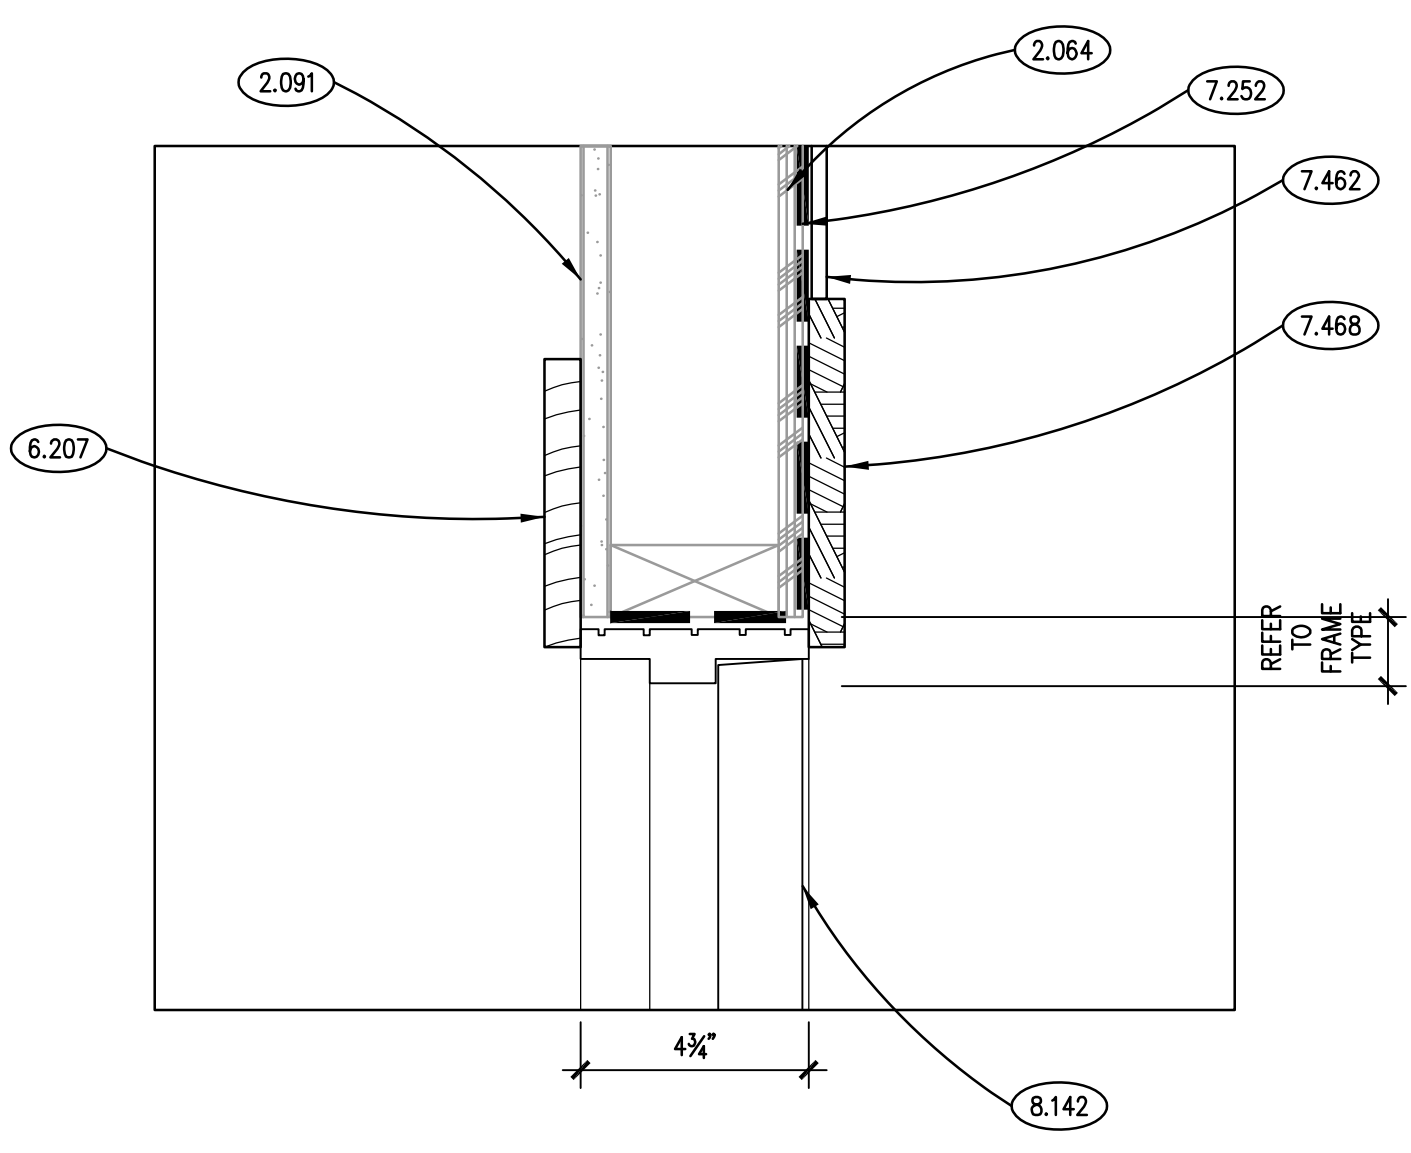

HEAD DETAIL 2
SCALE: 3" = 1'-0"

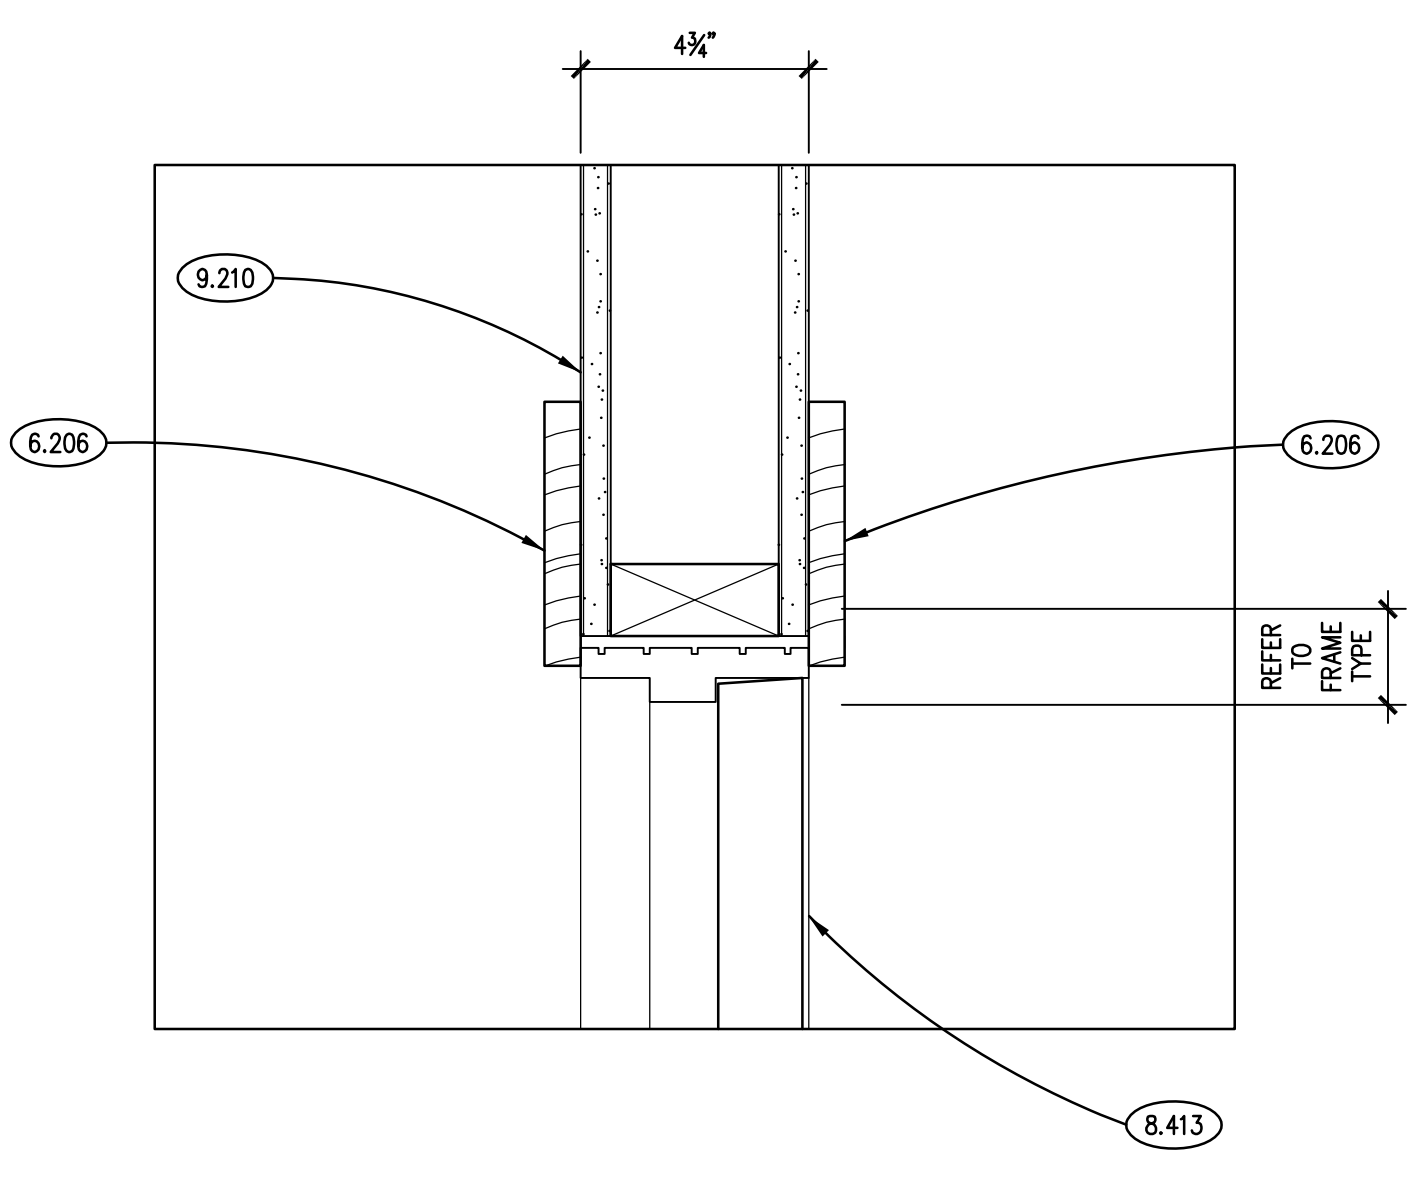


JAMB DETAIL 1
SCALE: 3" = 1'-0"

GENERAL NOTES

1. REFER TO DRAWING G100 FOR PROJECT GENERAL NOTES.
2. PREP. 2 COAT PRIME & PAINT ALL TRIM, DOORS, UNDERSIDE OF ROOF RAFTER TAILS AND TONGUE & GROOVE DECKING, TYPICAL.

ISSUED	
01/06/22	BID DOCUMENTS
JOB NO.	19-429-1250
DRAWN	SKF
CHECKED	CJH
APPROVED	CJH
SHEET TITLE	
INTERIOR PARTITIONS & DOOR DETAILS	
SHEET NUMBER	


NOTE: SCALES DEPICTED ON THIS DRAWING ARE NOT CORRECT UNLESS PLOTTED SHEET SIZE IS 30 X 42 INCHES.

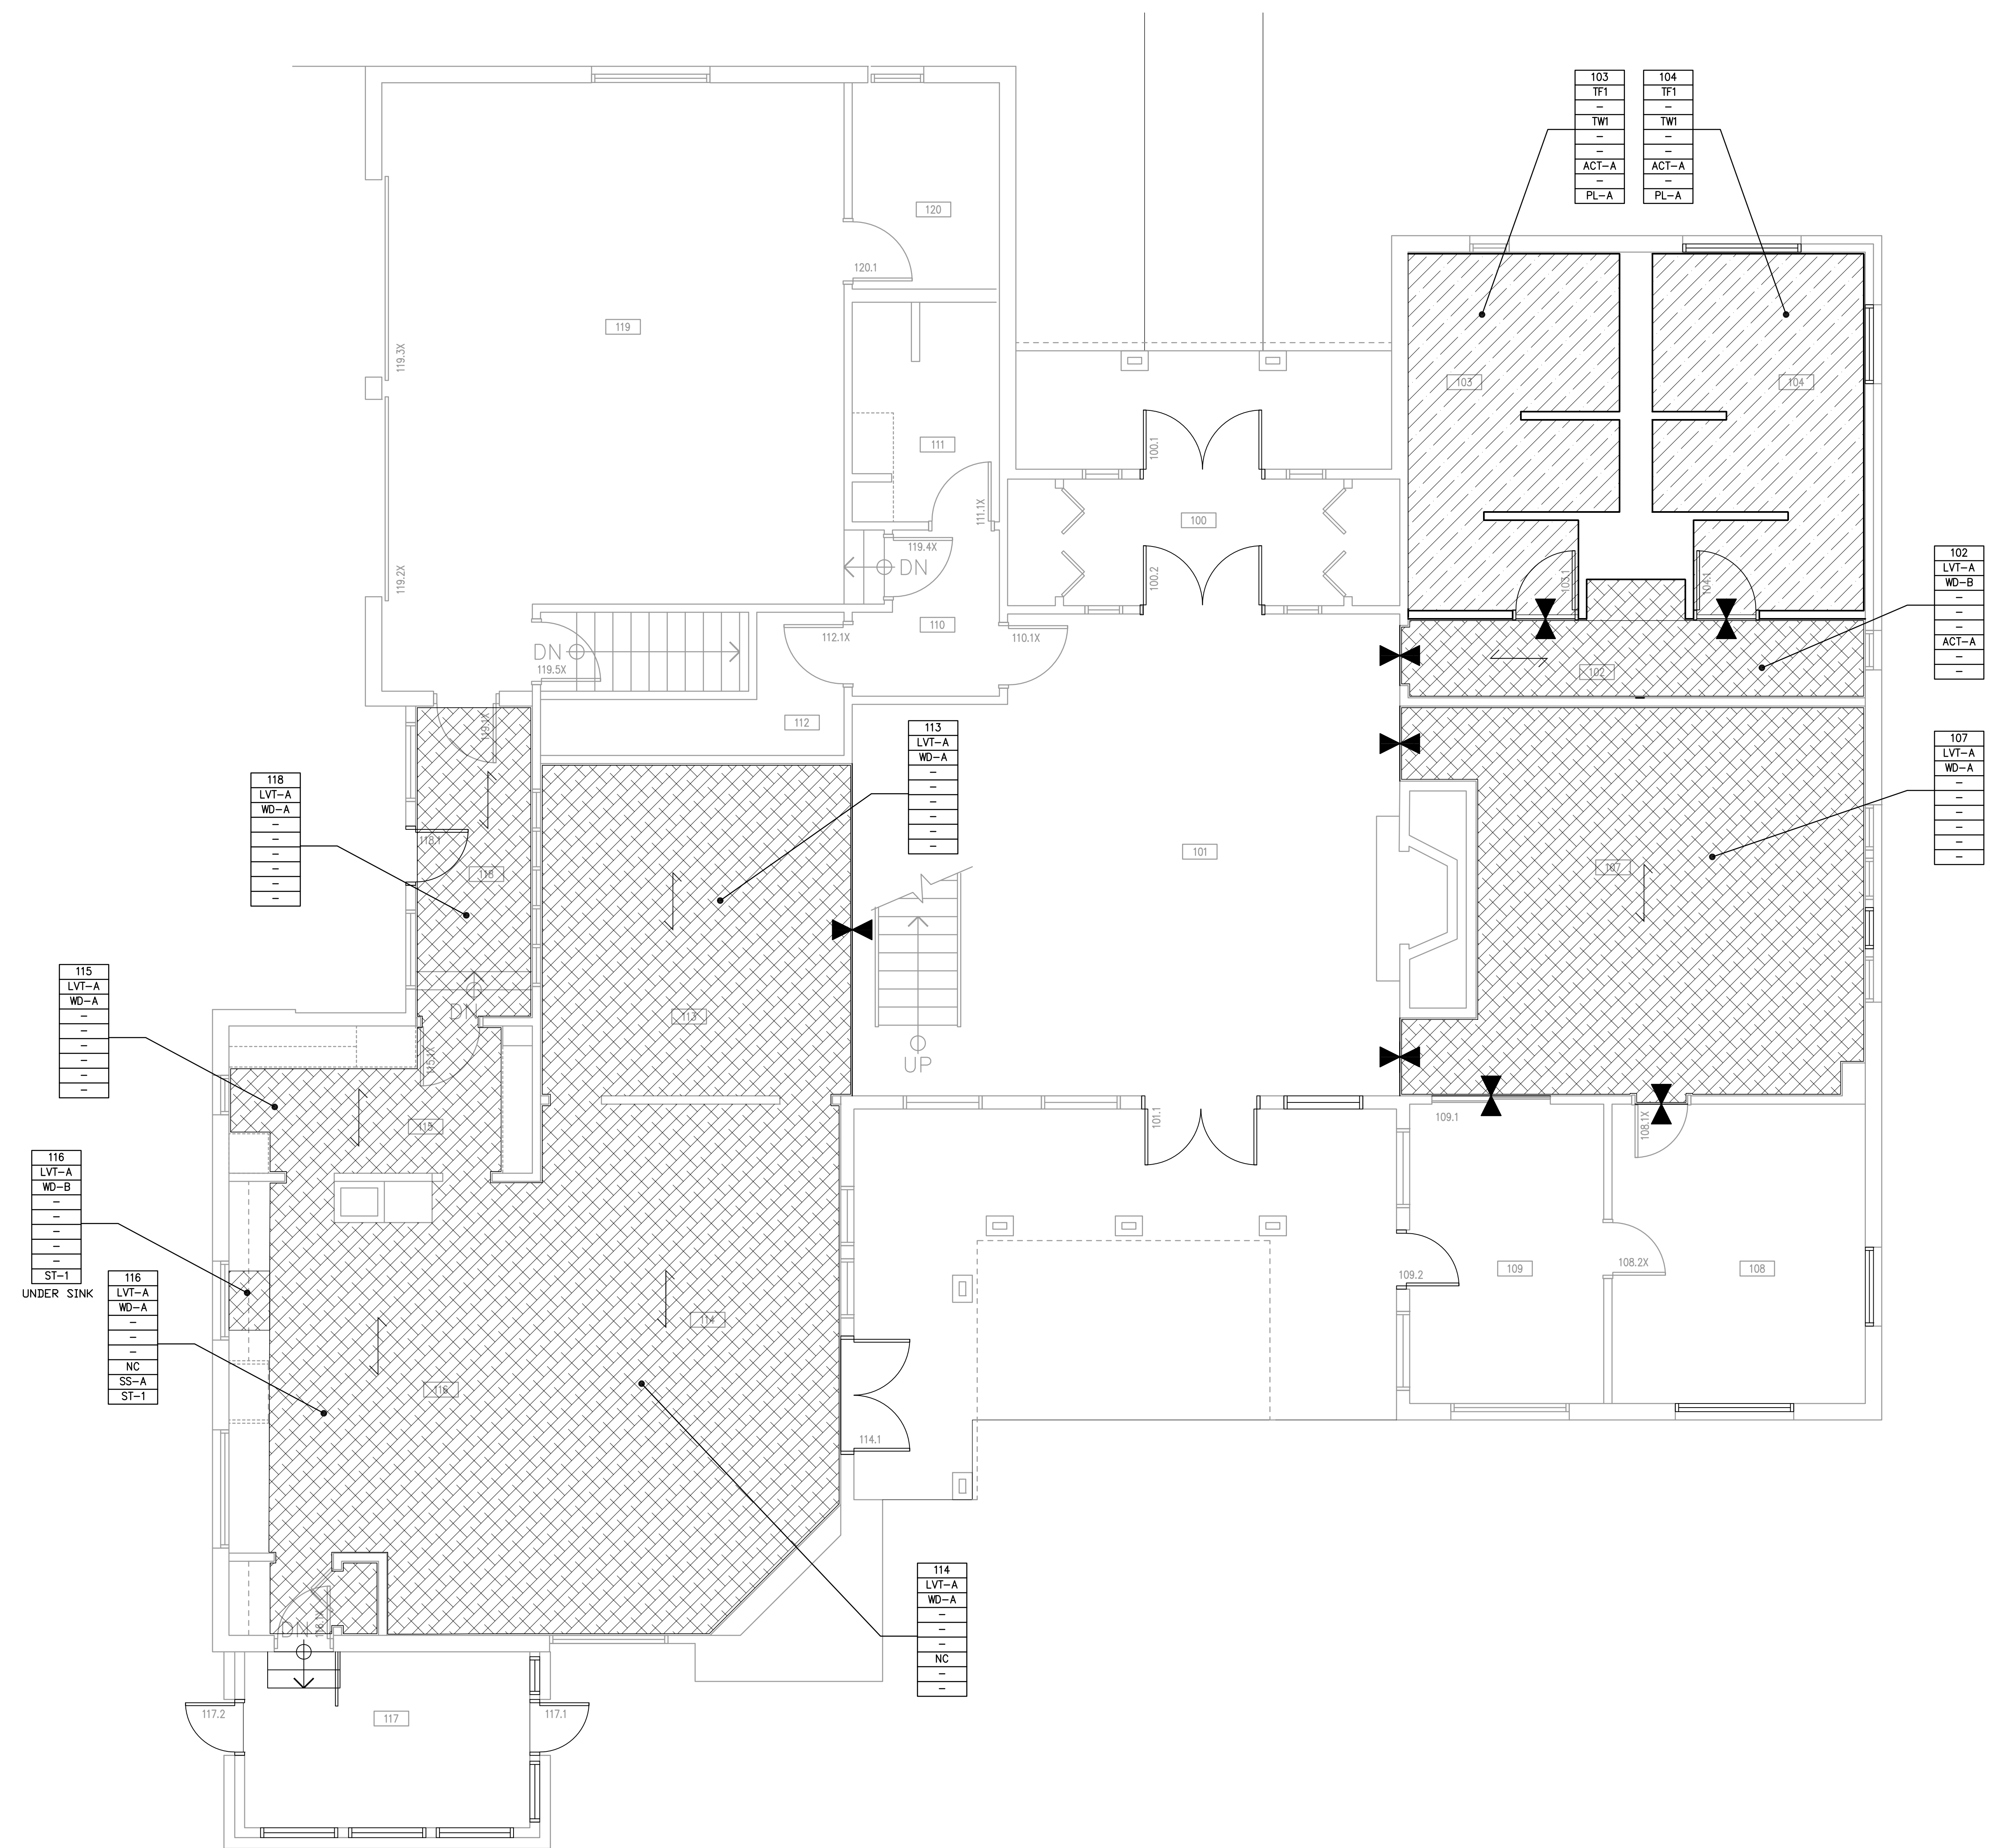

KEYNOTES

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FLOOR PLAN LEGEND

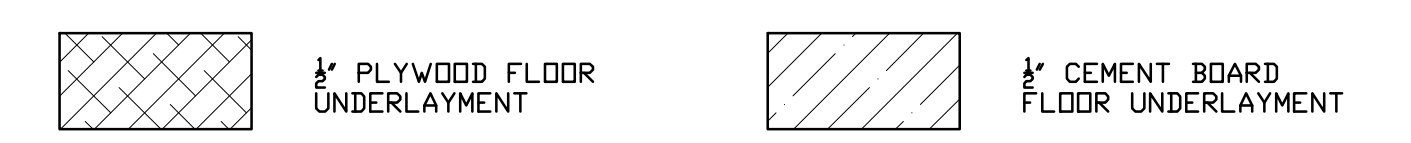

FINISHES SCHEDULE

AREA	FINISH CODE	MATERIAL	MANUFACTURER	DESCRIPTION
FLOORING	TF1	PORCELAIN TILE	CROSSVILLE	PRODUCT: AV224-TIMBER SIZE: 12\"X12\" GROUT-B: #35 MOCHA
	LVT-A	LUXURY VINYL TILE	J+J FLOORING	PRODUCT: LVT CLASSICS COLOR: #1008 PARADIGM
	VCT-A	VINYL COMPOSITION TILE	ARMSTRONG FLOORING	PRODUCT: STAND, EXCELON IMPERIAL TEXTURE COLOR: 51810 WASHED LINEN SIZE: 12\"X12\"X1/8\"
WALL BASE	WB-A	RUBBER BASE	JOHNSONITE	SERIES: TRADITIONAL COLOR: #47 BROWN TYPE: COVE
	WD-A	WOOD BASE	EXISTING	EXISTING 1 X 4 WOOD BASE STAINED TO REMAIN PROVIDE NEW STAINED & FINISHED QTR. RND. AT PERIMETER OF ROOM
	WB-B	WOOD BASE		NEW 1 X 4 WOOD BASE STAINED AND FINISHED WITH WOOD QTR. RND. AT PERIMETER OF RM.
WALLS	TW1	PORCELAIN TILE	CROSSVILLE	PRODUCT: AV221-GYPSUM SIZE: 12\"X24\" PATTERN: RUNNING BOND HORIZONTAL GROUT-A: #39 MUSHROOM
	PT1	PAINT	BENJAMIN MOORE	
	PT2	PAINT	BENJAMIN MOORE	
	PT3	PAINT	BENJAMIN MOORE	
	PT4	PAINT	BENJAMIN MOORE	
	FC1	FIBER CEMENT SIDING	JAMES HARDIE	COLOR: RICH ESPRESSO
CEILING	ACT-A	ACOUSTICAL CEILING TILE	ARMSTRONG	SYSTEM: ULTIMA SIZE: 24\"X24\"X3/4\" COLOR: WHITE EDGE: ULTIMA 1911 BEVELED REGULAR 15/16\" GRID: PRELUDE 15/16\"
	NC	NO CEILING FINISH		
	SS-A	SOLID SURFACE	WILSONART	COLOR: MYSTIQUE 9200CS
MILLWORK	PL-A	PLASTIC LAMINATE	WILSONART	COLOR: STICKLEY OAK 17003K-57
	ST-1	WOOD CASEWORK	CUSTOM	COLOR: STAINED & FINISHED TO MATCH EXIST.

LEGEND

ROOM NAME	CORNER GUARDS	FLOOR TRANSITION	FLOOR PATTERN DIRECTION
000 - ROOM NUMBER	END GUARDS		
CPT - FLOORING			
RBT - WALL BASE			
PT1 - WALL FINISH			
TW1 - ADDITIONAL WALL FINISH			
APC - CEILING			
SSW - COUNTERTOPS			
PLAM - MILLWORK			

GENERAL NOTES

- REFER TO DRAWING G100 FOR PROJECT GENERAL NOTES.
- REFER TO A400 SERIES REFLECTED CEILING PLAN DRAWINGS FOR CEILING HEIGHTS.
- COORDINATE CEILING HEIGHTS WITH SECTIONS AND DETAILS.
- COORDINATE LOCATIONS OF WALL-MOUNTED ELECTRICAL ITEMS WITH ARCHITECTURAL ITEMS TO ENSURE NO OVERLAP.
- COORDINATE LOCATIONS OF CONTROL AND RAKED JOINTS WITH FLOOR PLAN DRAWINGS.

FIRST FLOOR FINISH PLAN
SCALE: 1/4" = 1'-0"

ISSUED	
01/09/22	BID DOCUMENTS

JOB NO.	19-429-1250
DRAWN	SKF
CHECKED	CJH
APPROVED	CJH

SHEET TITLE
FIRST FLOOR FINISH PLAN


SHEET NUMBER

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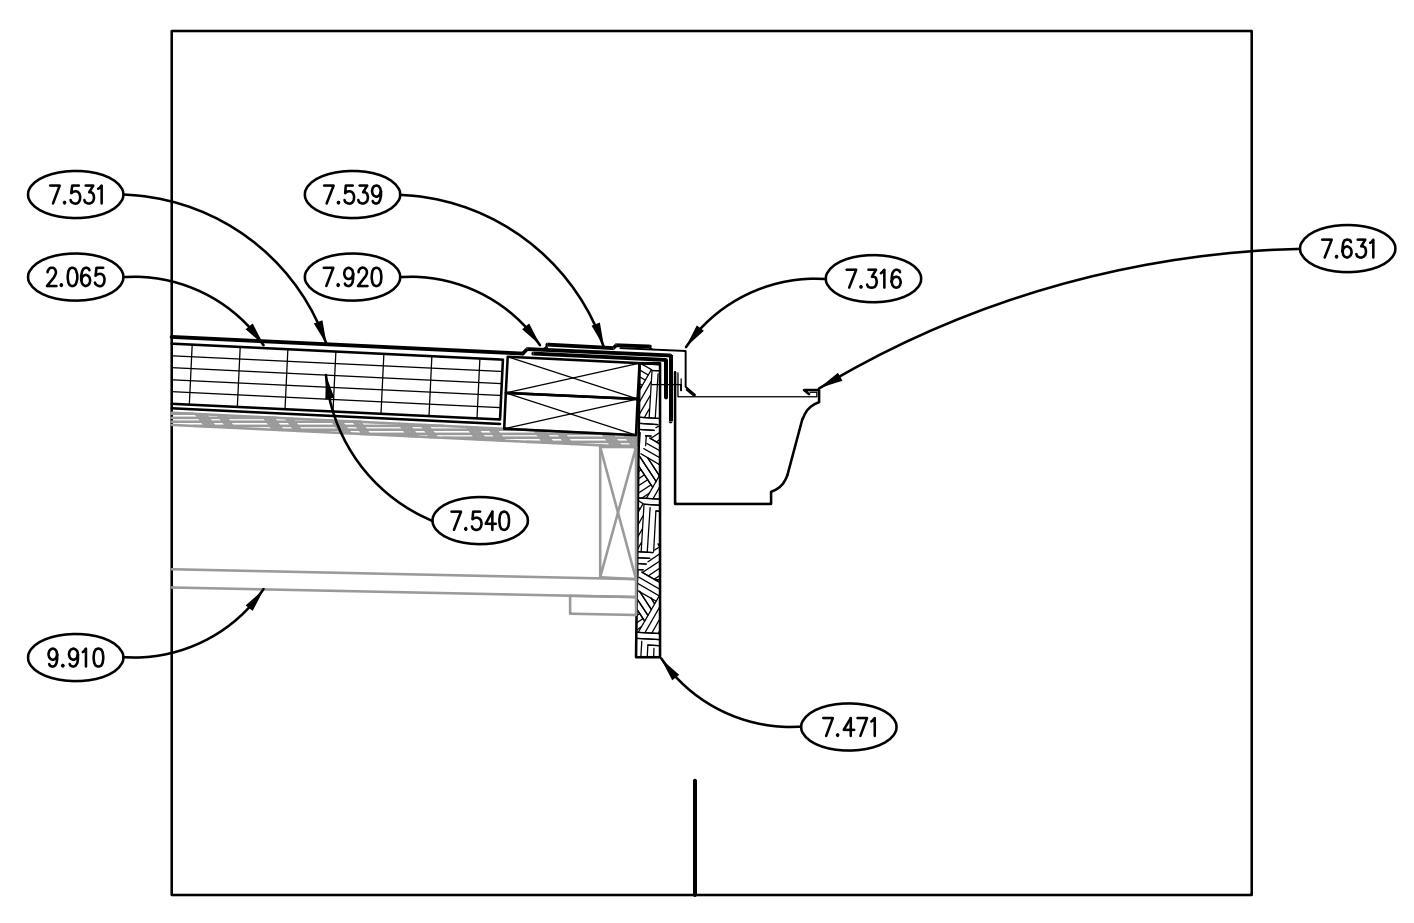
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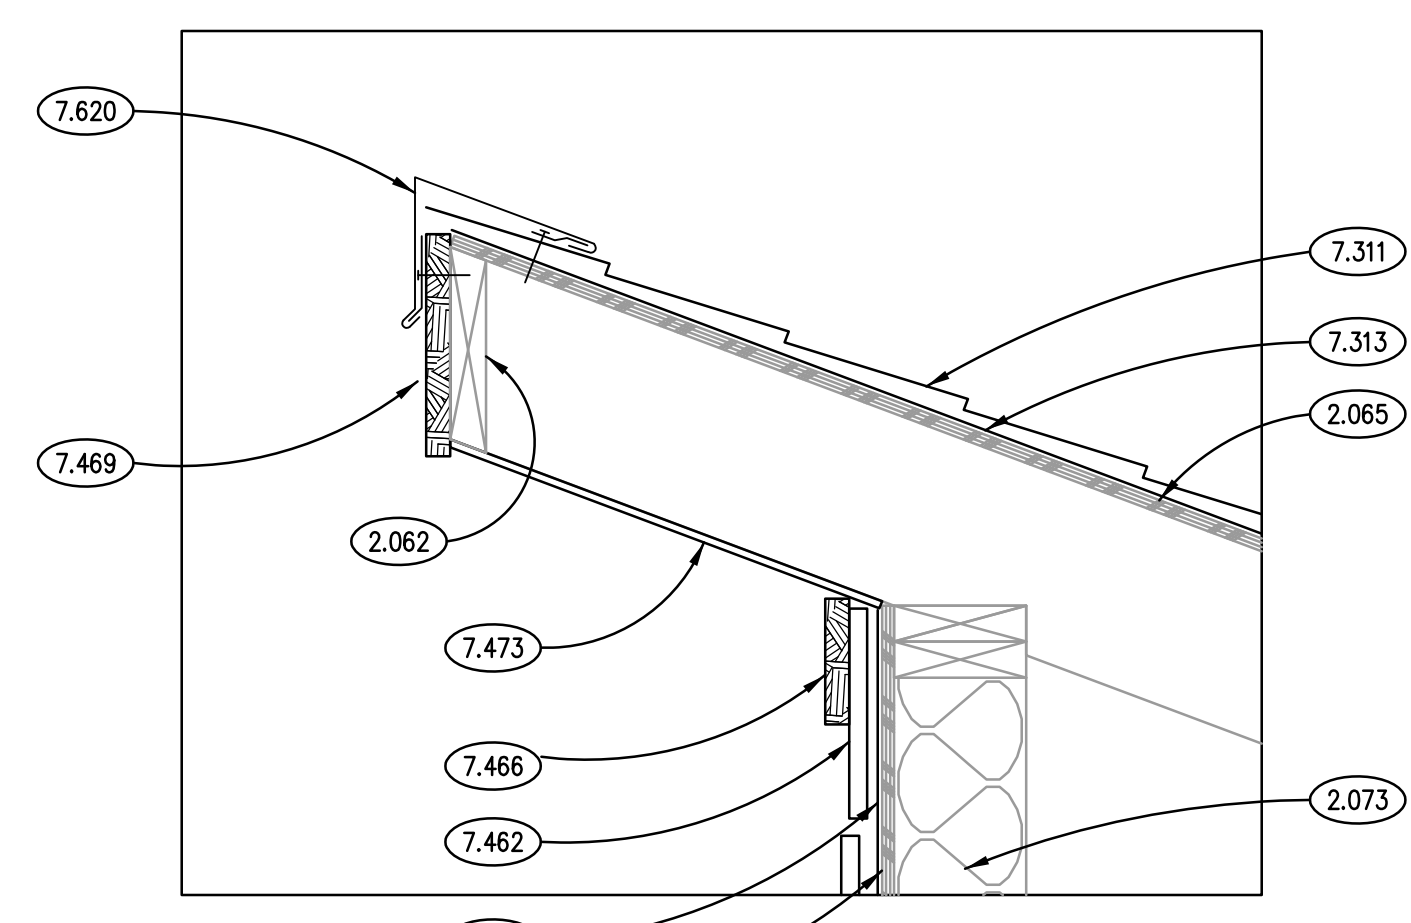
- 2.040 EXISTING BRICK VENEER.
- 2.062 EXISTING WOOD SUBFASCIA.
- 2.064 EXISTING PLYWOOD SHEATHING.
- 2.065 EXISTING PLYWOOD DECKING.
- 2.066 EXISTING WOOD TRUSS.
- 2.073 EXISTING BATT INSULATION.
- 6.002 ROUGH CARPENTRY: WOOD BLOCKING; DIMENSIONAL LUMBER; SIZE AS REQUIRED; REFER TO SCHEDULE FOR TREATMENT.
- 7.252 WEATHER BARRIER SHEET MEMBRANE; REFER TO SPECIFICATIONS.
- 7.311 ASPHALT SHINGLES.
- 7.312 ASPHALT SHINGLES SHEET MATERIAL: EAVE PROTECTION MEMBRANE; EXTEND MIN. 2 FEET PAST EDGE OF INTERIOR WALL SURFACE AT ALL OVERHANG LOCATIONS. INSTALL 2 FEET ON EITHER SIDE OF ALL ROOF VALLEYS AND AT RIDGES.
- 7.313 ASPHALT SHINGLES SHEET MATERIAL: UNDERLAYMENT.
- 7.316 ASPHALT SHINGLES METAL FLASHING: GUTTER APPROX; MATERIAL, THICKNESS AND FINISH AS SPECIFIED.
- 7.317 ASPHALT SHINGLES METAL FLASHING: EDGE FLASHING; MATERIAL, THICKNESS AND FINISH AS SPECIFIED.
- 7.319 ASPHALT SHINGLES METAL FLASHING: BASE COUNTERFLASHING; MATERIAL, THICKNESS AND FINISH AS SPECIFIED.
- 7.462 FIBER CEMENT SIDING: 5/16" THK. VERTICAL SIDING PANEL; REFER TO SPECIFICATIONS.
- 7.463 FIBER CEMENT SIDING: BATTEN STRIPS; 3/4" x 2-1/2"; SIMULATED ROUGH-SAWN WOOD GRAIN TEXTURE; SPACED AT 7" O.C. U.N.O.
- 7.466 FIBER CEMENT SIDING: TRM BOARD; 5/4" x 5-1/2" (ACTUAL); SIMULATED ROUGH-SAWN WOOD GRAIN TEXTURE; REFER TO SPECIFICATIONS.
- 7.469 FIBER CEMENT SIDING: TRM BOARD; 5/4" x 9-1/4" (ACTUAL); SIMULATED ROUGH-SAWN WOOD GRAIN TEXTURE; REFER TO SPECIFICATIONS.
- 7.471 FIBER CEMENT SIDING: TRM BOARD; 5/4" x 11-1/4" (ACTUAL); SIMULATED ROUGH-SAWN WOOD GRAIN TEXTURE; REFER TO SPECIFICATIONS.
- 7.473 FIBER CEMENT SIDING: SOFFIT PANELS; REFER TO SPECIFICATIONS.
- 7.531 ELASTOMERIC MEMBRANE ROOFING MATERIAL: EPDM MEMBRANE.
- 7.533 ELASTOMERIC MEMBRANE ROOFING MATERIAL: FLEXIBLE EPDM FLASHING.
- 7.534 ELASTOMERIC MEMBRANE ROOFING MATERIAL: RIGID INSULATION; 2 LAYERS; 3 INCH OVER 2 1/2 INCH; 5 1/2 INCHES TOTAL THICKNESS; R-30.8 (MIN).
- 7.536 ELASTOMERIC MEMBRANE ROOFING MATERIAL: VAPOR RETARDER.
- 7.537 ELASTOMERIC MEMBRANE ROOFING MATERIAL: ADHESIVE.
- 7.538 ELASTOMERIC MEMBRANE ROOFING ACCESSORY: TERMINATION BAR WITH SEALANT BEAD.
- 7.539 ELASTOMERIC MEMBRANE ROOFING MATERIAL: SELF-ADHERING MEMBRANE FLASHING.
- 7.540 ELASTOMERIC MEMBRANE ROOFING MATERIAL: RIGID INSULATION; 2-1/2".
- 7.620 METAL COPING FLASHING: THICKNESS AND FINISH AS SPECIFIED.
- 7.621 METAL COUNTERFLASHING RECEIVER: EMBEDDED IN MASONRY; MATERIAL, THICKNESS AND FINISH AS SPECIFIED.
- 7.627 METAL STEP FLASHING; MIN. 6" CLEAR FROM ANY STEP FLASHING EDGE TO ROOFING MATERIAL BELOW; MATERIAL, THICKNESS AND FINISH AS SPECIFIED.
- 7.631 METAL GUTTER: MATERIAL, THICKNESS AND FINISH AS SPECIFIED.
- 7.920 JOINT SEALANT: REFER TO SCHEDULE IN SPECIFICATION SECTION 07 92 00; PROVIDE BACKER ROD OR BOND BREAKER.
- 9.910 EXTERIOR PAINTING: SCRAPE EXISTING EXPOSED CEDAR RAFTERS AND WOOD DECKING, PRIME AND TWO COATS STAIN. TYPICAL AT BUILDING PERIMETER.




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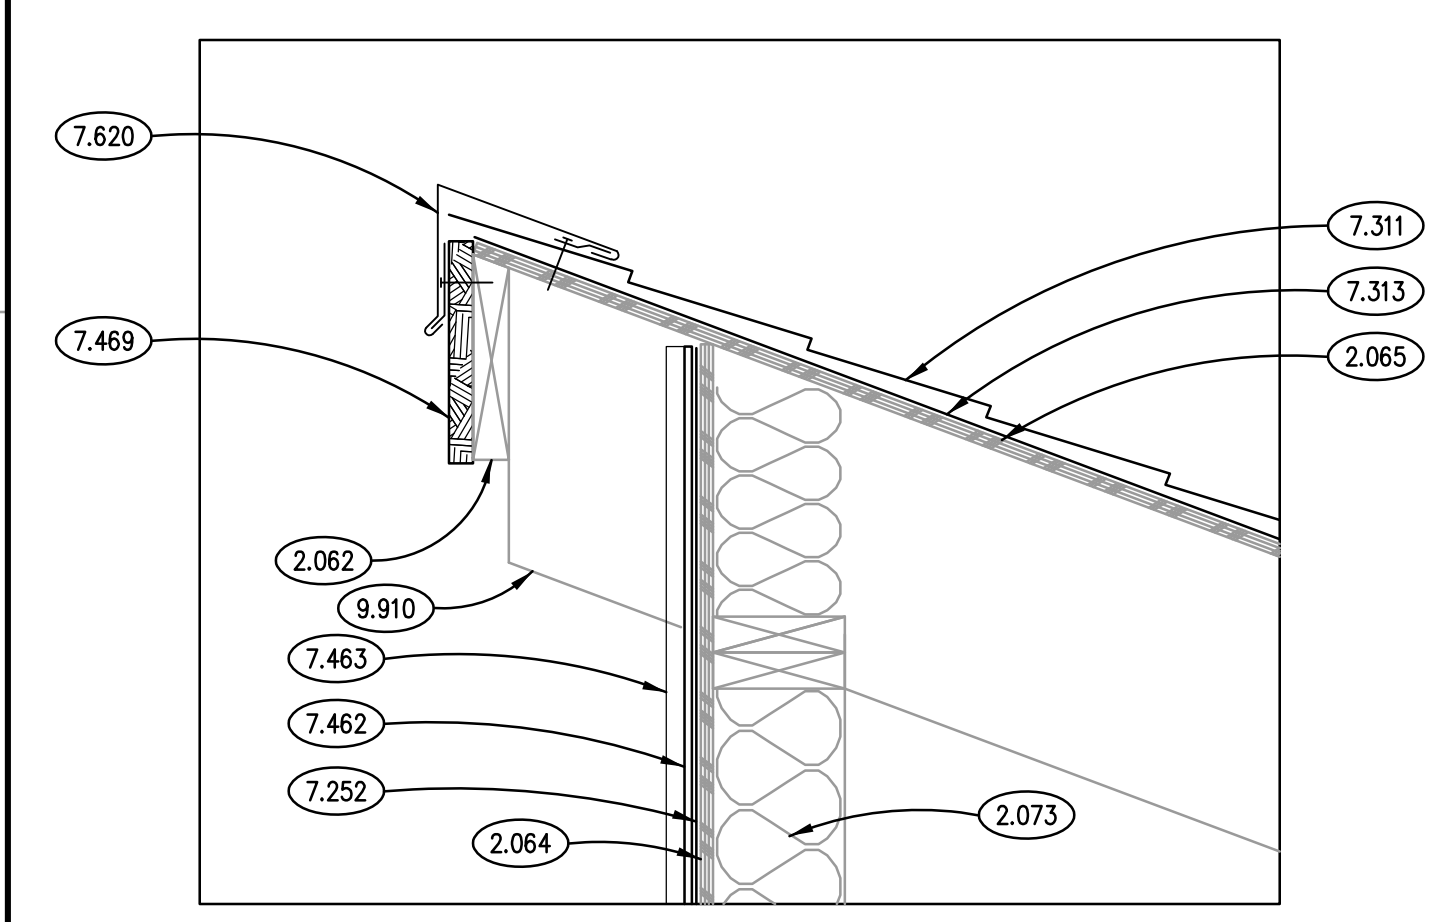
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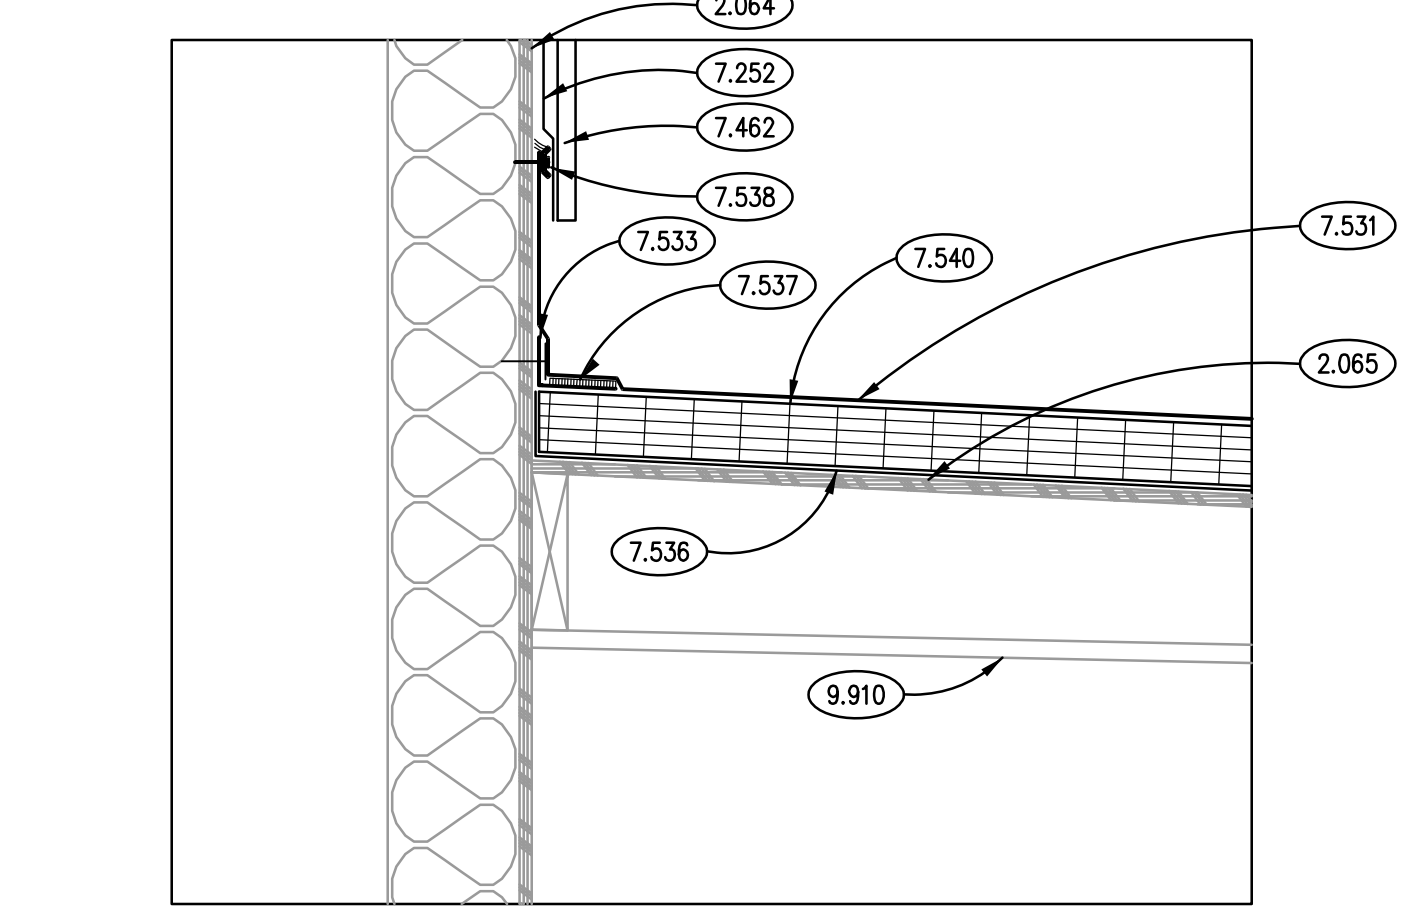
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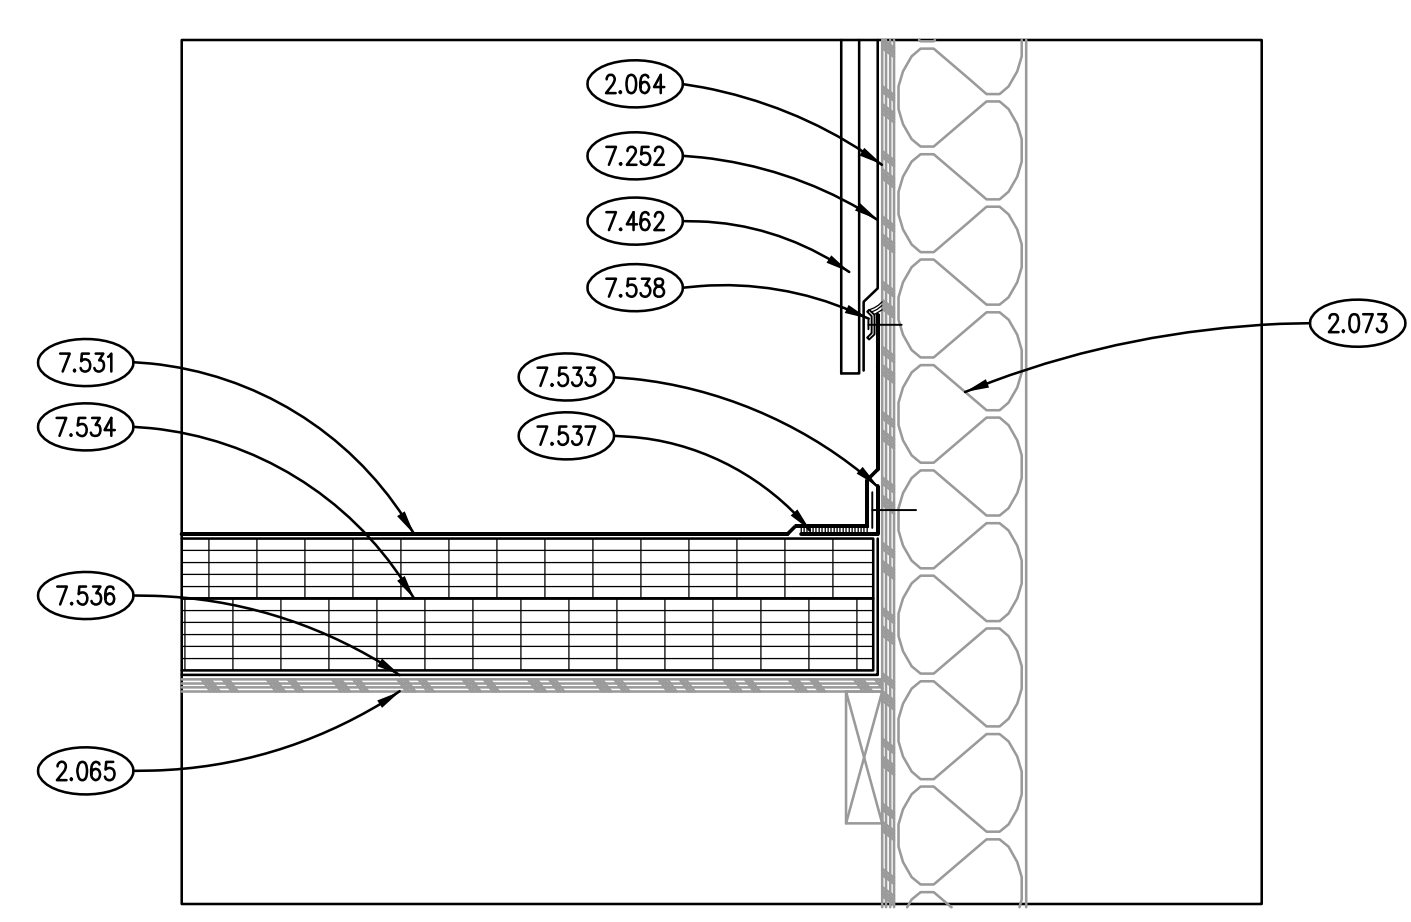
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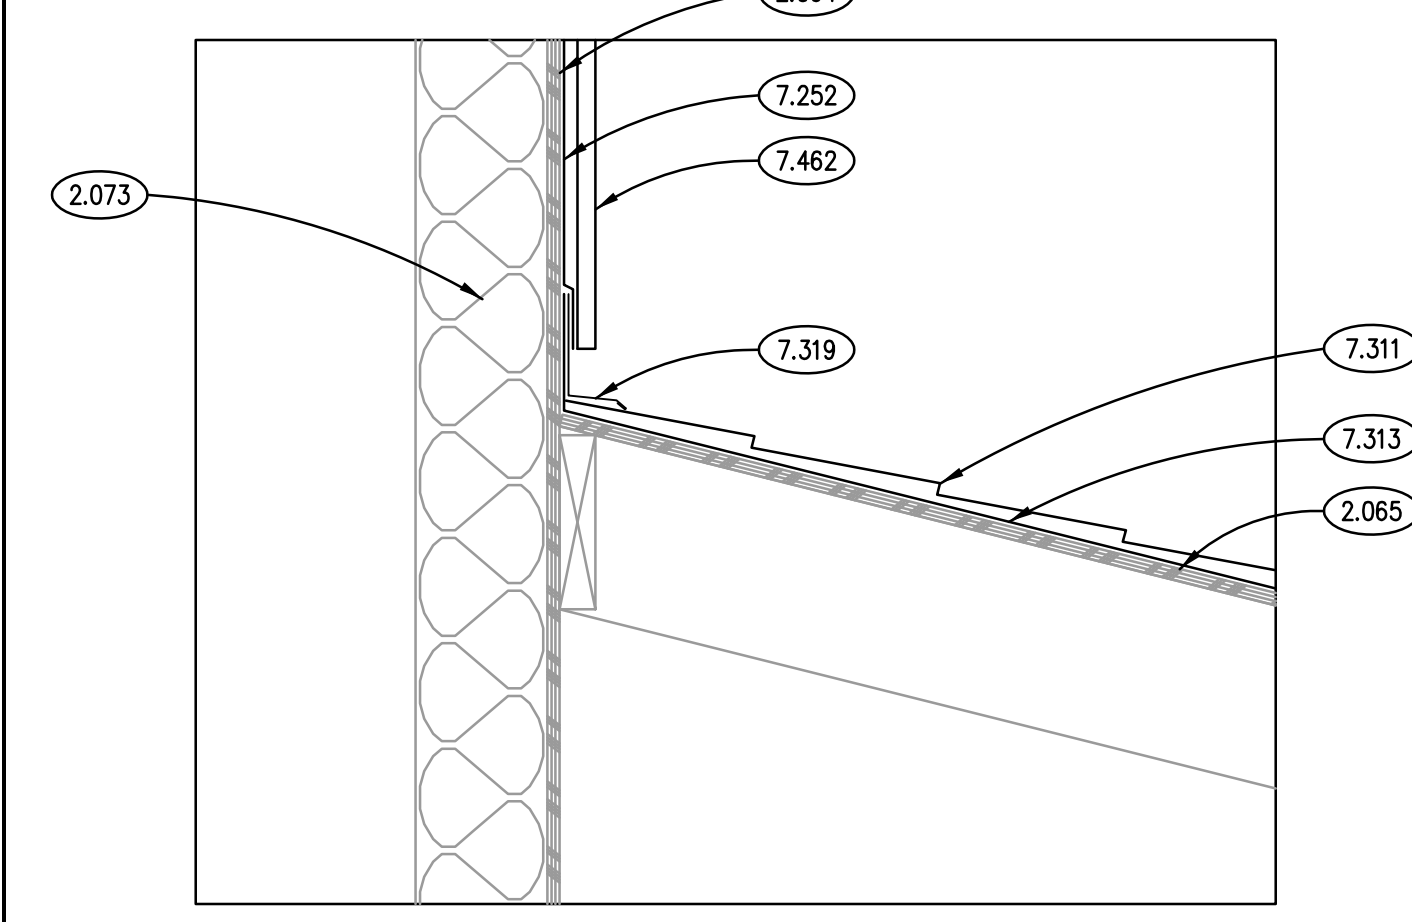
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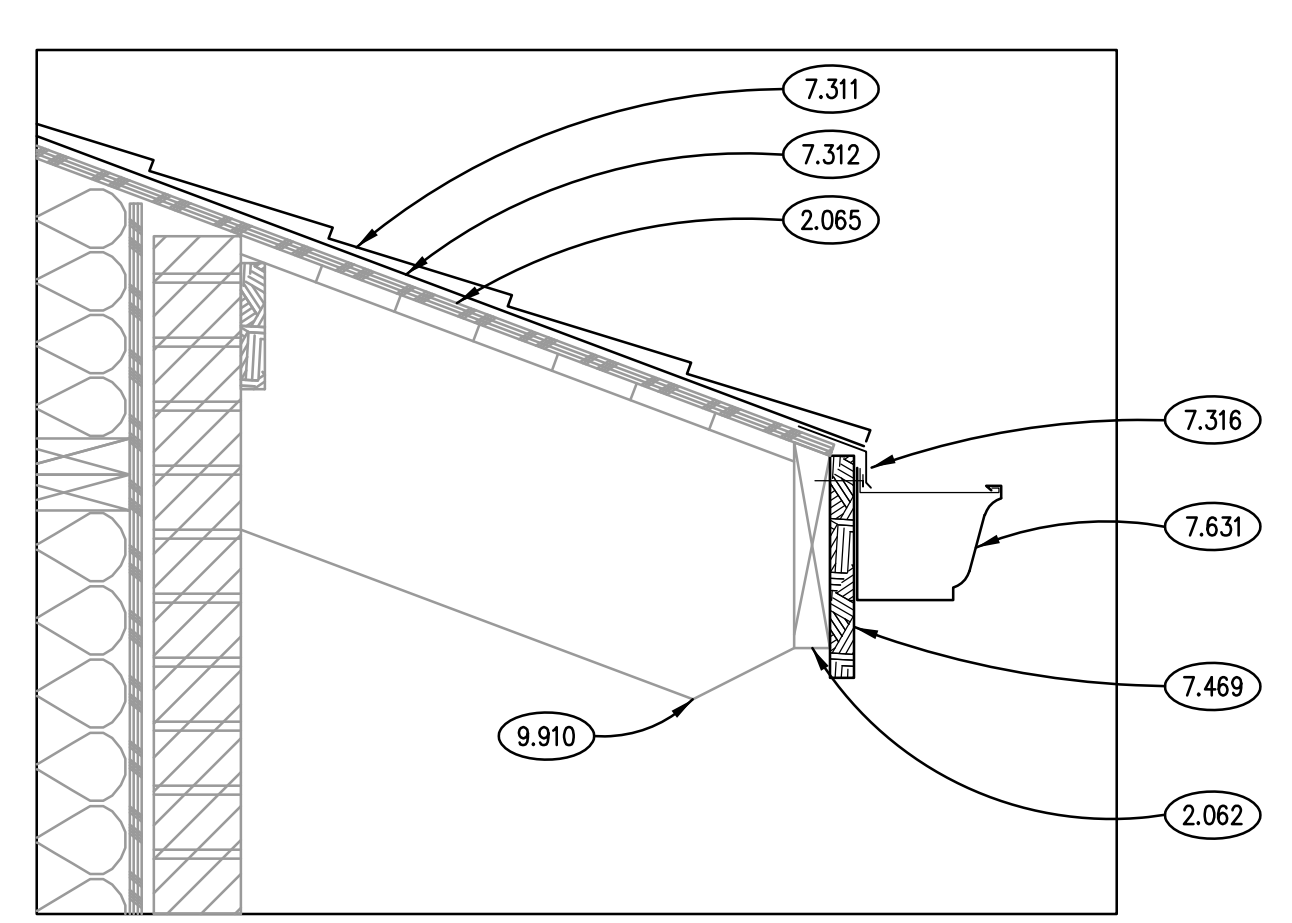
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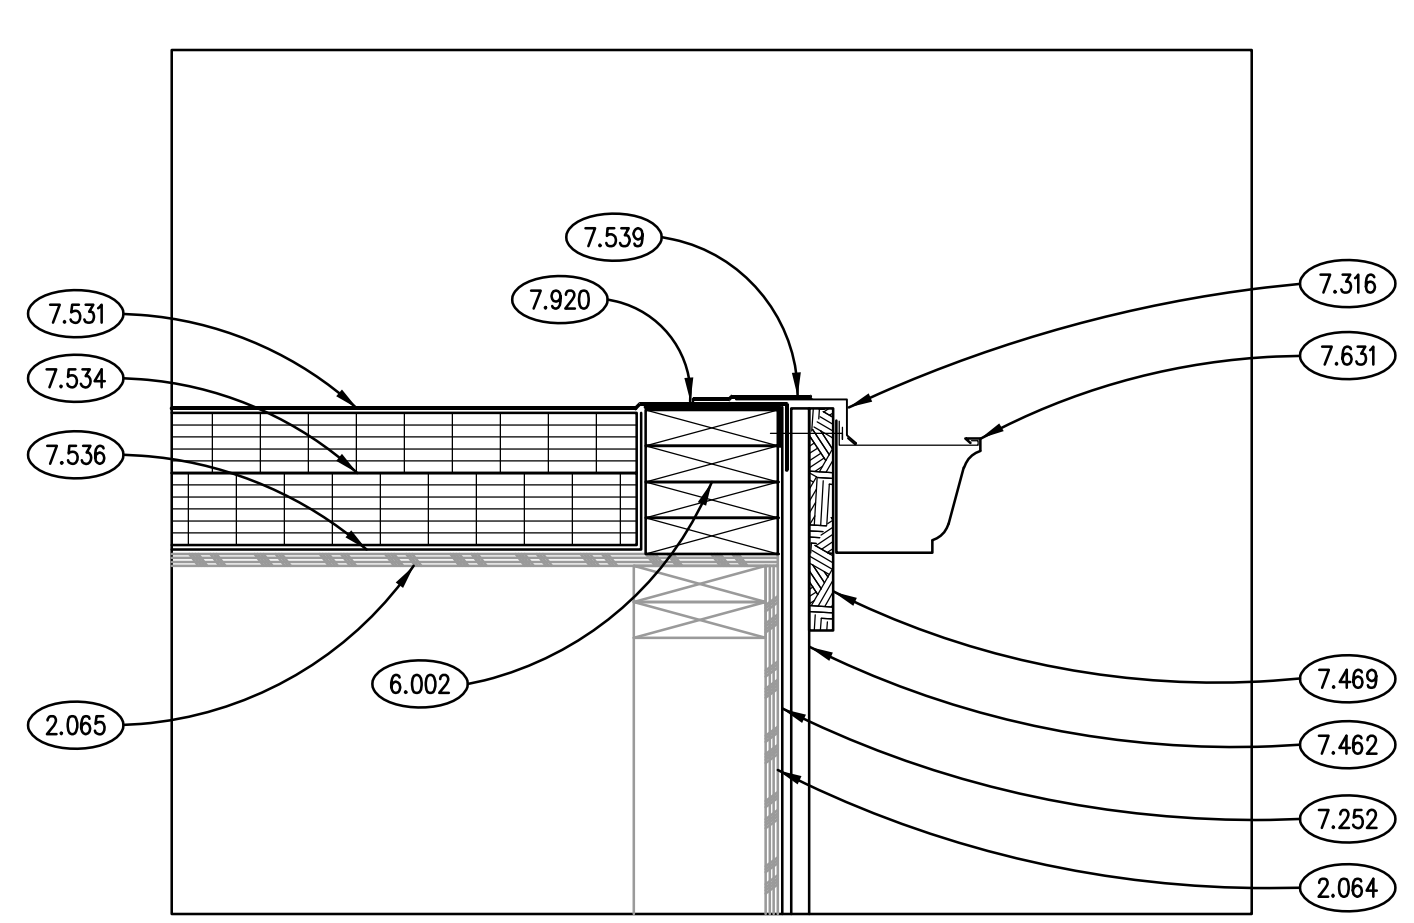
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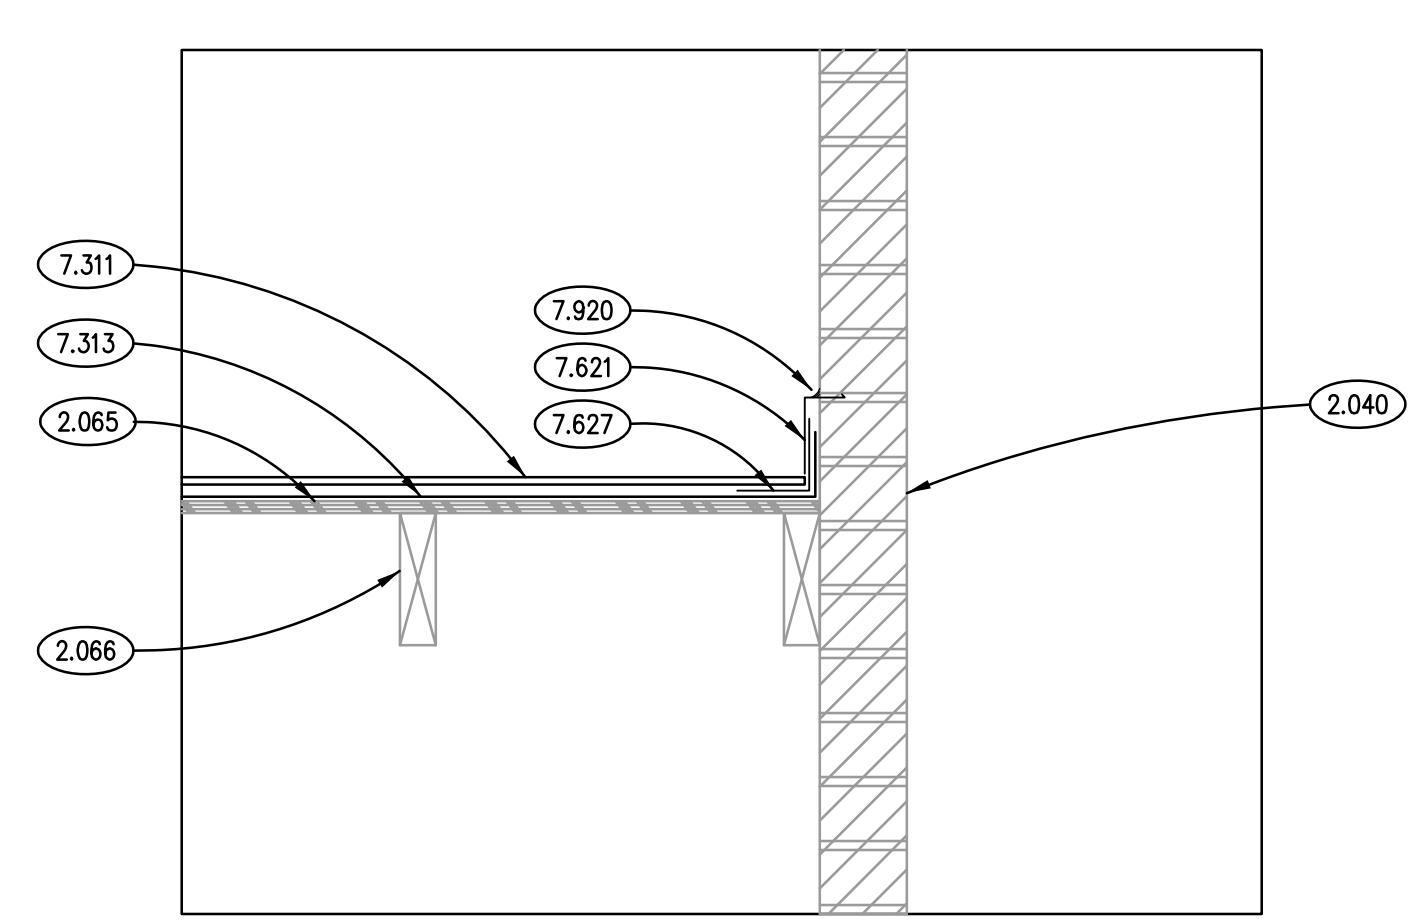
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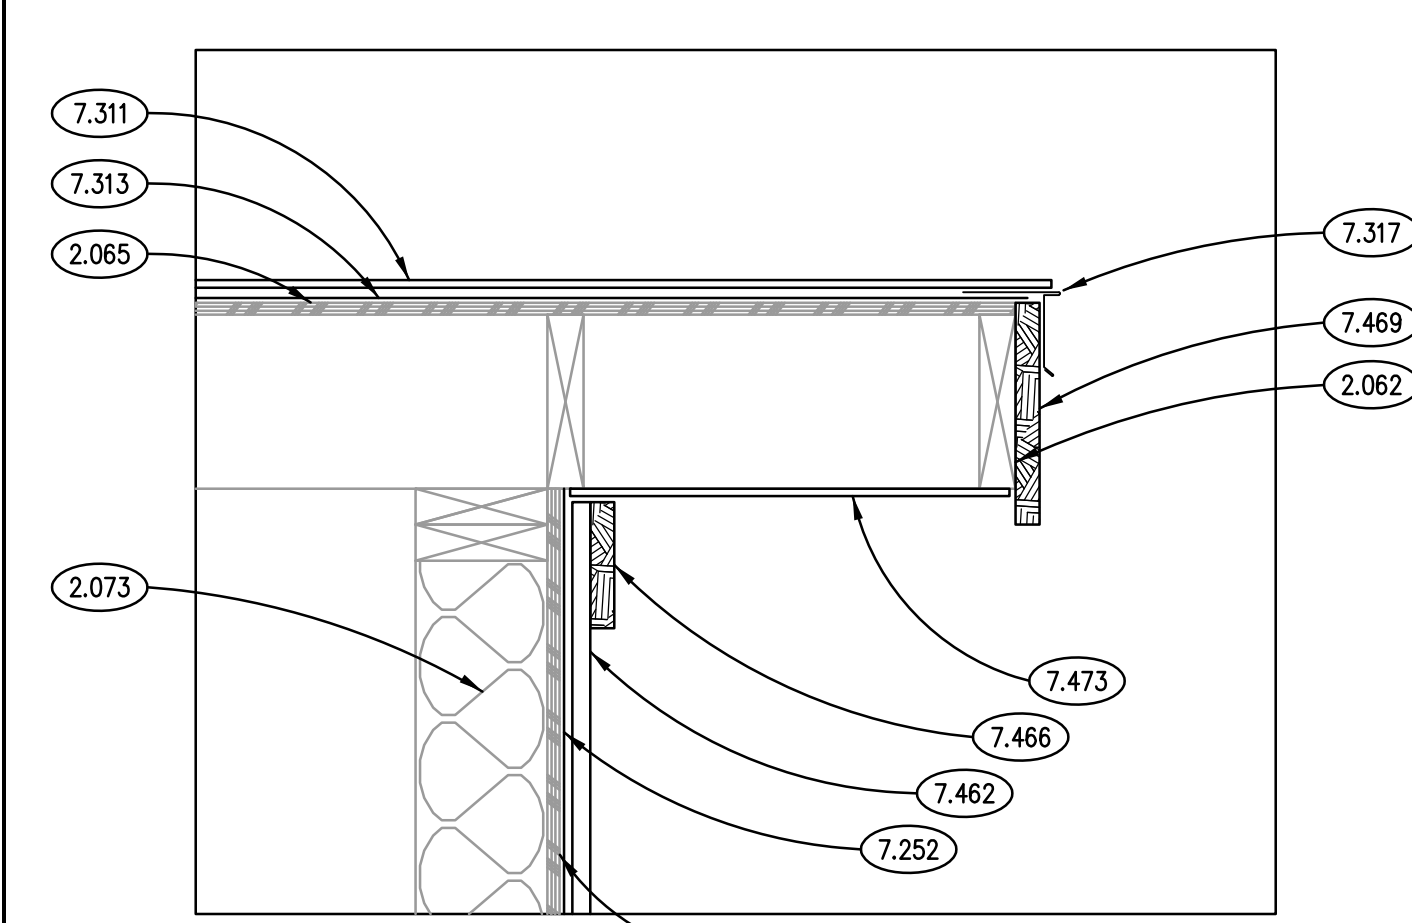
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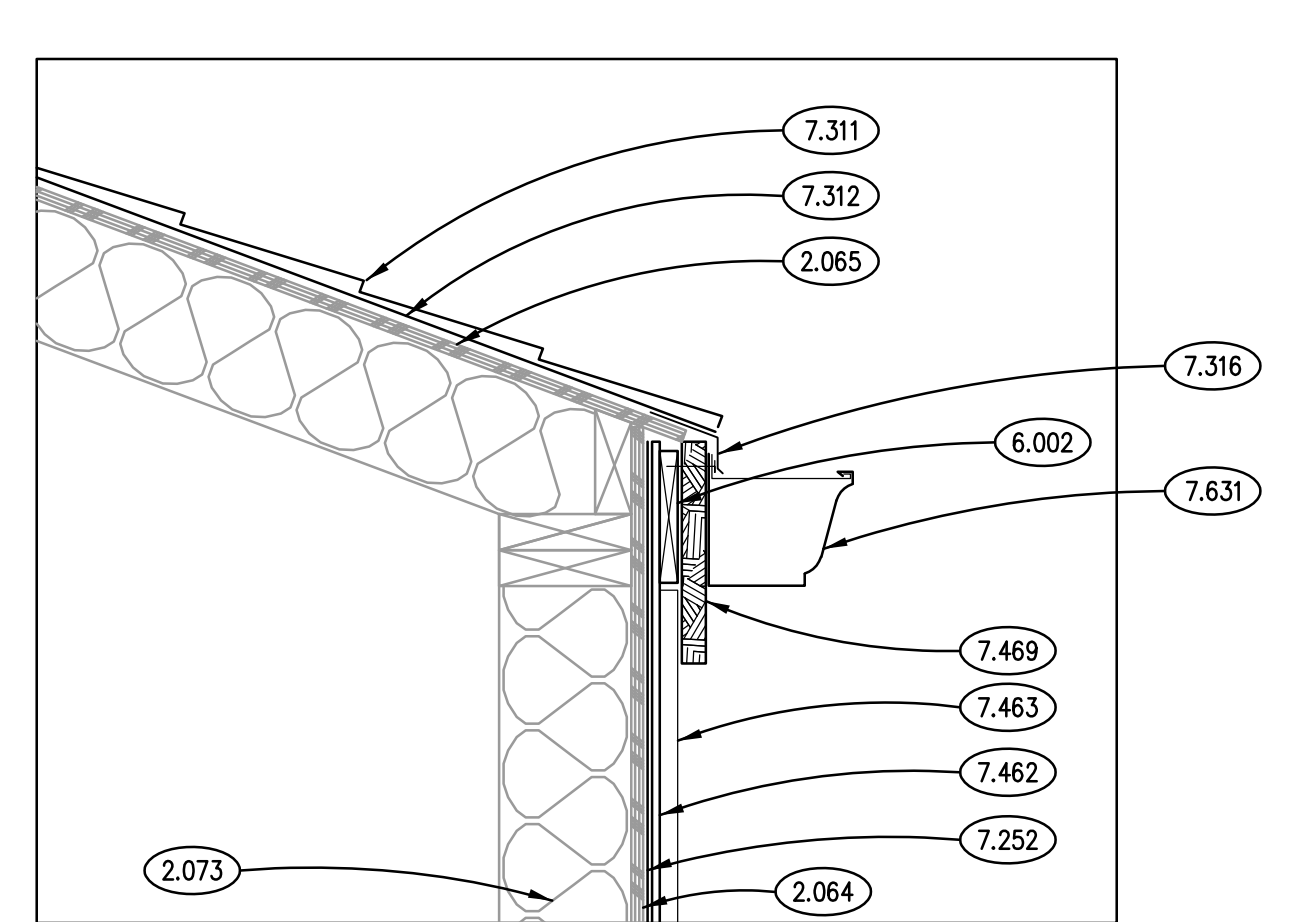
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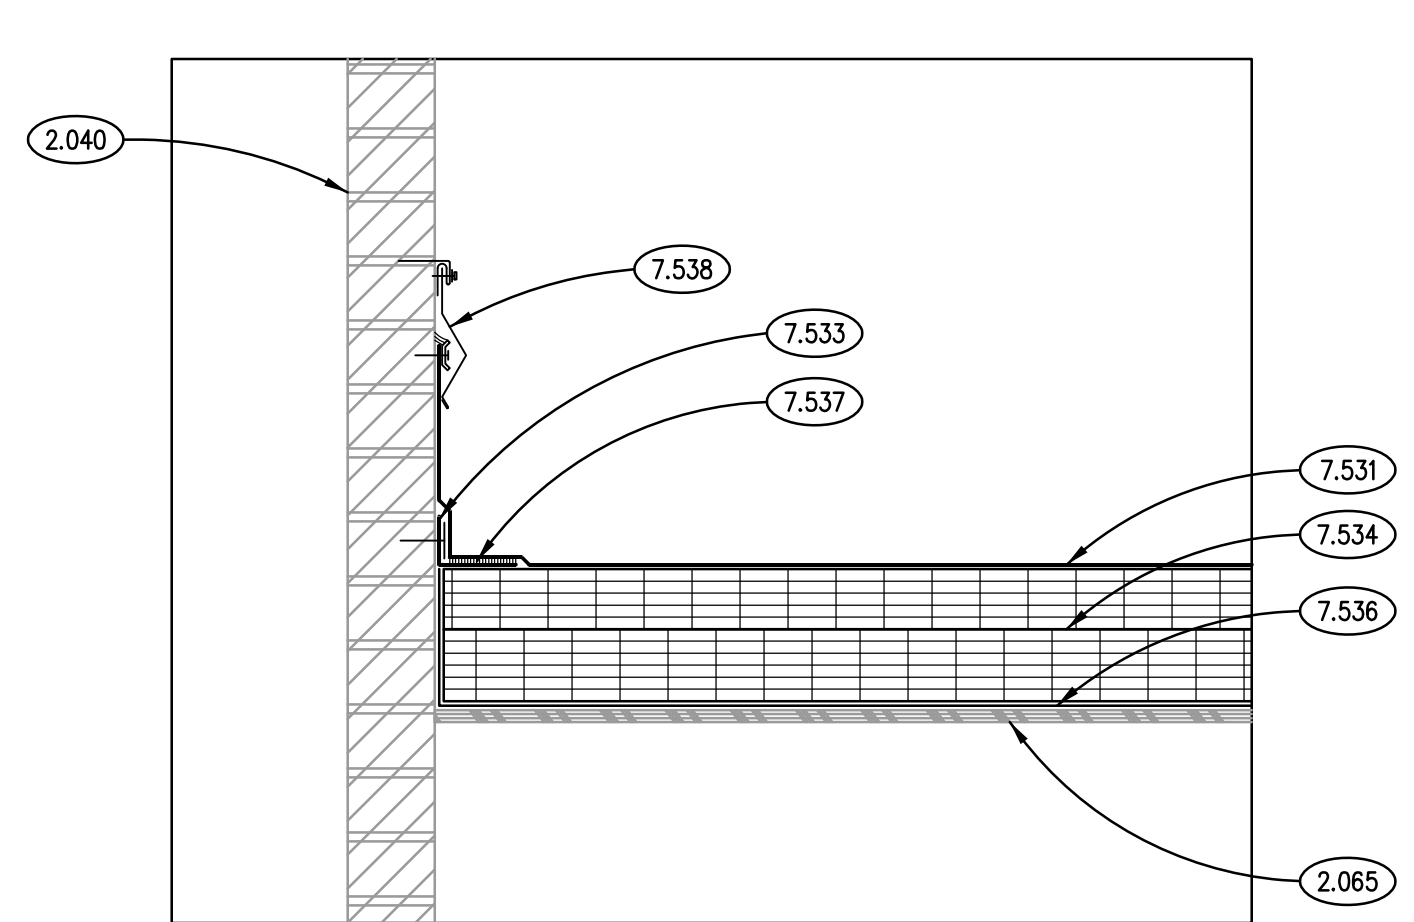
SECTION DETAIL 6
SCALE: 1/2" = 1'-0"

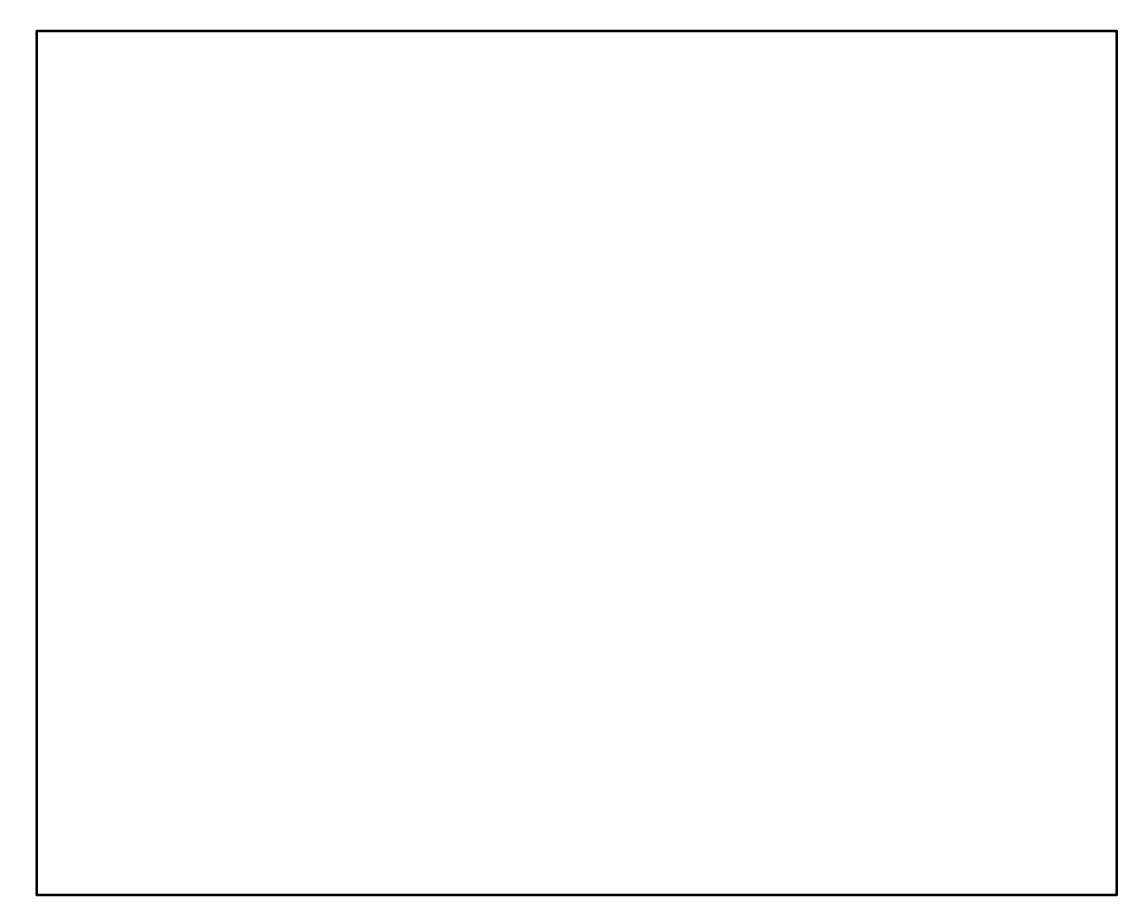


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SCALE: 1/2" = 1'-0"




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SCALE: 1/2" = 1'-0"

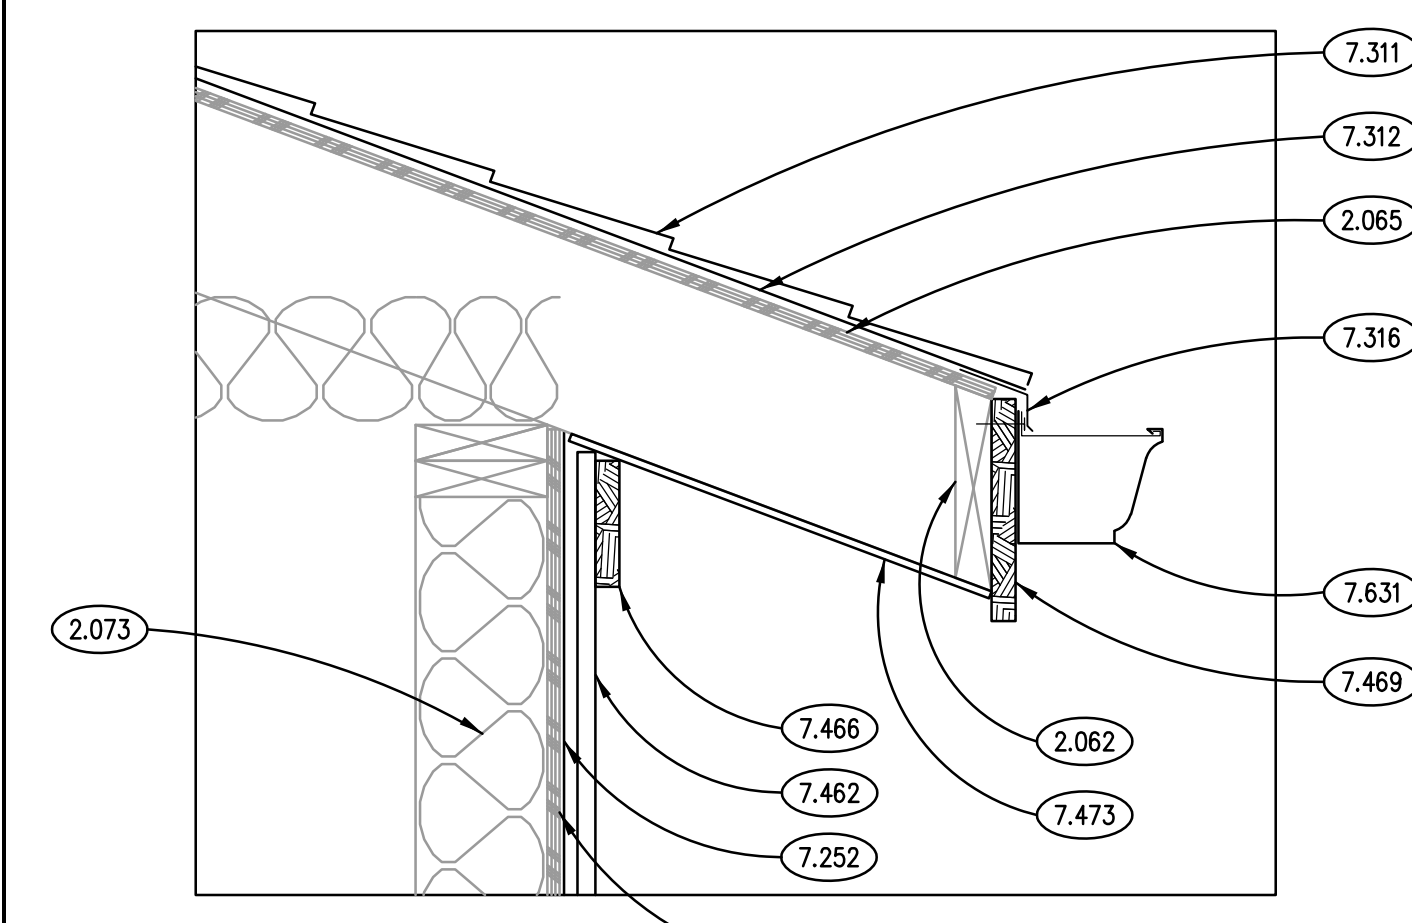

SECTION DETAIL 9
SCALE: 1/2" = 1'-0"

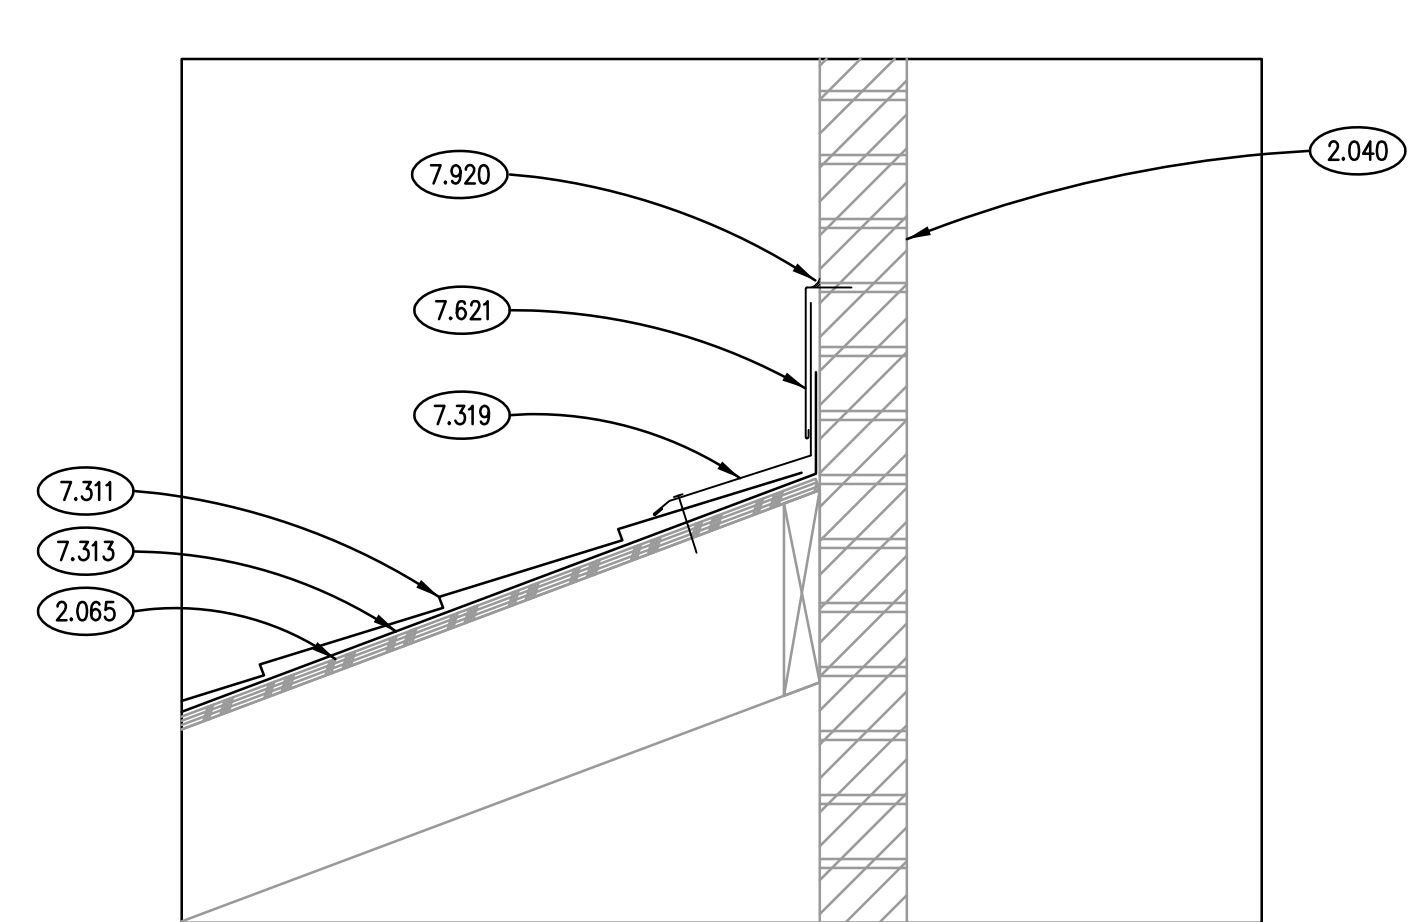

SECTION DETAIL 5
SCALE: 1/2" = 1'-0"

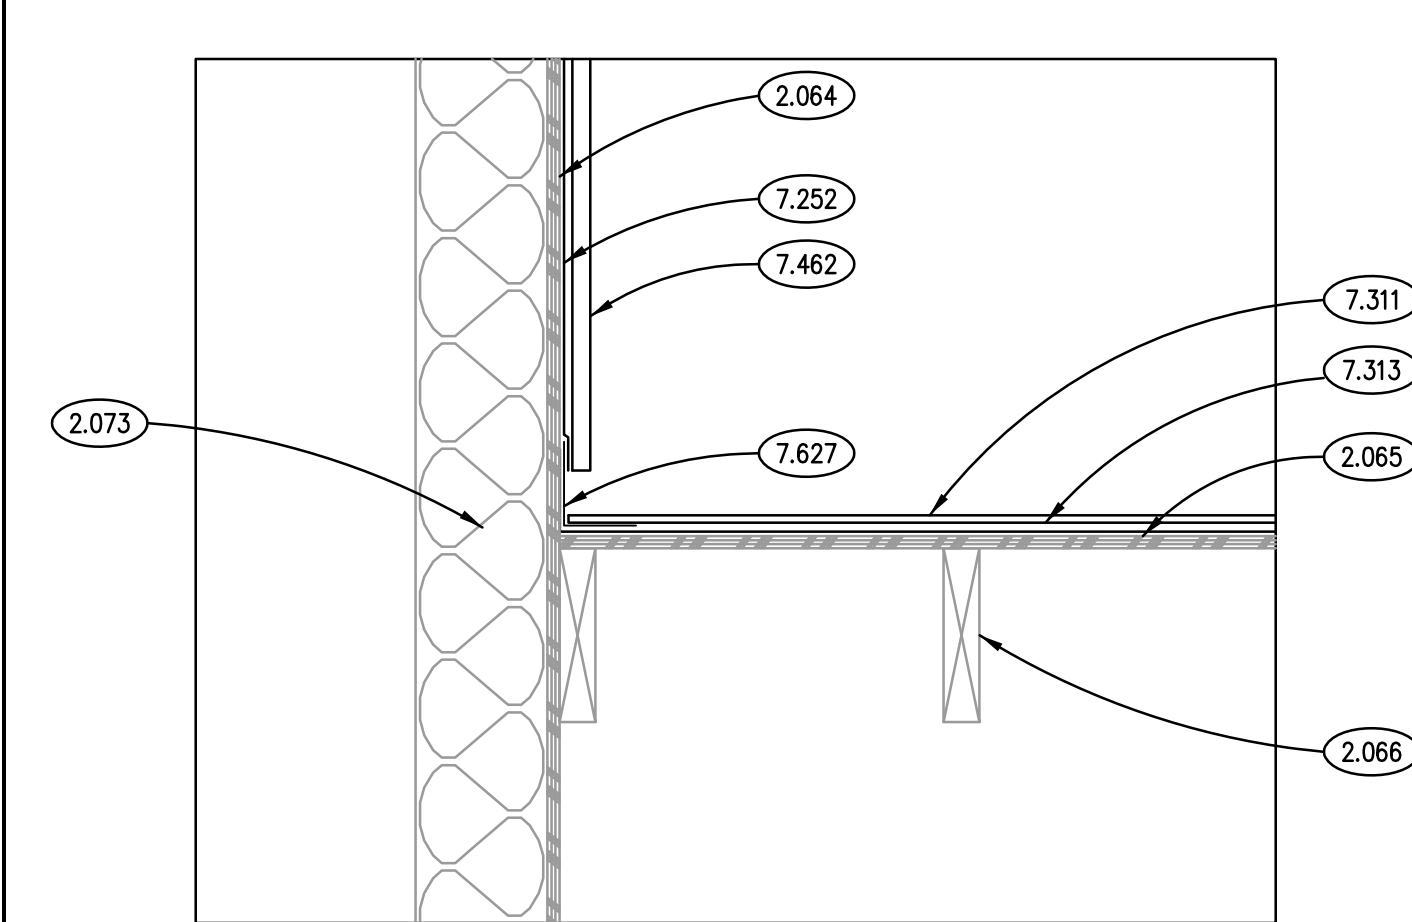

SECTION DETAIL 1
SCALE: 1/2" = 1'-0"

GENERAL NOTES

1. REFER TO DRAWING G100 FOR PROJECT GENERAL NOTES.
2. PREP, 2 COAT PRIME & PAINT ALL TRIM, DOORS, UNDERSIDE OF ROOF RAFTER TAILS AND TONGUE & GROOVE DECKING, TYPICAL.

ISSUED	
REVISED	
DATE	
BY	
DESCRIPTION	

JOB NO.	19-429-1250
DRAWN	PJT
CHECKED	CJH
APPROVED	CJH

SHEET TITLE

ROOF SECTION DETAILS


SHEET NUMBER

A1200


KEYNOTES

KEYNOTES ARE NOT ALWAYS REPEATED ACROSS ALL DRAWINGS ON THIS SHEET. AN UN-KEYNOTED ITEM ON THIS SHEET IS THE SAME AS A KEYNOTED ITEM ON THIS SHEET HAVING THE SAME GRAPHIC APPEARANCE.


- 4.182 MASONRY ANCHORAGE AND REINFORCEMENT: FLEXIBLE MASONRY TIE.
- 4.191 MASONRY ACCESSORY: THROUGH-WALL FLASHING; RUBBERIZED ASPHALT SHEET WITH TERMINATION BAR AT TOP AND STAINLESS STEEL DRIP EDGE AT BOTTOM; HOLD BACK RUBBERIZED ASPHALT SHEET AT LEAST 1 INCH FROM EXTERIOR FACE OF WALL.
- 4.193 MASONRY ACCESSORY: WEEP VENT.
- 4.194 MASONRY ACCESSORY: MORTAR DROPPING CONTROL DEVICE.
- 4.210 BRICK MASONRY: MODULAR TYPE; REFER TO SPECIFICATIONS.
- 4.721 CAST STONE MASONRY: SILL COURSE; SIZE AND CONFIGURATION AS INDICATED; PROVIDE CAST DRIP AT ALL OVERHANG EDGES; SLOPE TOP TO DRAIN AS SHOWN; PROVIDE UNITS WITH FINISHED ENDS AT BUTT-JOINTED CORNERS; RAKE OUT MORTAR AND PROVIDE BOND BREAKER AND JOINT SEALANT AT ALL HEAD AND TOP JOINTS.
- 5.010 STRUCTURAL STEEL: FRAMING MEMBER; REFER TO STRUCTURAL DRAWINGS.
- 5.011 STEEL COLUMN SETTING PLATE; REFER TO STRUCTURAL DRAWINGS.
- 6.001 ROUGH CARPENTRY: WOOD BLOCKING; DIMENSIONAL LUMBER; SIZE AS INDICATED; REFER TO SCHEDULE FOR TREATMENT.
- 6.002 ROUGH CARPENTRY: WOOD BLOCKING; DIMENSIONAL LUMBER; SIZE AS REQUIRED; REFER TO SCHEDULE FOR TREATMENT.
- 6.005 ROUGH CARPENTRY: PLYWOOD: 1/2" THICK; REFER TO SPECIFICATIONS FOR TREATMENT.
- 6.006 ROUGH CARPENTRY: PLYWOOD: 3/4" THICK; REFER TO SPECIFICATIONS.
- 6.173 WOOD I-JOIST: REFER TO STRUCTURAL DRAWINGS FOR SIZE AND SPACING.
- 6.210 FINISH CARPENTRY: 1 X 6 TONGUE & GROOVE SOFFIT MATERIALS; REFER TO SPECIFICATIONS.
- 7.252 WEATHER BARRIER SHEET MEMBRANE: REFER TO SPECIFICATIONS.
- 7.310 ASPHALT SHINGLE ROOFING SYSTEM: REFER TO SPECIFICATIONS.
- 7.311 ASPHALT SHINGLES.
- 7.313 ASPHALT SHINGLES SHEET MATERIAL: UNDERLAYMENT.
- 7.317 ASPHALT SHINGLES METAL FLASHING: EDGE FLASHING; MATERIAL, THICKNESS AND FINISH AS SPECIFIED.
- 7.469 FIBER CEMENT SIDING: TRIM BOARD; 5/4" X 9-1/4" (ACTUAL); SIMULATED ROUGH-SAWN WOOD GRAIN TEXTURE; REFER TO SPECIFICATIONS.
- 7.471 FIBER CEMENT SIDING: TRIM BOARD; 5/4" X 11-1/4" (ACTUAL); SIMULATED ROUGH-SAWN WOOD GRAIN TEXTURE; REFER TO SPECIFICATIONS.
- 7.473 FIBER CEMENT SIDING: SOFFIT PANELS; REFER TO SPECIFICATIONS.
- 7.474 FIBER CEMENT SIDING: SOFFIT PANELS; USED TO ENCASE STRUCTURAL BEAM MEMBERS AND TO CONCEAL STRUCTURAL BEAM MEMBERS AND TO CREATE FALSE BEAM CONSTRUCTION OVER 2X FRAMING; REFER TO SPECIFICATIONS.
- 7.477 FIBER CEMENT SIDING ACCESSORY: PREFINISHED SHEET METAL FLASHING; SILL FLASHING SET INTO BED OF SEALANT ON UNDERSIDE OF FLASHING. VERTICAL FLASHING LEG SHALL BE 4 INCHES MINIMUM. TUCK FLASHING UNDER WEATHER BARRIER AND TAPE OFF TO FLASHING. TYPICAL.
- 7.920 JOINT SEALANT: REFER TO SCHEDULE IN SPECIFICATION SECTION 07 92 00; PROVIDE BACKER ROD OR BOND BREAKER.
- 26.001 LIGHT FIXTURE: EXTERIOR UP-DOWN LIGHT; REFER TO ELECTRICAL DRAWINGS.
- 32.014 PRECAST CONCRETE UNIT PAVERS: PATTERN OF PAVERS AS SPECIFIED. REFER TO SPECIFICATIONS.
- 32.016 PRECAST CONCRETE DIMENSIONAL STONE: CAP; REFER TO SPECIFICATIONS.
- 32.020 PRECAST CONCRETE UNIT PAVER SETTING BED; MINIMUM 1.5 INCHES THICK.
- 32.021 PRECAST CONCRETE UNIT PAVER STONE BASE; MIN. 8 INCHES THICK.
- 32.022 PRECAST CONCRETE DIMENSIONAL STONE SEAT WALL STONE BASE; MIN. 18 INCHES THICK.

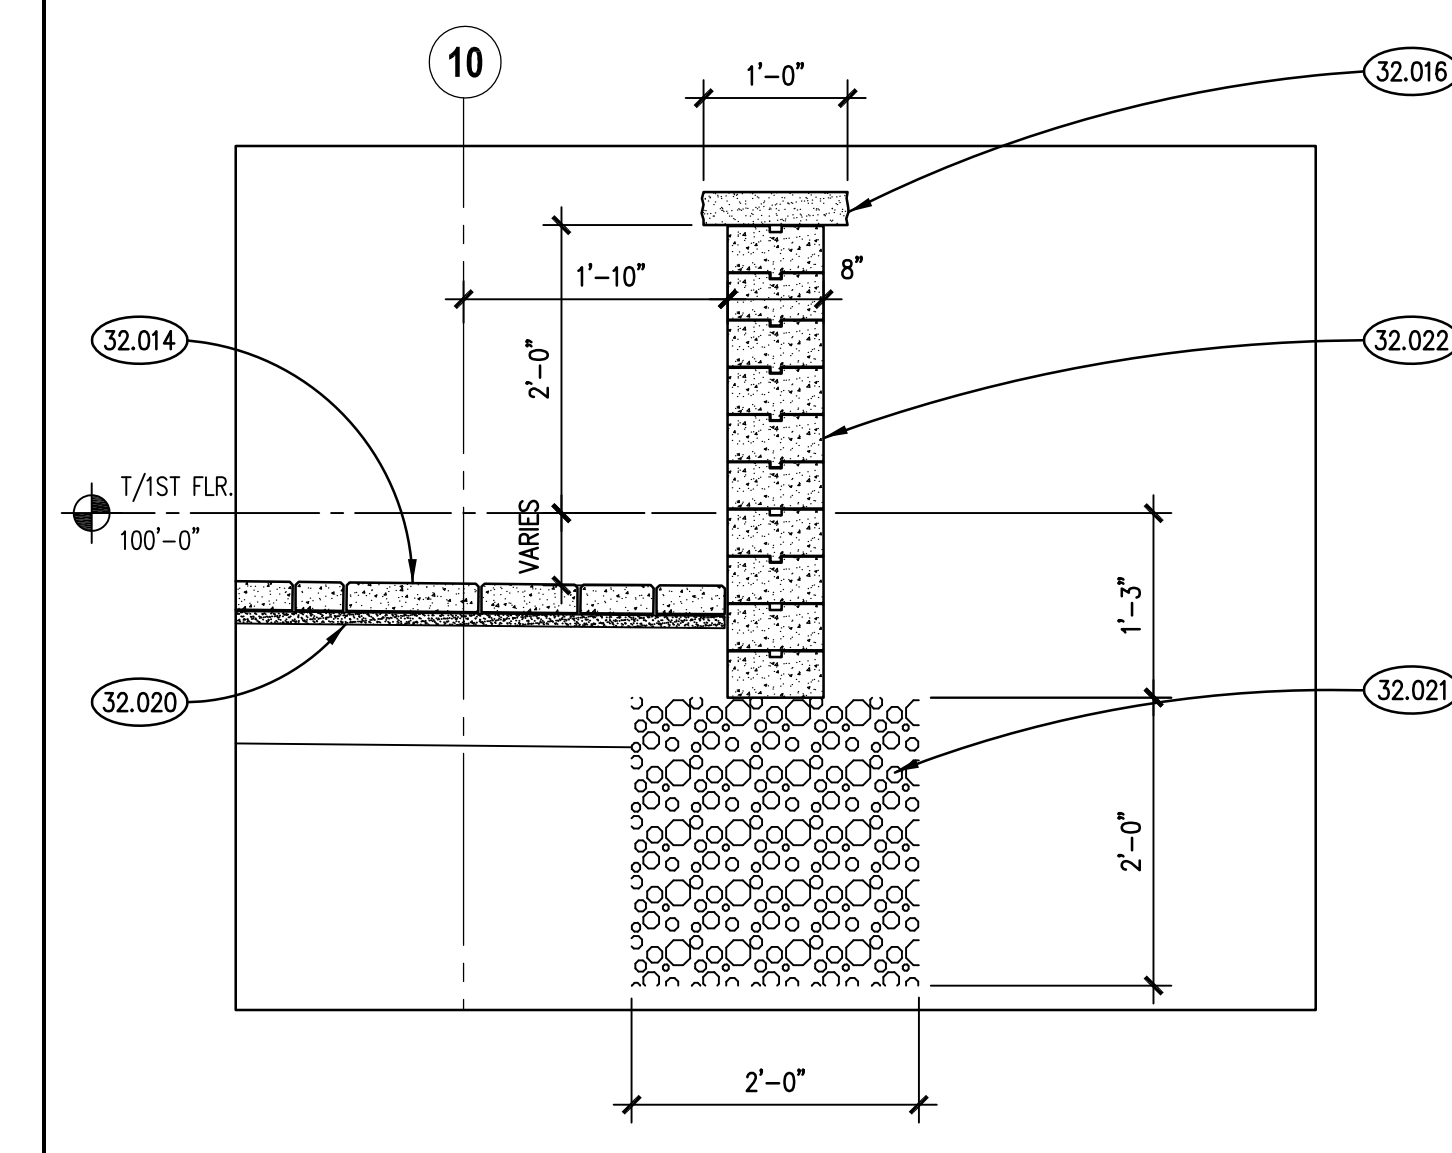


SECTION DETAIL @ GARDEN WALL
SCALE: 3/4" = 1'-0" 2

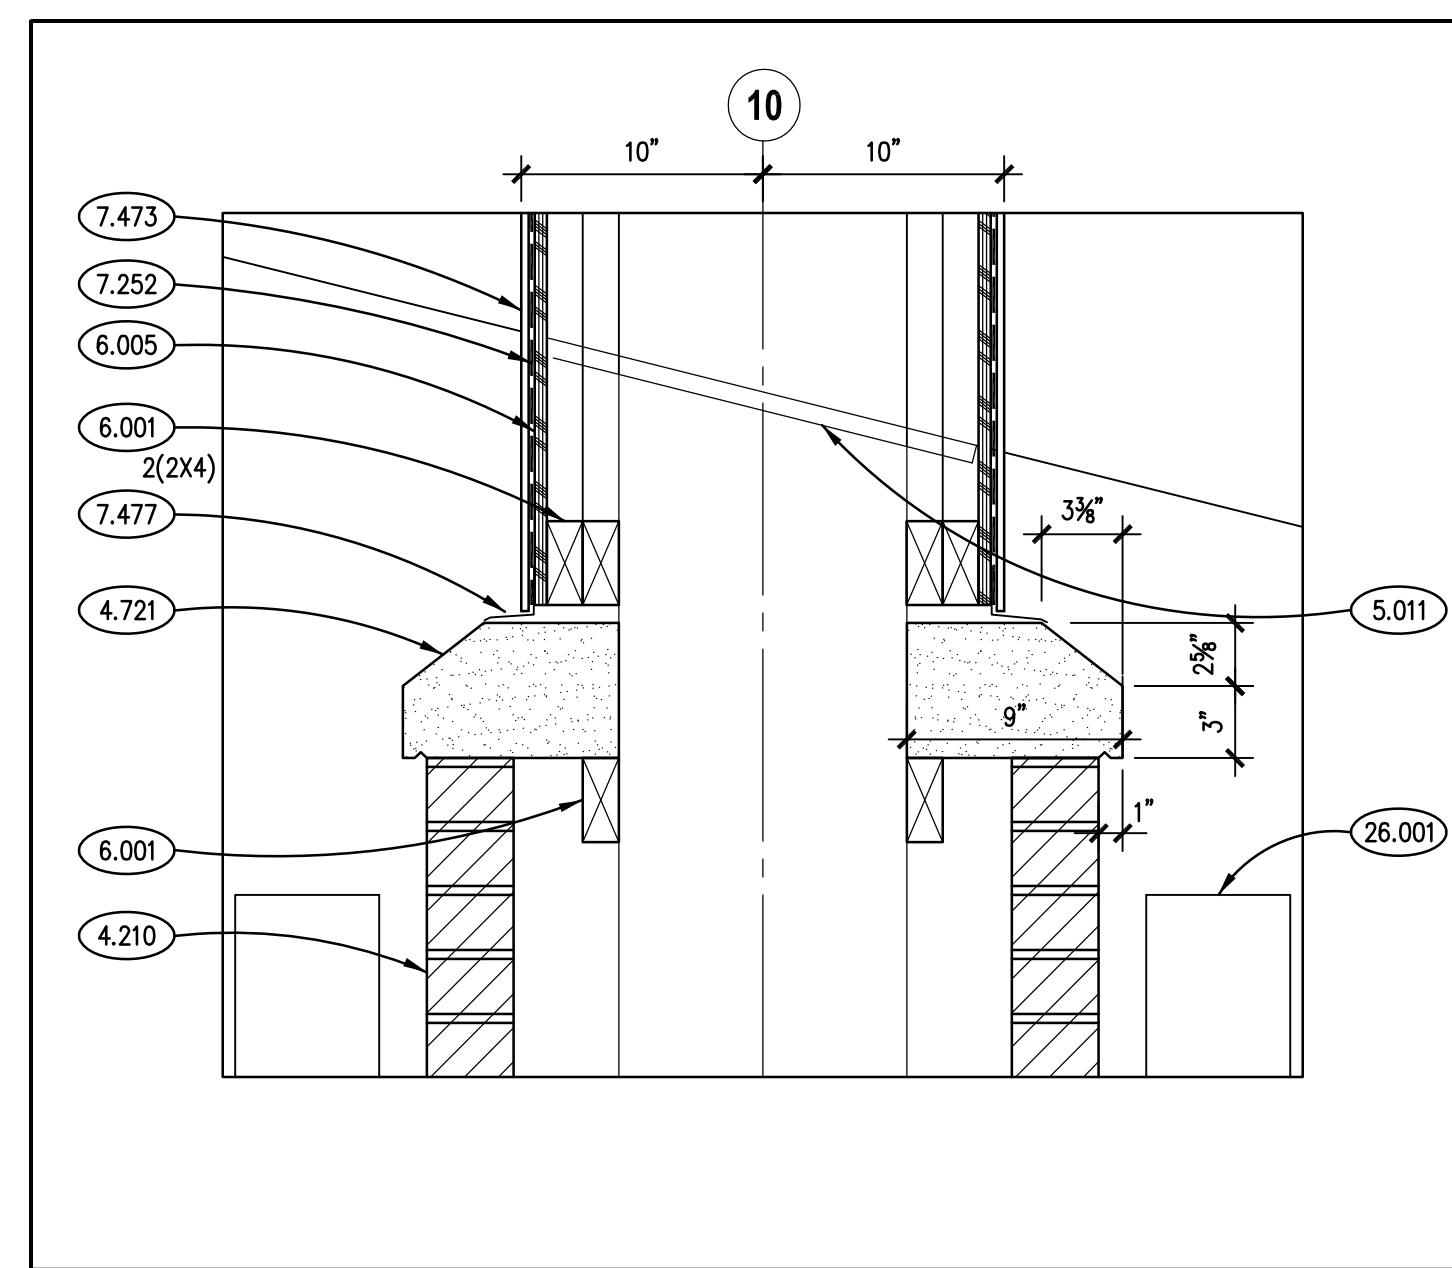


SECTION DETAIL
SCALE: 3" = 1'-0" 5

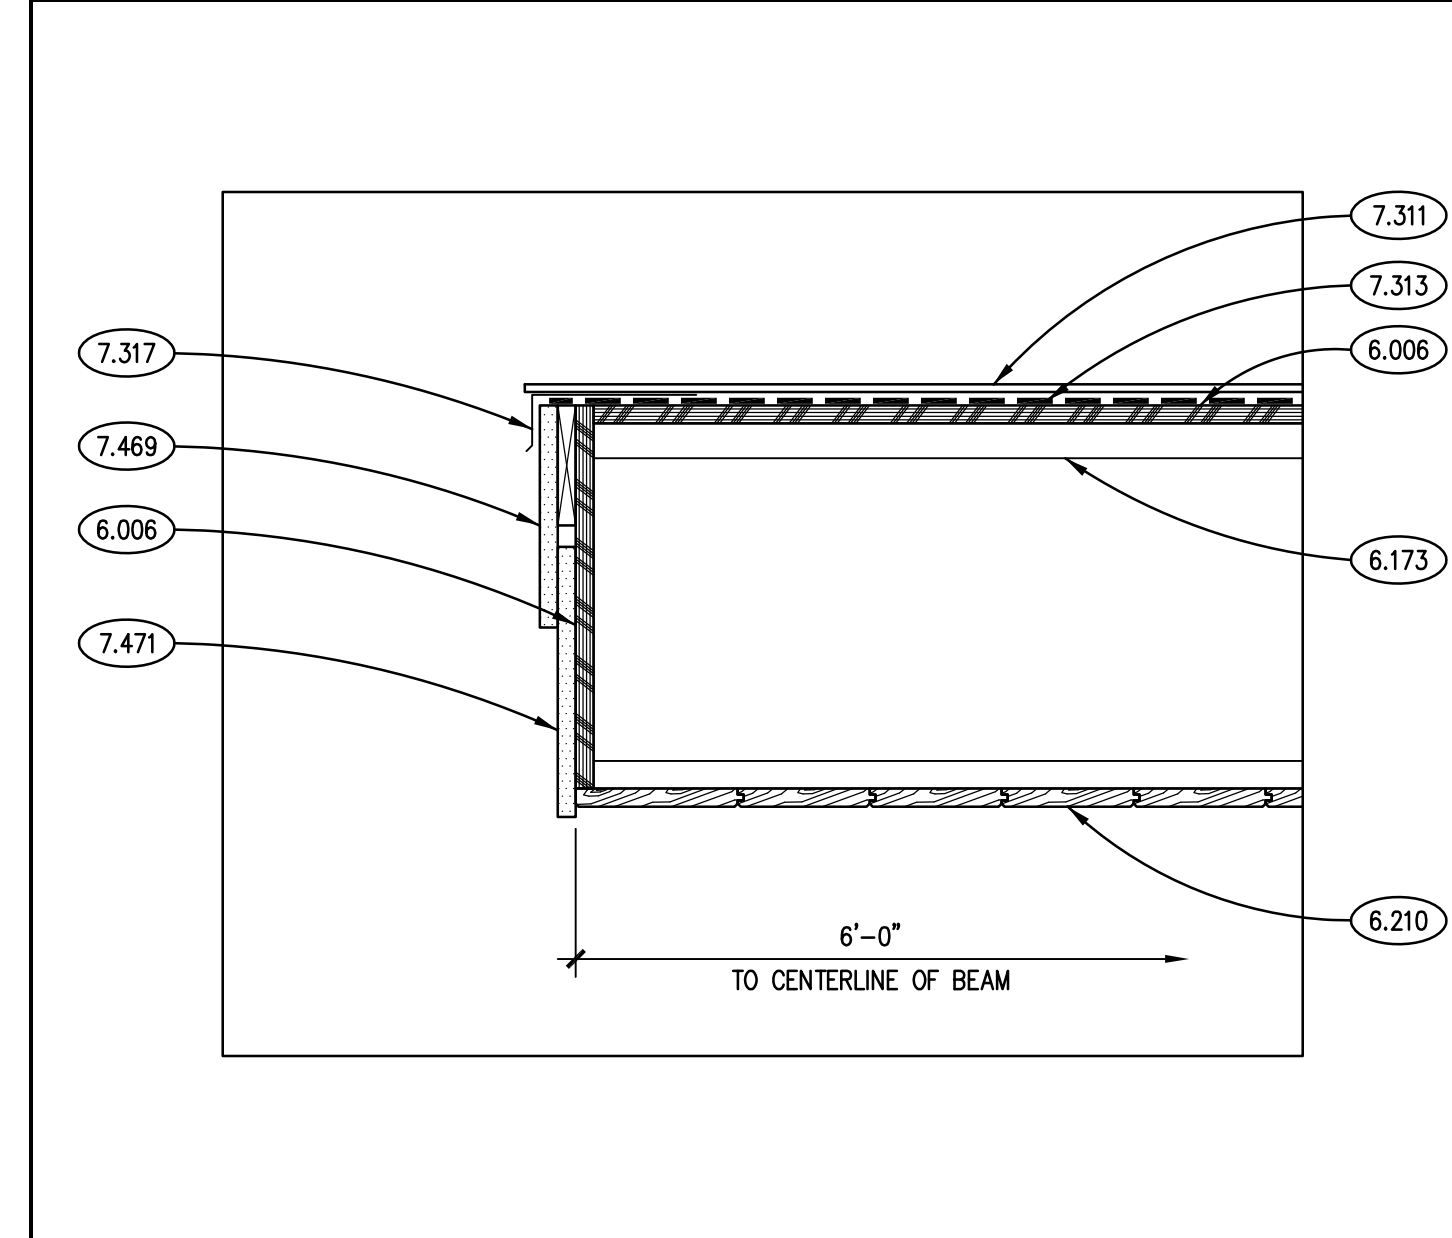

CANOPY ROOF EDGE DETAIL TYP.
SCALE: 3" = 1'-0" 4

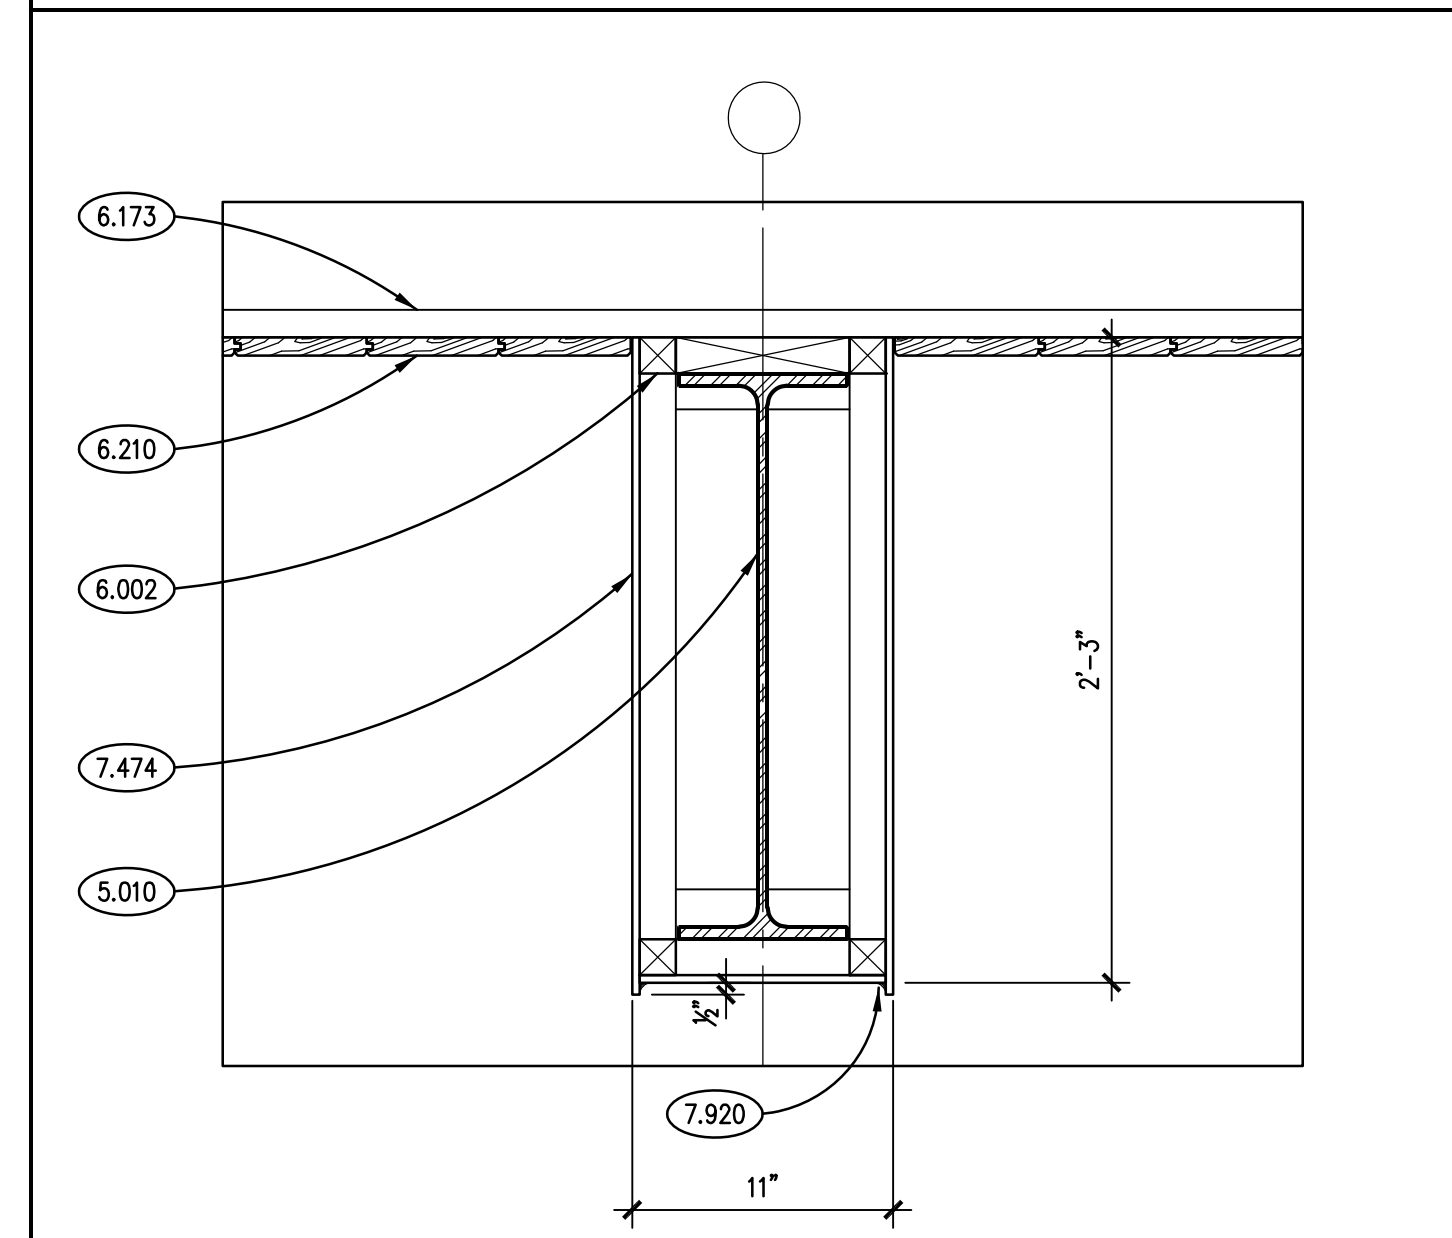

BEAM FUR-OUT DETAIL TYP.
SCALE: 3" = 1'-0" 3

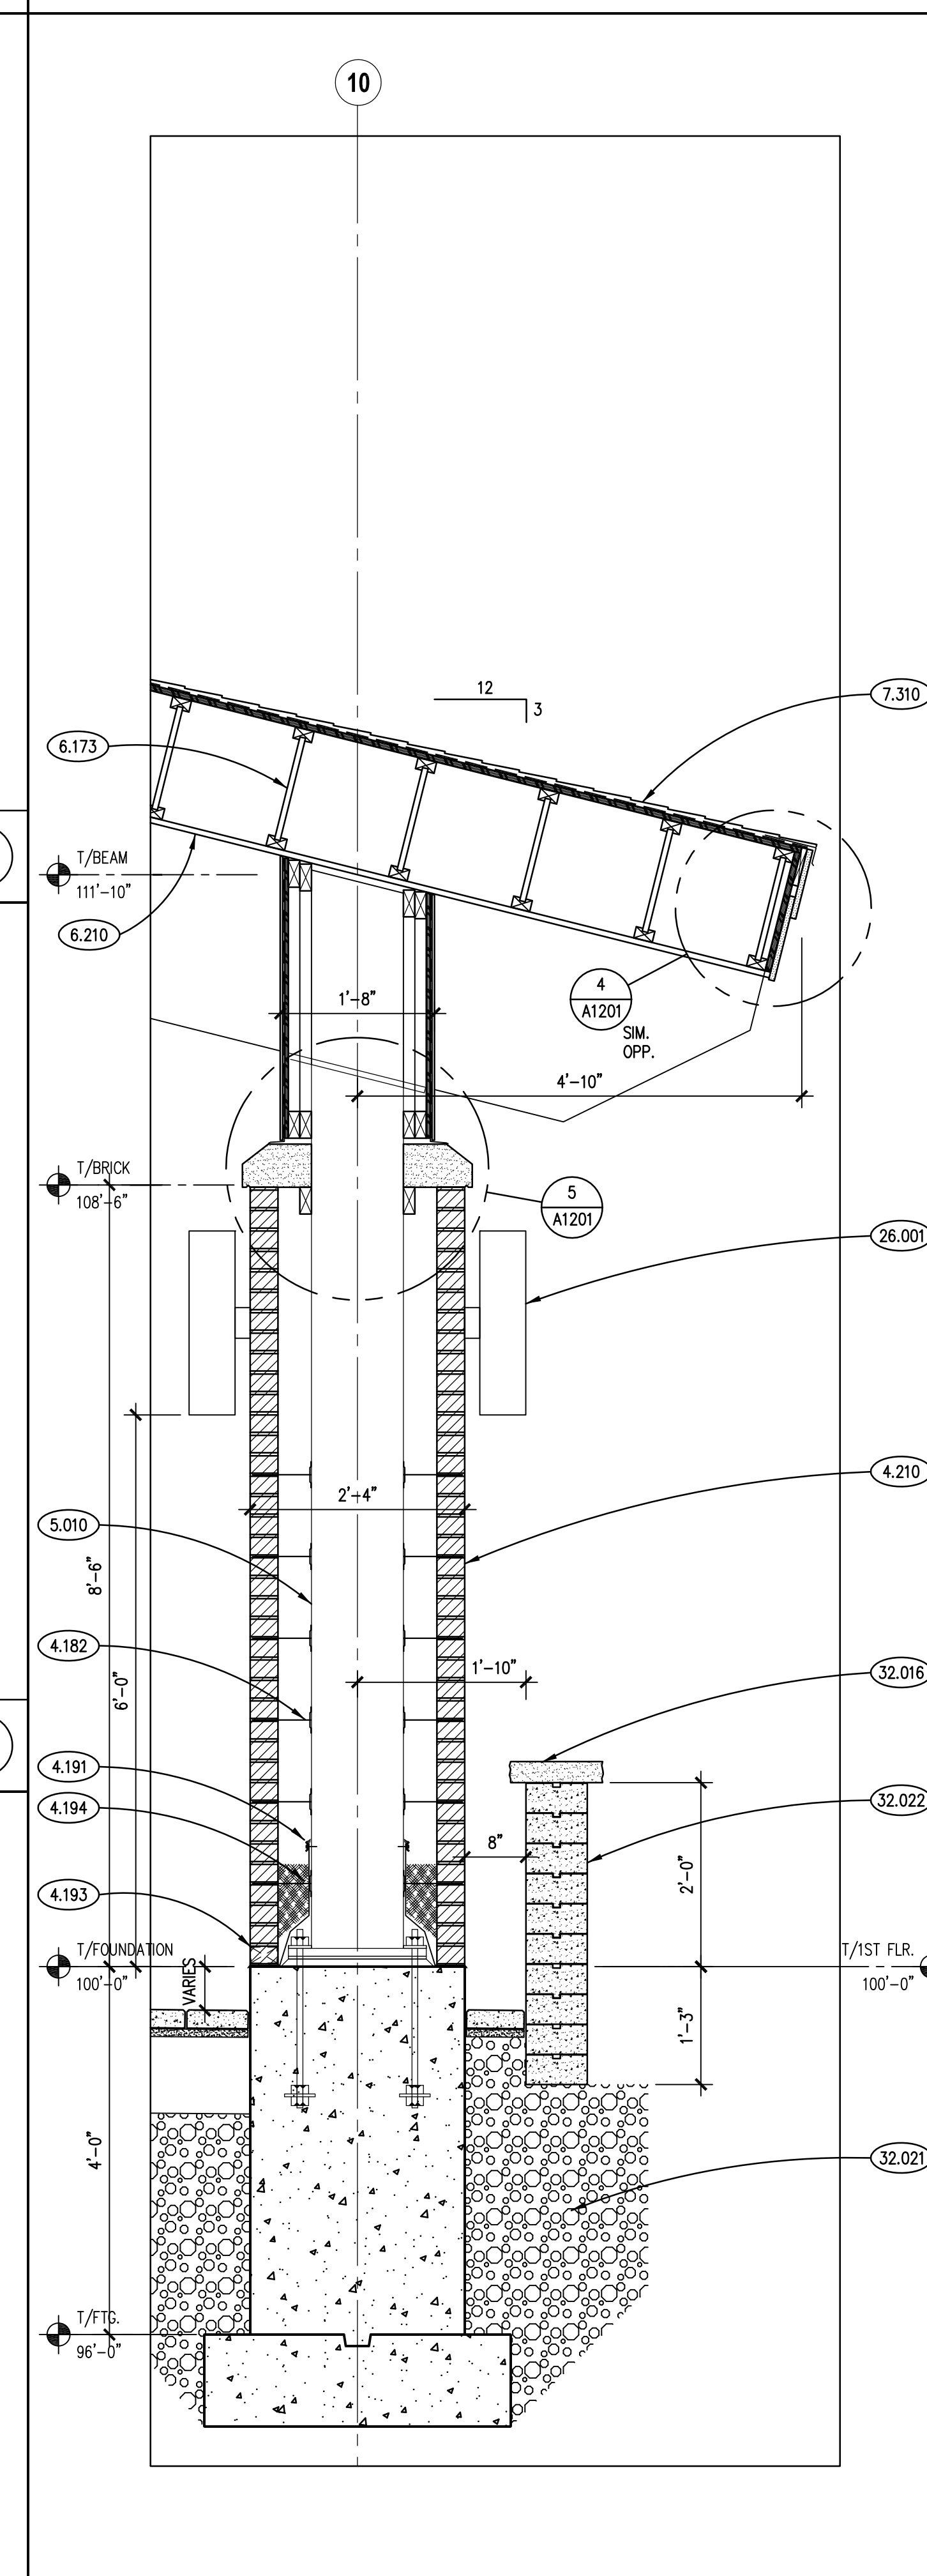

SECTION @ CANOPY COLUMN TYP.
SCALE: 3/4" = 1'-0" 1

GENERAL NOTES

1. REFER TO DRAWING G100 FOR PROJECT GENERAL NOTES.
2. PREP. 2 COAT PRIME & PAINT ALL TRIM, DOORS, UNDERSIDE OF ROOF RAFTER TAILS AND TONGUE & GROOVE DECKING. TYPICAL.

ISSUED	
01/06/22	BID DOCUMENTS

JOB NO.	19-429-1250
DRAWN	PJT
CHECKED	CJH
APPROVED	CJH

SHEET TITLE

SECTION DETAILS


SHEET NUMBER

A1201

KEYNOTES

KEYNOTES ARE TYPICALLY NOT DUPLICATED WITHIN A GIVEN DETAIL. AN UN-KEYNOTED ITEM IN A DETAIL IS THE SAME AS A KEYNOTED ITEM HAVING THE SAME APPEARANCE WITHIN THE SAME DETAIL.

- 23.100 REMOVE EXHAUST FAN. FIELD VERIFY DUCT ROUTING AND REMOVE ALL EXHAUST DUCTWORK BACK TO ROOF/WALL TERMINATION. PROVIDE PERMANENT INSULATED CAP ON EXHAUST TERMINATION.
- 23.101 REMOVE RETURN GRILLE BETWEEN OPEN STUDS. PROVIDE PERMANENT CAP ON RETURN DUCT MATCHING EXISTING.
- 23.102 REMOVE ABANDONED DRYER EXHAUST VENT IN ITS ENTIRETY.
- 23.103 REMOVE SUPPLY REGISTER. REMOVE DUCT BACK AS REQUIRED FOR NEW REGISTER LOCATION. REFER TO NEW WORK PLANS FOR NEW LOCATION. REFER TO ARCHITECTURAL PLANS FOR PATCHING FLOOR.
- 23.106 REMOVE SUPPLY REGISTER. PROVIDE TEMPORARY CAP ON DUCT FOR NEW CONNECTION.

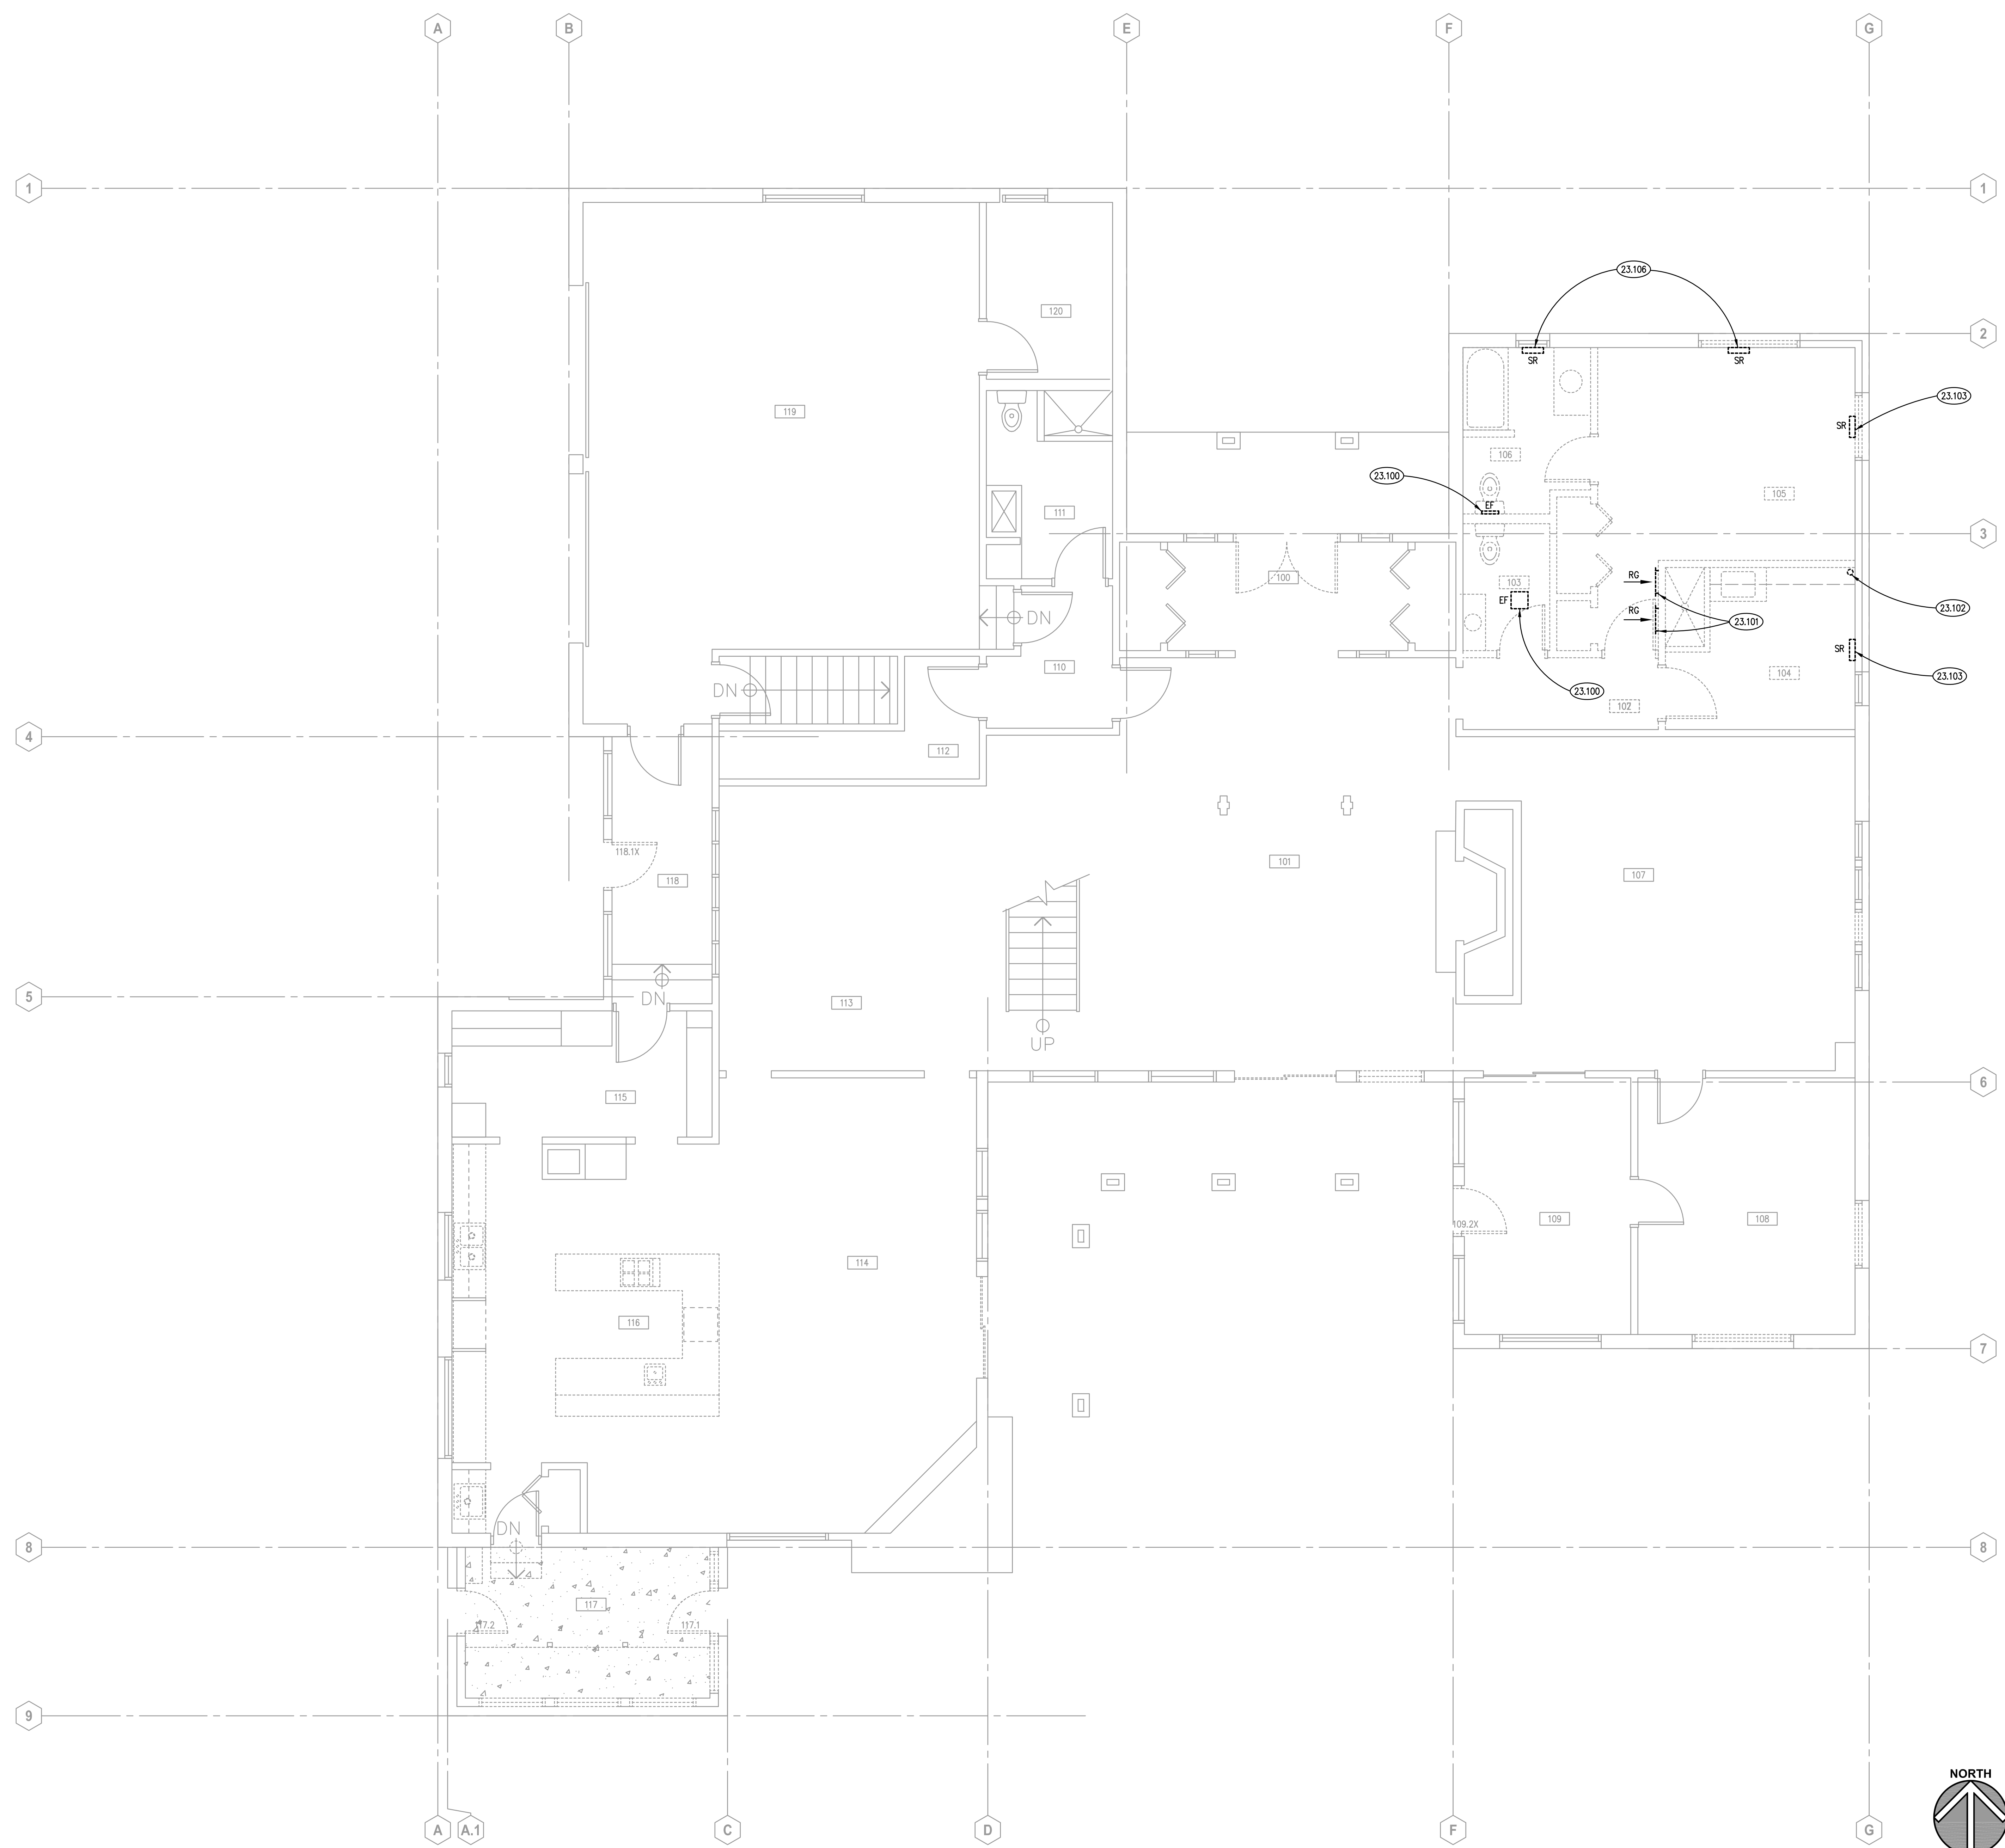

ROOM SCHEDULE

RM. NO.	ROOM NAME	RM. NO.	ROOM NAME
105	EXISTING BEDROOM		
106	EXISTING BATHROOM		
107	EXISTING LIVING ROOM		
108	EXISTING STORAGE		
109	EXISTING STORAGE		
110	EXISTING CORRIDOR		
111	EXISTING BATHROOM		
112	EXISTING JANITOR'S CLOSET		
113	EXISTING DINING ROOM		
114	EXISTING KEEPING ROOM		
115	EXISTING PANTRY		
116	EXISTING KITCHENETTE		
117	EXISTING GREEN HOUSE		
118	EXISTING FOYER		
119	EXISTING GARAGE		
120	EXISTING STORAGE		

GENERAL NOTES

1. REFER TO DRAWING G100 FOR PROJECT GENERAL NOTES.
2. ALL PIPING, DUCTWORK AND RACEWAYS ARE SHOWN DIAGMATICALLY AND DO NOT SHOW ALL REQUIRED FITTINGS, OFFSETS, DROPS AND RISES. THE CONTRACTOR IS RESPONSIBLE TO PROVIDE ALL MATERIAL AND LABOR FOR A COMPLETE AND WORKING SYSTEM. COORDINATE WITH OTHER TRADES FOR SPACE AVAILABLE AND RELATIVE LOCATIONS OF EQUIPMENT, PIPING, DUCTWORK, ETC.
3. EXISTING PIPING, DUCTWORK AND RACEWAYS INDICATED ON THESE PLANS SHALL BE FIELD VERIFIED FOR EXACT LOCATIONS, QUANTITY AND SIZES.
4. ALL TAPES AND MASTICS USED TO SEAL DUCTWORK LISTED AND LABELED IN ACCORDANCE WITH UL 181A SHALL BE MARKED ACCORDINGLY. ALL TAPES AND MASTICS USED TO SEAL FLEXIBLE DUCTS AND AIR CONNECTORS SHALL COMPLY WITH UL 181B AND MARKED ACCORDINGLY.
5. THERMOSTATIC CONTROLS OF EQUIPMENT SHALL HAVE A 5' F DEADBAND.
6. GENERALLY, SMALL DIAMETER PIPE RUNS FROM DRIPS, CONDENSATE PANS AND OTHER SERVICES ARE NOT SHOWN BUT MUST BE PROVIDED. CONDENSATE DRAINS SHALL BE CONFIGURED WITH FITTINGS AND/OR UNIONS TO PERMIT CLEARING OF BLOCKAGES AND PERFORMANCE OF MAINTENANCE WITHOUT CUTTING OF THE LINES.
7. SPACE ALLOCATION, COORDINATION WITH ELECTRICAL, ARCHITECTURAL & OTHER MECHANICAL COMPONENTS HAVE BEEN MADE WITH RESPECT TO ALL EQUIPMENT SCHEDULED ON THESE DRAWINGS AND IN THE SPECIFICATIONS OF THE FIRST NAMED MANUFACTURER ONLY. OTHER MANUFACTURERS ARE ACCEPTABLE PROVIDED THEY MEET PERFORMANCE REQUIREMENTS AND FOREMENTIONED COORDINATION.
8. DO NOT CUT THROUGH THE MASONRY BOND BEAMS OR OTHER STRUCTURAL ELEMENT WHEN INSTALLING OPENINGS REQUIRED FOR ALL DUCTWORK, PIPING, CONDUITS OR OTHER WORK. CONTRACTOR CUTTING THROUGH OR OTHERWISE DAMAGING THESE ELEMENTS WILL BE RESPONSIBLE FOR ALL ASSOCIATED ENGINEERING FEES AND SUBSEQUENT RETRO-FIT/REINFORCING DEEMED NECESSARY TO REINSTATE THE CONTINUITY OF THE DISRUPTED ELEMENTS.
9. ALL ROOFTOP EQUIPMENT (ARCHITECTURAL, MECHANICAL, ELECTRICAL, ETC.) AND THEIR CORRESPONDING CURBS TO BE ATTACHED TO THE STRUCTURAL FRAMING AS REQUIRED TO RESIST WIND AND SEISMIC FORCES. ANCHORAGE TO METAL DECKING IS NOT ACCEPTABLE. CONTRACTOR/MANUFACTURER TO CONSULT AN INDEPENDENT STRUCTURAL ENGINEER TO REVIEW, DESIGN AND DETAIL THE REQUIRED CONNECTIONS.

FIRST FLOOR MECHANICAL DEMOLITION PLAN

SCALE: 1/4" = 1'-0" 1

Kluber, Inc.
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www.kluberinc.com

KEN PICKERILL HOUSE RENOVATIONS

KENDALL COUNTY FOREST PRESERVE DISTRICT
110 W. MADISON STREET
YORKVILLE, IL 60560

ISSUED	
01/02/21	BID DOCUMENTS


JOB NO.	19-429-1250
DRAWN	BWG
CHECKED	DDW
APPROVED	DDW
SHEET TITLE	
FIRST FLOOR MECHANICAL DEMOLITION PLAN	
SHEET NUMBER	

M210

KEYNOTES

KEYNOTES ARE TYPICALLY NOT DUPLICATED WITHIN A GIVEN DETAIL. AN UN-KENYOTED ITEM IN A DETAIL IS THE SAME AS A KEYNOTED ITEM HAVING THE SAME APPEARANCE WITHIN THE SAME DETAIL.

- 23.104 FIELD VERIFY ROOF TOP UNIT ROOF MOUNTED DUCTWORK TO VERIFY WHICH DUCT IS SUPPLY AND RETURN.
- 23.105 REMOVE ROOF TOP UNIT, REMOVE SUPPLY AND RETURN DUCTWORK BACK TO WALL AS SHOWN. PROVIDE TEMPORARY WEATHERTIGHT CAP ON DUCT FOR NEW CONNECTION.

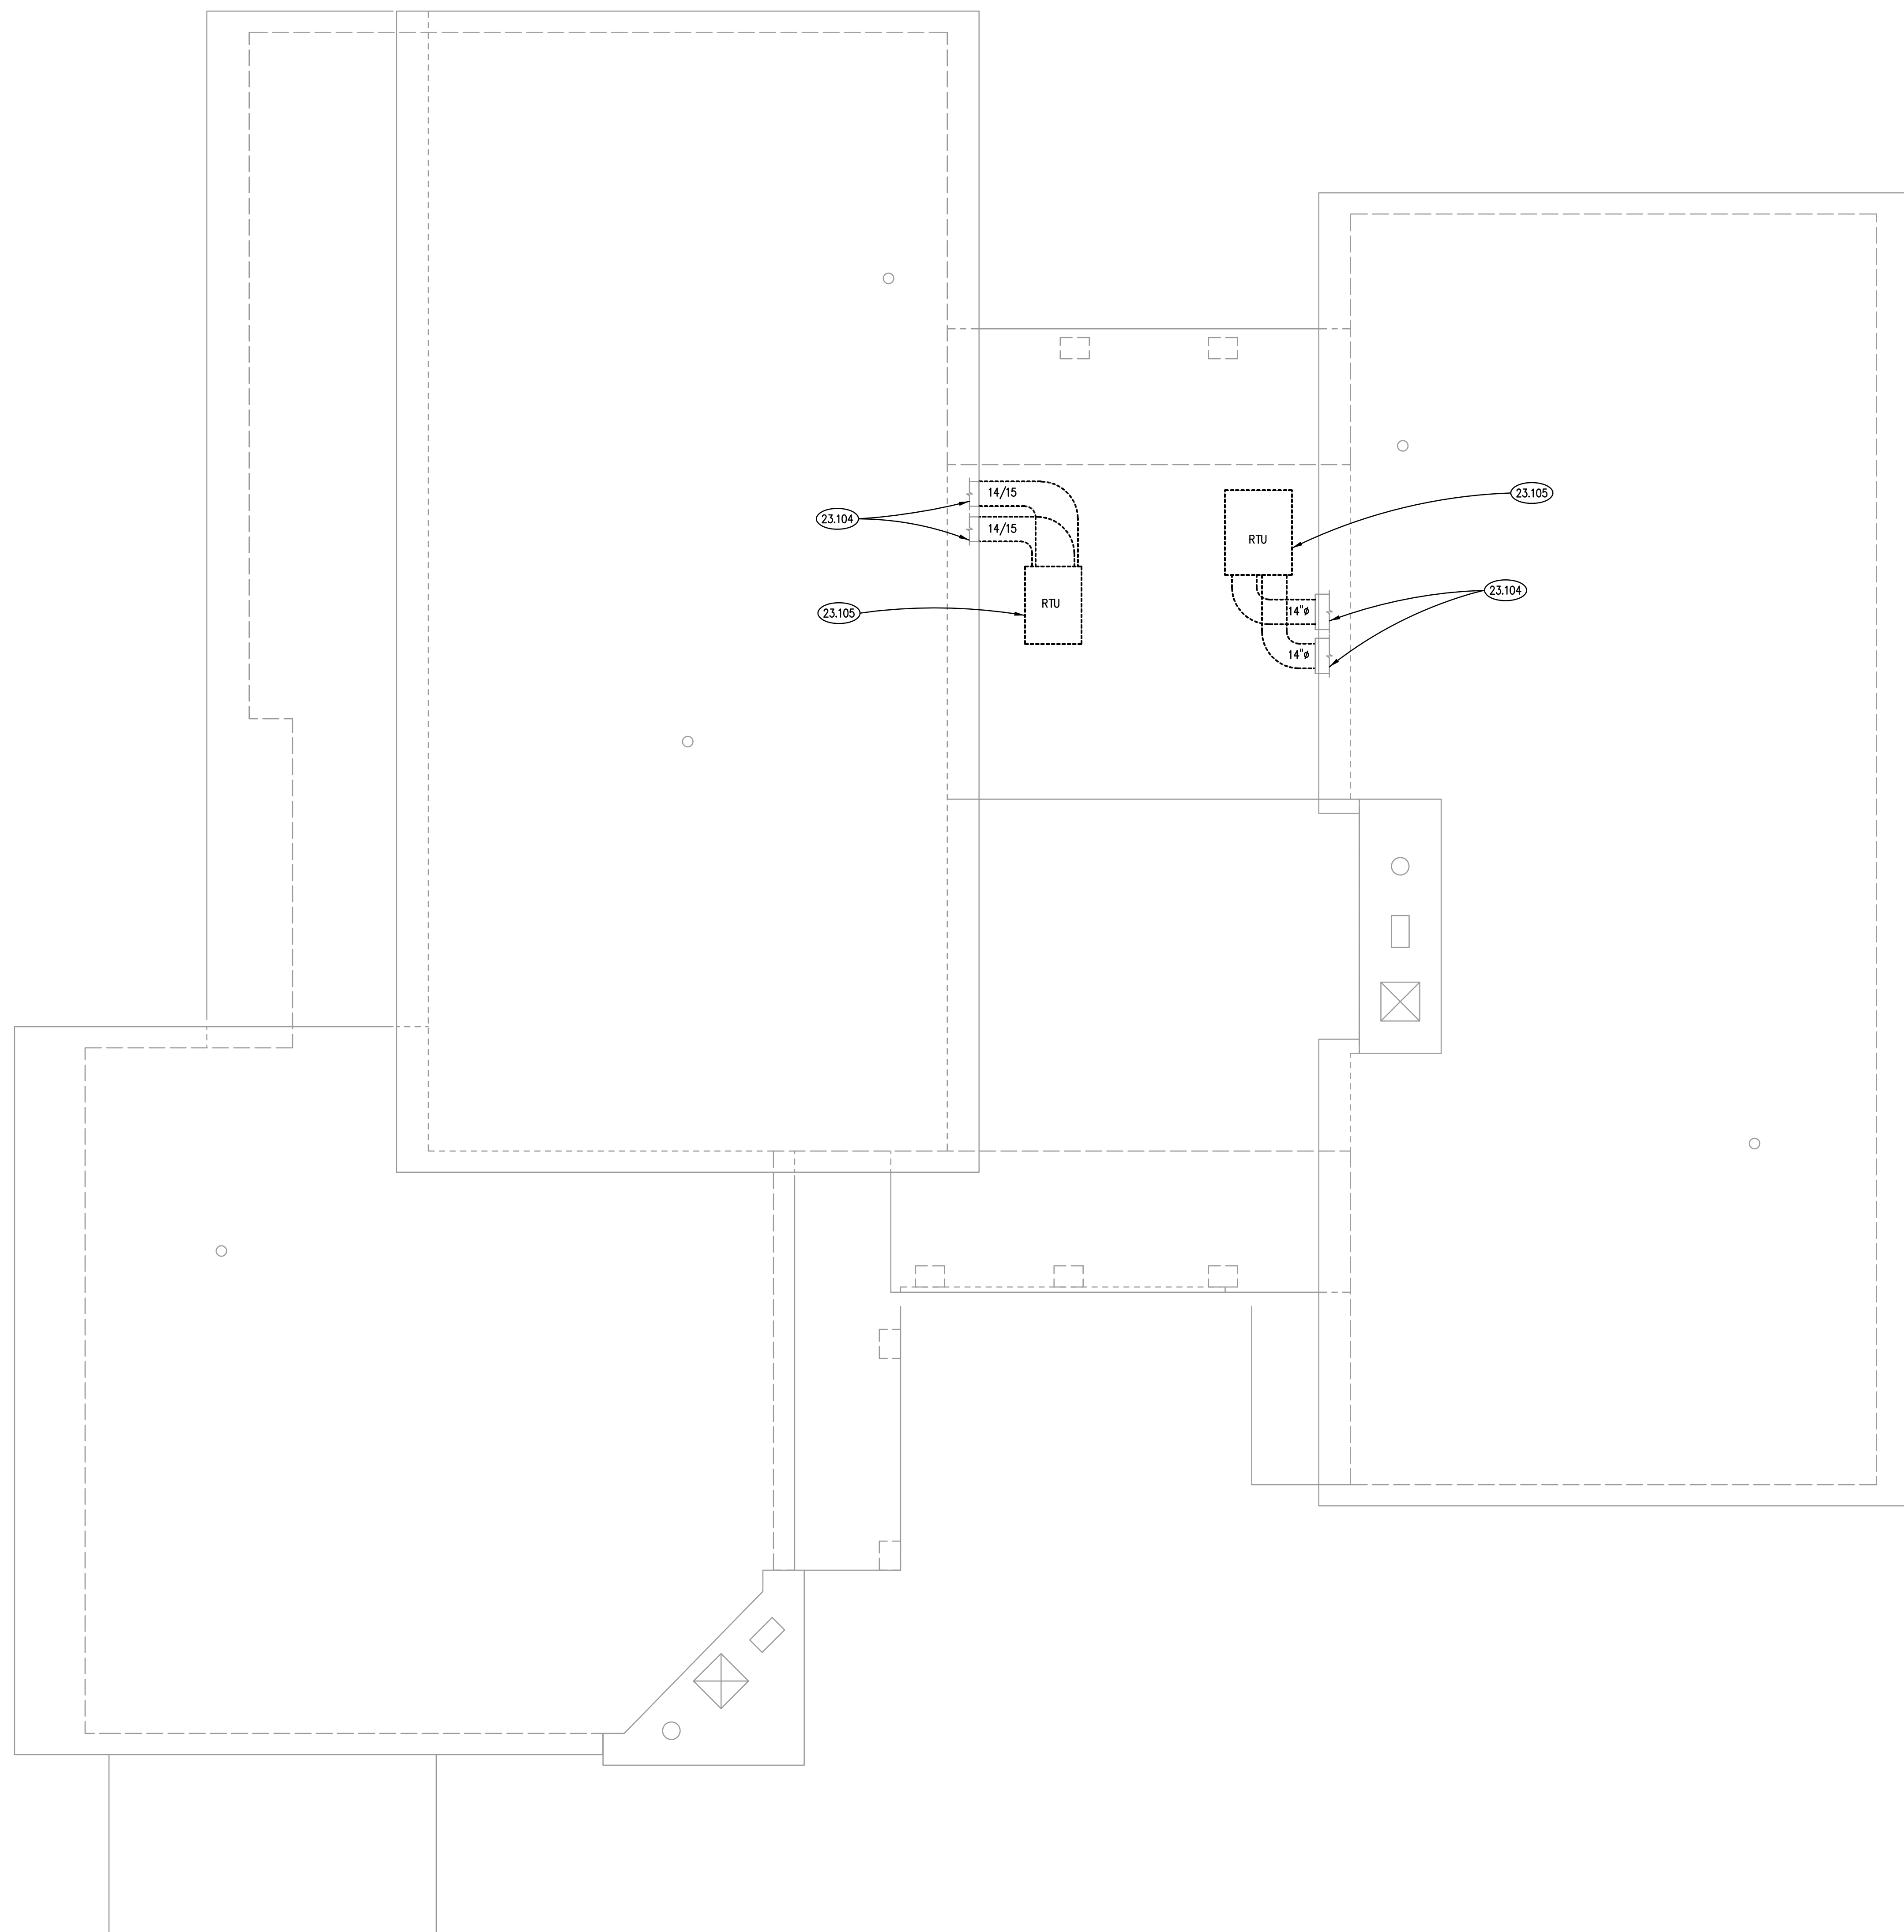

GENERAL NOTES

- REFER TO DRAWING G100 FOR PROJECT GENERAL NOTES.
- ALL PIPING, DUCTWORK AND RACEWAYS ARE SHOWN DIAGRAMMATICALLY AND DO NOT SHOW ALL REQUIRED FITTINGS, OFFSETS, DROPS AND RISES. THE CONTRACTOR IS RESPONSIBLE TO PROVIDE ALL MATERIAL AND LABOR FOR A COMPLETE AND WORKING SYSTEM. COORDINATE WITH OTHER TRADES FOR SPACE AVAILABLE AND RELATIVE LOCATIONS OF EQUIPMENT, PIPING, DUCTWORK, ETC.
- EXISTING PIPING, DUCTWORK AND RACEWAYS INDICATED ON THESE PLANS SHALL BE FIELD VERIFIED FOR EXACT LOCATIONS, QUANTITY AND SIZES.
- ALL TAPES AND MASTICS USED TO SEAL DUCTWORK LISTED AND LABELED IN ACCORDANCE WITH UL 181A SHALL BE MARKED ACCORDINGLY. ALL TAPES AND MASTICS USED TO SEAL FLEXIBLE DUCTS AND AIR CONNECTORS SHALL COMPLY WITH UL 181B AND MARKED ACCORDINGLY.
- THERMOSTATIC CONTROLS OF EQUIPMENT SHALL HAVE A 5' F DEADBAND.
- GENERALLY, SMALL DIAMETER PIPE RUNS FROM DRIPS, CONDENSATE PANS AND OTHER SERVICES ARE NOT SHOWN BUT MUST BE PROVIDED. CONDENSATE DRAINS SHALL BE CONFIGURED WITH FITTINGS AND/OR UNIONS TO PERMIT CLEARING OF BLOCKAGES AND PERFORMANCE OF MAINTENANCE WITHOUT CUTTING OF THE LINES.
- SPACE ALLOCATION, COORDINATION WITH ELECTRICAL, ARCHITECTURAL & OTHER MECHANICAL COMPONENTS HAVE BEEN MADE WITH RESPECT TO ALL EQUIPMENT SCHEDULED ON THESE DRAWINGS AND IN THE SPECIFICATIONS OF THE FIRST NAMED MANUFACTURER ONLY. OTHER MANUFACTURERS ARE ACCEPTABLE PROVIDED THEY MEET PERFORMANCE REQUIREMENTS AND AFOREMENTIONED COORDINATION.
- DO NOT CUT THROUGH THE MASONRY BOND BEAMS OR OTHER STRUCTURAL ELEMENT WHEN INSTALLING OPENINGS REQUIRED FOR ALL DUCTWORK, PIPING, CONDUITS OR OTHER WORK. CONTRACTOR CUTTING THROUGH OR OTHERWISE DAMAGING THESE ELEMENTS WILL BE RESPONSIBLE FOR ALL ASSOCIATED ENGINEERING FEES AND SUBSEQUENT RETRO-FIT/REINFORCING DEEMED NECESSARY TO REINSTATE THE CONTINUITY OF THE DISRUPTED ELEMENTS.
- ALL ROOFTOP EQUIPMENT (ARCHITECTURAL, MECHANICAL, ELECTRICAL, ETC.) AND THEIR CORRESPONDING CURBS TO BE ATTACHED TO THE STRUCTURAL FRAMING AS REQUIRED TO RESIST WIND AND SEISMIC FORCES. ANCHORAGE TO METAL DECKING IS NOT ACCEPTABLE. CONTRACTOR/MANUFACTURER TO CONSULT AN INDEPENDENT STRUCTURAL ENGINEER TO REVIEW, DESIGN AND DETAIL THE REQUIRED CONNECTIONS.

MECHANICAL DEMOLITION ROOF PLAN

SCALE: 1/4" = 1'-0"

1

NOTE: SCALES DEPICTED ON THIS DRAWING ARE NOT CORRECT UNLESS PLOTTED SHEET SIZE IS 30 X 42 INCHES.

KLUBER

Architects + Engineers

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KEN PICKERILL HOUSE RENOVATIONS

KENDALL COUNTY FOREST PRESERVE DISTRICT
110 W. MADISON STREET
YORKVILLE, IL 60560

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01/02/21	BID DOCUMENTS

JOB NO.	19-429-1250
DRAWN	BWG
CHECKED	DDW
APPROVED	DDW

SHEET TITLE
MECHANICAL DEMOLITION ROOF PLAN

SHEET NUMBER

M230

KEYNOTES

KEYNOTES ARE TYPICALLY NOT DUPLICATED WITHIN A GIVEN DETAIL. AN UN-KEYNOTED ITEM IN A DETAIL IS THE SAME AS A KEYNOTED ITEM HAVING THE SAME APPEARANCE WITHIN THE SAME DETAIL.

- 23.200 PROVIDE NEW SUPPLY REGISTER S-1. REGISTER SHALL BE DOUBLE DEFLECTION BASEBOARD MOUNTED MATCHING EXISTING. PROVIDE ALL MATERIALS AND LABOR TO RECONFIGURE DUCTWORK IN BASEMENT TO MAKE THE NEW CONNECTION.
- 23.201 PROVIDE RETURN GRILLE R-1. RETURN GRILLE SHALL BE TITUS MODEL 350RL OR EQUAL, NECK SIZE = 18X16. MOUNT RETURN GRILLE WITHIN 24 INCHES OF CEILING. FIELD VERIFY EXISTING RETURN DUCTWORK. PROVIDE ALL MATERIALS AND LABOR TO RECONFIGURE EXISTING RETURN DUCTWORK TO MAKE THE CONNECTION.
- 23.202 PROVIDE WALL TERMINATION FOR EXHAUST FAN. MAINTAIN A MINIMUM OF 3-FEET BETWEEN EXHAUST FAN TERMINATION AND OPERABLE WINDOW.
- 23.205 PROVIDE NEW SUPPLY REGISTER S-1. REGISTER SHALL BE DOUBLE DEFLECTION BASEBOARD MOUNTED MATCHING EXISTING. FIELD VERIFY EXISTING SIZE PRIOR TO DEMOLITION.

FAN SCHEDULE

MARK	EF-1A	EF-1B	
MODEL	SP-B150	SP-B150	
AIR FLOW RATE (CFM)	140	140	
EXTERNAL STATIC PRESS (IN WG)	0.4	0.4	
DRIVE TYPE	DIRECT	DIRECT	
MOTOR SIZE (WATTS)	128	128	
ELECTRICAL (V/PH/Hz)	115/1/60	115/1/60	
FAN ENERGY INDEX (FEI)	N/A	N/A	
AREA SERVED	RM 103	RM 104	
REMARKS	1, 2, 3	1, 2, 4	

- 1. MODEL BASED ON GREENHECK.
- 2. PROVIDE WITH WC-10X3 HOODED WALL CAP TERMINATION WITH BUILT IN BIRDSCREEN AND BACKDRAFT DAMPER.
- 3. PROVIDE WITH ALUMINUM GRILLE, PRE-WIRED SPEED CONTROL, VIBRATION ISOLATORS.

SEQUENCE OF OPERATION

EF-1A/EF-1B: THE EXHAUST FAN SHALL BE ENERGIZED WHEN THE ROOM LIGHTS ARE ON.

ROOM SCHEDULE

RM. NO.	ROOM NAME	RM. NO.	ROOM NAME
105	NOT USED	120	EXISTING STORAGE
106	NOT USED		
107	EXISTING LIVING ROOM		
108	EXISTING STORAGE		
109	EXISTING STORAGE		
110	EXISTING CORRIDOR	203.1	EXISTING CLOSET
111	EXISTING BATHROOM		
112	EXISTING JANITOR'S CLOSET		
113	EXISTING DINING ROOM		
114	EXISTING KEEPING ROOM		
115	EXISTING PANTRY		
116	EXISTING KITCHEN		
117	EXISTING GREEN HOUSE		
118	EXISTING FOYER		
119	EXISTING GARAGE		

GENERAL NOTES

- 1. REFER TO DRAWING G100 FOR PROJECT GENERAL NOTES.
- 2. ALL PIPING, DUCTWORK AND RACEWAYS ARE SHOWN DIAGMATICALLY AND DO NOT SHOW ALL REQUIRED FITTINGS, OFFSETS, DROPS AND RISES. THE CONTRACTOR IS RESPONSIBLE TO PROVIDE ALL MATERIAL AND LABOR FOR A COMPLETE AND WORKING SYSTEM. COORDINATE WITH OTHER TRADES FOR SPACE AVAILABLE AND RELATIVE LOCATIONS OF EQUIPMENT, PIPING, DUCTWORK, ETC.
- 3. EXISTING PIPING, DUCTWORK AND RACEWAYS INDICATED ON THESE PLANS SHALL BE FIELD VERIFIED FOR EXACT LOCATIONS, QUANTITY AND SIZES.
- 4. ALL TAPES AND MASTICS USED TO SEAL DUCTWORK LISTED AND LABELED IN ACCORDANCE WITH UL 181A SHALL BE MARKED ACCORDINGLY. ALL TAPES AND MASTICS USED TO SEAL FLEXIBLE DUCTS AND AIR CONNECTORS SHALL COMPLY WITH UL 181B AND MARKED ACCORDINGLY.
- 5. THERMOSTATIC CONTROLS OF EQUIPMENT SHALL HAVE A 5' F DEADBAND.
- 6. GENERALLY, SMALL DIAMETER PIPE RUNS FROM DRIPS, CONDENSATE PANS AND OTHER SERVICES ARE NOT SHOWN BUT MUST BE PROVIDED. CONDENSATE DRAINS SHALL BE CONFIGURED WITH FITTINGS AND/OR UNIONS TO PERMIT CLEARING OF BLOCKAGES AND PERFORMANCE OF MAINTENANCE WITHOUT CUTTING OF THE LINES.
- 7. SPACE ALLOCATION, COORDINATION WITH ELECTRICAL, ARCHITECTURAL & OTHER MECHANICAL COMPONENTS HAVE BEEN MADE WITH RESPECT TO ALL EQUIPMENT SCHEDULED ON THESE DRAWINGS AND IN THE SPECIFICATIONS OF THE FIRST NAMED MANUFACTURER ONLY. OTHER MANUFACTURERS ARE ACCEPTABLE PROVIDED THEY MEET PERFORMANCE REQUIREMENTS AND AFOREMENTIONED COORDINATION.
- 8. DO NOT CUT THROUGH THE MASONRY BOND BEAMS OR OTHER STRUCTURAL ELEMENT WHEN INSTALLING OPENINGS REQUIRED FOR ALL DUCTWORK, PIPING, CONDUITS OR OTHER WORK. CONTRACTOR CUTTING THROUGH OR OTHERWISE DAMAGING THESE ELEMENTS WILL BE RESPONSIBLE FOR ALL ASSOCIATED ENGINEERING FEES AND SUBSEQUENT RETRO-FIT/REINFORCING DEEMED NECESSARY TO REINSTATE THE CONTINUITY OF THE DISRUPTED ELEMENTS.
- 9. ALL ROOFTOP EQUIPMENT (ARCHITECTURAL, MECHANICAL, ELECTRICAL, ETC.) AND THEIR CORRESPONDING CURBS TO BE ATTACHED TO THE STRUCTURAL FRAMING AS REQUIRED TO RESIST WIND AND SEISMIC FORCES. ANCHORAGE TO METAL DECKING IS NOT ACCEPTABLE. CONTRACTOR/MANUFACTURER TO CONSULT AN INDEPENDENT STRUCTURAL ENGINEER TO REVIEW, DESIGN AND DETAIL THE REQUIRED CONNECTIONS.



FIRST FLOOR MECHANICAL PLAN
SCALE: 1/4" = 1'-0"

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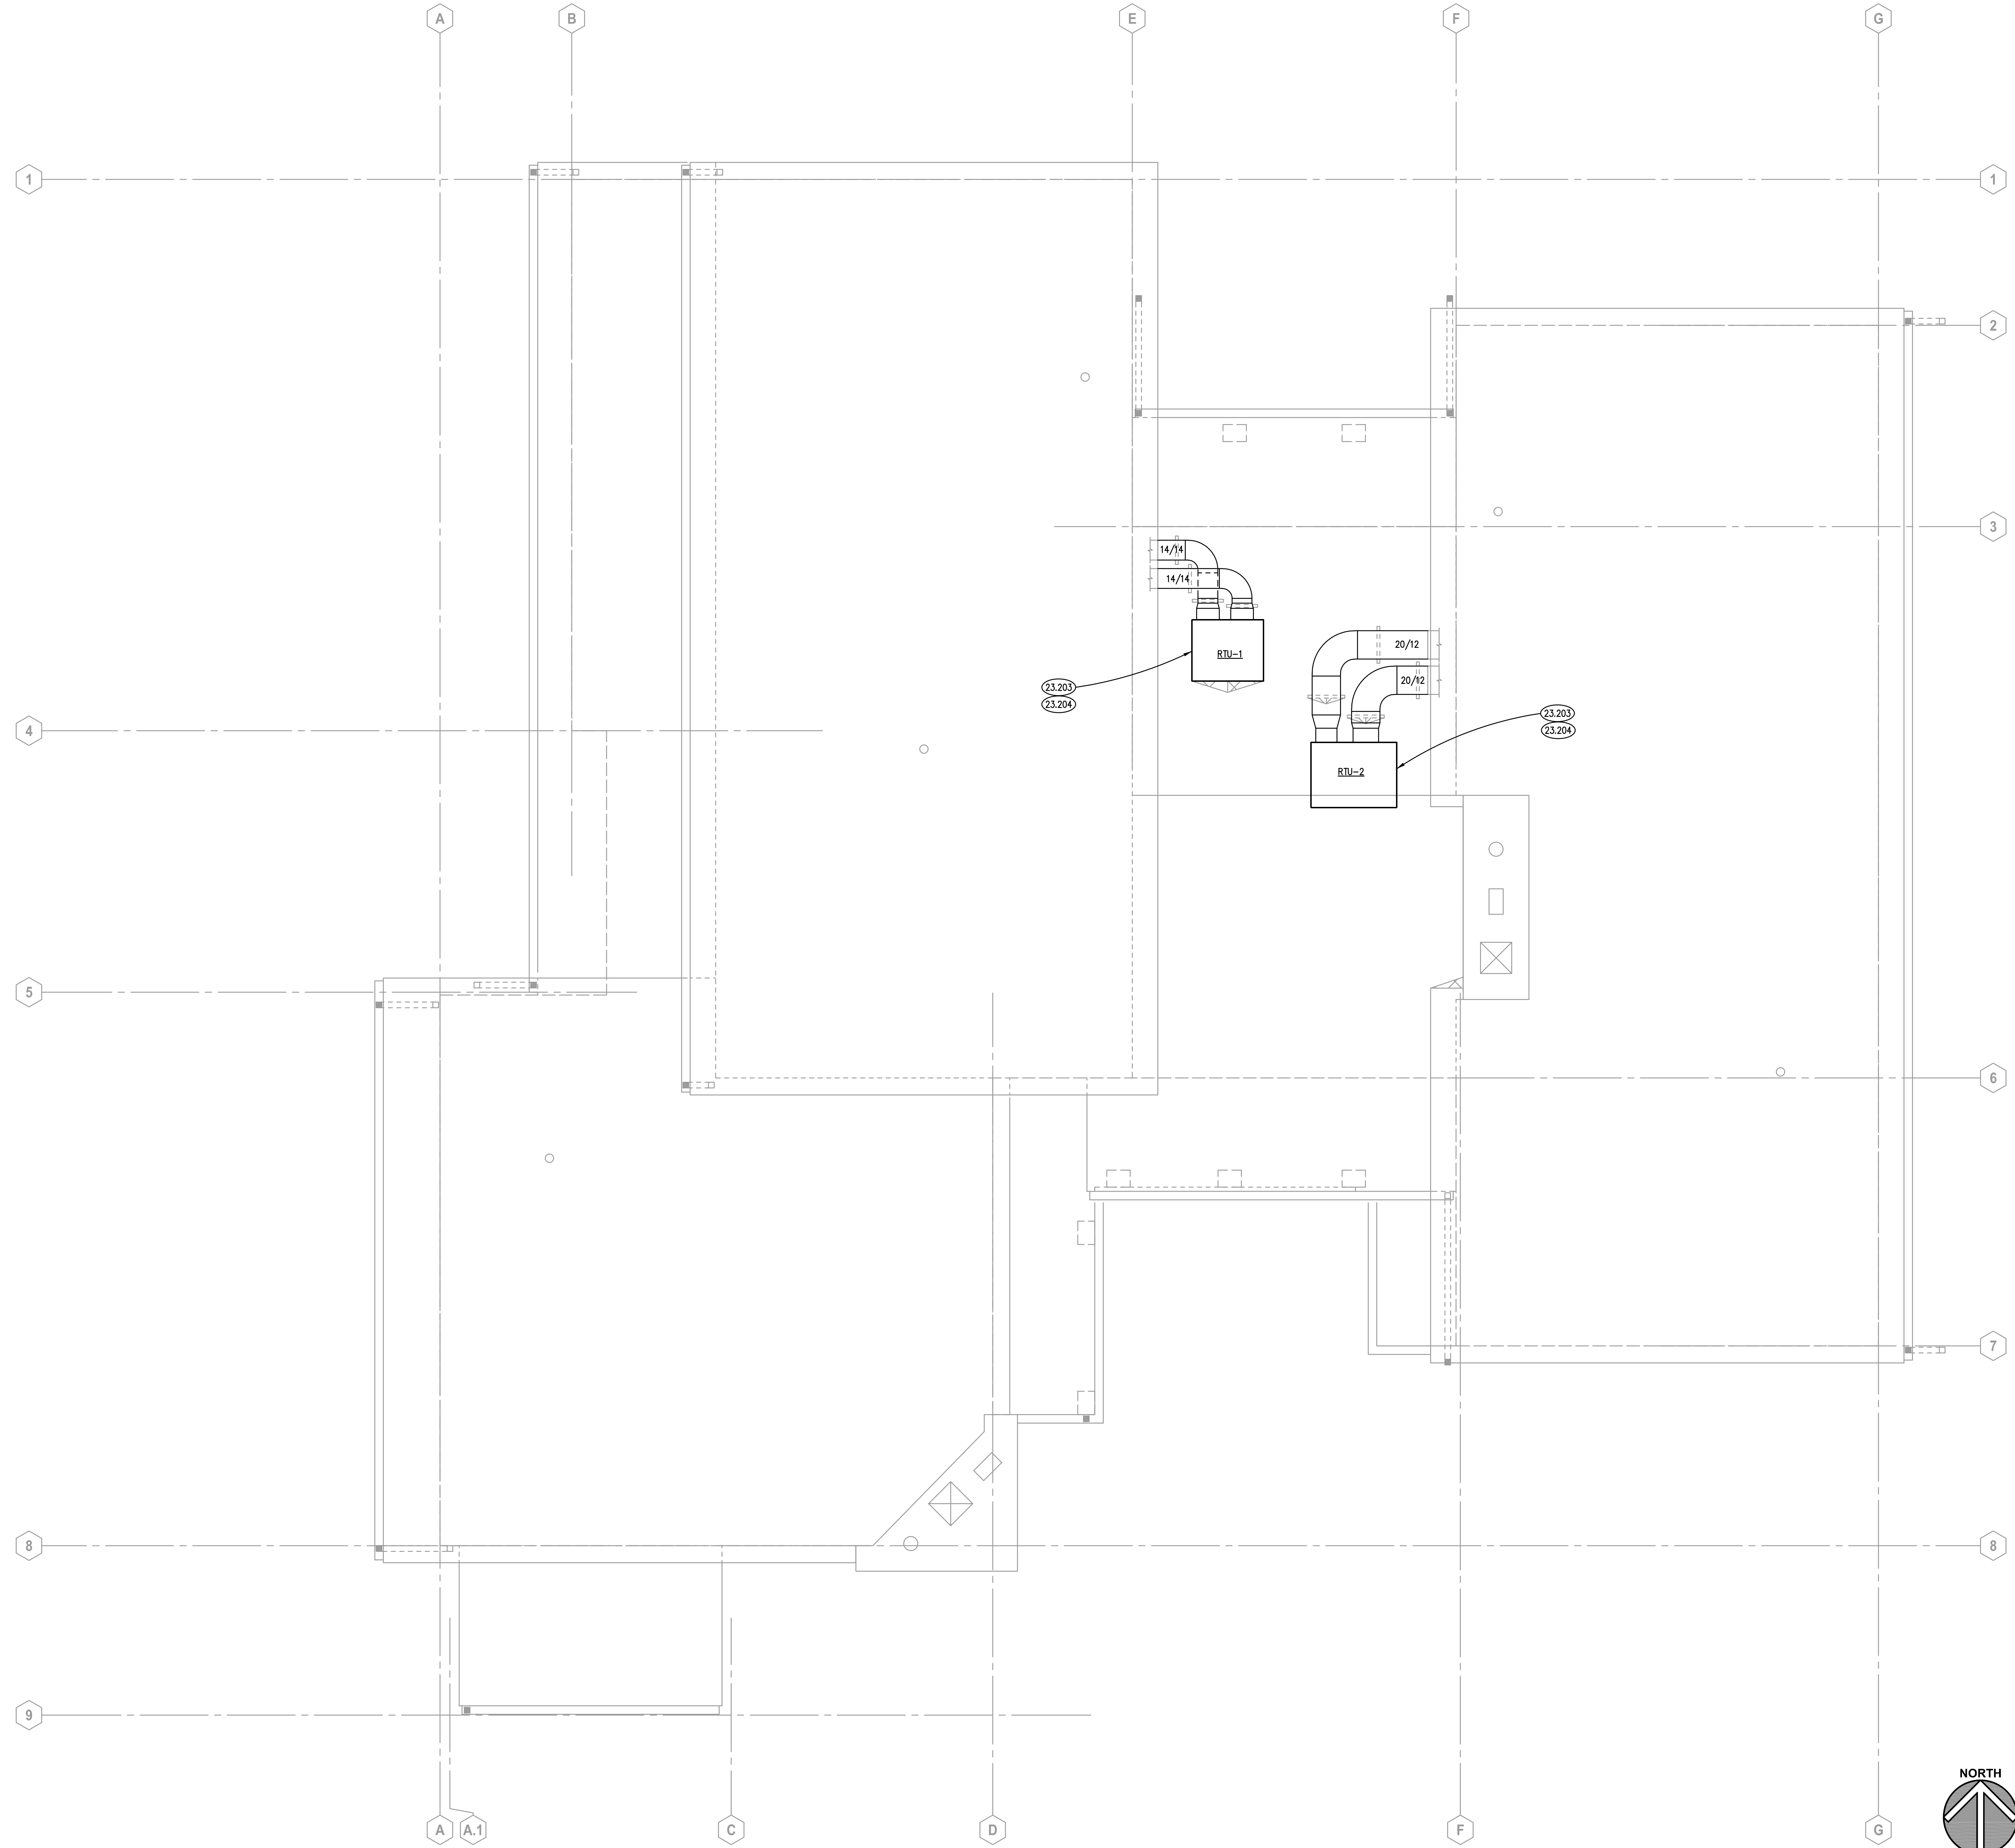
KEN PICKERILL HOUSE RENOVATIONS
KENDALL COUNTY FOREST PRESERVE DISTRICT
110 W. MADISON STREET
YORKVILLE, IL 60560

ISSUED	
01/10/22	BID DOCUMENTS

JOB NO.	19-428-1250
DRAWN	BWG
CHECKED	DDW
APPROVED	DDW

SHEET TITLE
FIRST FLOOR MECHANICAL PLAN

SHEET NUMBER
M310



KEYNOTES

KEYNOTES ARE TYPICALLY NOT DUPLICATED WITHIN A GIVEN DETAIL. AN UN-KEYNOTED ITEM IN A DETAIL IS THE SAME AS A KEYNOTED ITEM HAVING THE SAME APPEARANCE WITHIN THE SAME DETAIL.

- 23.203 PROVIDE ROOF TOP UNIT. PROVIDE CONNECTIONS TO EXISTING DUCTWORK. FIELD VERIFY BUILDING SUPPLY AND RETURN DUCT OPENINGS PRIOR TO MAKING THE CONNECTION.
- 23.204 FIELD VERIFY LOCATION OF EXISTING THERMOSTAT FOR ROOF TOP UNIT BEING REMOVED. REMOVE EXISTING THERMOSTAT AND PROVIDE NEW THERMOSTAT FOR NEW ROOF TOPS UNITS AT SAME LOCATION. REFER TO SPECIFICATIONS.

ROOFTOP UNIT SCHEDULE

MARK	RTU-1	RTU-2
MODEL	4TCY5036A1	4TCY5048A1
AIR FLOW RATE	1,200	1,600
COOLING	ENT AIR TEMP (db/wb °F)	77.0 / 64.0
	LVG AIR TEMP (db/wb °F)	55.0 / 55.0
	REFRIGERANT TYPE	R-410A
	ENT CONDENSER AIR TEMP (°F)	95
	SENSIBLE CAPACITY (MBH)	-
	NOMINAL TOTAL CAPACITY (MBH)	36.0
HEATING	EFFICIENCY (SEER)	15.0
	ENT AIR (°F)	60.0
	LVG AIR (°F)	112.6
	CAPACITY (kW)	20.0
	NO. OF STEPS	2
	SUPPLY FAN (HP)	1/2
EXTERNAL STATIC PRESSURE (IN WG)	0.8	
ELECTRICAL (V/PH/Hz)	240/1/60	
MCA	SEE NOTES	
REMARKS	1, 2, 3	

1. MODEL BASED ON TRANE.
2. HORIZONTAL RETURN AND DISCHARGE.
3. PROVIDE SINGLE POINT POWER, MCA UNIT = 23.8, MCA HEATER STG 1 = 104.0, MCA HEATER STG 2: 104.0.
4. PROVIDE SINGLE POINT POWER, MCA UNIT = 34.2, MCA HEATER STG 1 = 104.0, MCA HEATER STG 2: 104.0.

SEQUENCE OF OPERATION

RTU-1/RTU-2:
THE ROOF TOP UNIT SHALL BE CONTROLLED BY A PROGRAMMABLE ROOM THERMOSTAT. THE ROOF TOP UNIT SHALL BE IN HEATING OR COOLING MODE AS REQUIRED TO MAINTAIN THE ROOM SETPOINT. THERE SHALL BE A 5° DEADBAND BETWEEN HEATING AND COOLING MODES. AN OCCUPIED/UNOCCUPIED SCHEDULE SHALL BE SET IN THE THERMOSTAT. THERMOSTAT SHALL HAVE AN OVERRIDE FUNCTION TO CHANGE FROM UNOCCUPIED TO OCCUPIED MODE.

GENERAL NOTES

1. REFER TO DRAWING G100 FOR PROJECT GENERAL NOTES.
2. ALL PIPING, DUCTWORK AND RACEWAYS ARE SHOWN DIAGMATICALLY AND DO NOT SHOW ALL REQUIRED FITTINGS, OFFSETS, DROPS AND RISES. THE CONTRACTOR IS RESPONSIBLE TO PROVIDE ALL MATERIAL AND LABOR FOR A COMPLETE AND WORKING SYSTEM. COORDINATE WITH OTHER TRADES FOR SPACE AVAILABLE AND RELATIVE LOCATIONS OF EQUIPMENT, PIPING, DUCTWORK, ETC.
3. EXISTING PIPING, DUCTWORK AND RACEWAYS INDICATED ON THESE PLANS SHALL BE FIELD VERIFIED FOR EXACT LOCATIONS, QUANTITY AND SIZES.
4. ALL TAPES AND MASTICS USED TO SEAL DUCTWORK LISTED AND LABELED IN ACCORDANCE WITH UL 181A SHALL BE MARKED ACCORDINGLY. ALL TAPES AND MASTICS USED TO SEAL FLEXIBLE DUCTS AND AIR CONNECTORS SHALL COMPLY WITH UL 181B AND MARKED ACCORDINGLY.
5. THERMOSTATIC CONTROLS OF EQUIPMENT SHALL HAVE A 5° F DEADBAND.
6. GENERALLY, SMALL DIAMETER PIPE RUNS FROM DRIPS, CONDENSATE PANS AND OTHER SERVICES ARE NOT SHOWN BUT MUST BE PROVIDED. CONDENSATE DRAINS SHALL BE CONFIGURED WITH FITTINGS AND/OR UNIONS TO PERMIT CLEARING OF BLOCKAGES AND PERFORMANCE OF MAINTENANCE WITHOUT CUTTING OF THE LINES.
7. SPACE ALLOCATION, COORDINATION WITH ELECTRICAL, ARCHITECTURAL & OTHER MECHANICAL COMPONENTS HAVE BEEN MADE WITH RESPECT TO ALL EQUIPMENT SCHEDULED ON THESE DRAWINGS AND IN THE SPECIFICATIONS OF THE FIRST NAMED MANUFACTURER ONLY. OTHER MANUFACTURERS ARE ACCEPTABLE PROVIDED THEY MEET PERFORMANCE REQUIREMENTS AND AFOREMENTIONED COORDINATION.
8. DO NOT CUT THROUGH THE MASONRY BOND BEAMS OR OTHER STRUCTURAL ELEMENT WHEN INSTALLING OPENINGS REQUIRED FOR ALL DUCTWORK, PIPING, CONDUITS OR OTHER WORK. CONTRACTOR CUTTING THROUGH OR OTHERWISE DAMAGING THESE ELEMENTS WILL BE RESPONSIBLE FOR ALL ASSOCIATED ENGINEERING FEES AND SUBSEQUENT RETRO-FIT/REINFORCING DEEMED NECESSARY TO REINSTATE THE CONTINUITY OF THE DISRUPTED ELEMENTS.
9. ALL ROOFTOP EQUIPMENT (ARCHITECTURAL, MECHANICAL, ELECTRICAL, ETC.) AND THEIR CORRESPONDING CURBS TO BE ATTACHED TO THE STRUCTURAL FRAMING AS REQUIRED TO RESIST WIND AND SEISMIC FORCES. ANCHORAGE TO METAL DECKING IS NOT ACCEPTABLE. CONTRACTOR/MANUFACTURER TO CONSULT AN INDEPENDENT STRUCTURAL ENGINEER TO REVIEW, DESIGN AND DETAIL THE REQUIRED CONNECTIONS.

MECHANICAL ROOF PLAN
SCALE: 1/4" = 1'-0" 1

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01/10/22	BID DOCUMENTS

JOB NO.	19-428-1250
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APPROVED	DDW

SHEET TITLE
MECHANICAL ROOF PLAN



SHEET NUMBER

M330

KEYNOTES

KEYNOTES ARE TYPICALLY NOT DUPLICATED WITHIN A GIVEN DETAIL. AN UN-KEYNOTED ITEM IN A DETAIL IS THE SAME AS A KEYNOTED ITEM HAVING THE SAME APPEARANCE WITHIN THE SAME DETAIL.

- 22.101 REMOVE HOT WATER HEATER AND ASSOCIATED PIPING AND SPECIALTIES. REMOVE HOT AND COLD WATER BACK AS SHOWN.
- 22.103 REMOVE COLD WATER PIPING BACK AS SHOWN. PROVIDE TEMPORARY CAP FOR NEW CONNECTION.
- 22.107 REMOVE HOT WATER HEATER. RECONFIGURE HOT AND COLD WATER PIPING AS REQUIRED FOR INSTALLATION OF NEW WATER HEATER AND PROVIDE TEMPORARY CAPS FOR NEW CONNECTION FIELD VERIFY EXACT ROUTING OF EXISTING PIPING.
- 22.108 FIELD VERIFY EXISTING HOT AND COLD WATER ROUTING IN CRAWL SPACE. REMOVE DAMAGED HOT AND COLD WATER PIPING FOR SINKS BEING REPLACED BACK AS REQUIRED FOR A COMPLETE AND OPERATIONAL SYSTEM. PROVIDE TEMPORARY CAP FOR NEW CONNECTION.

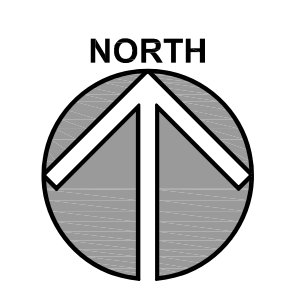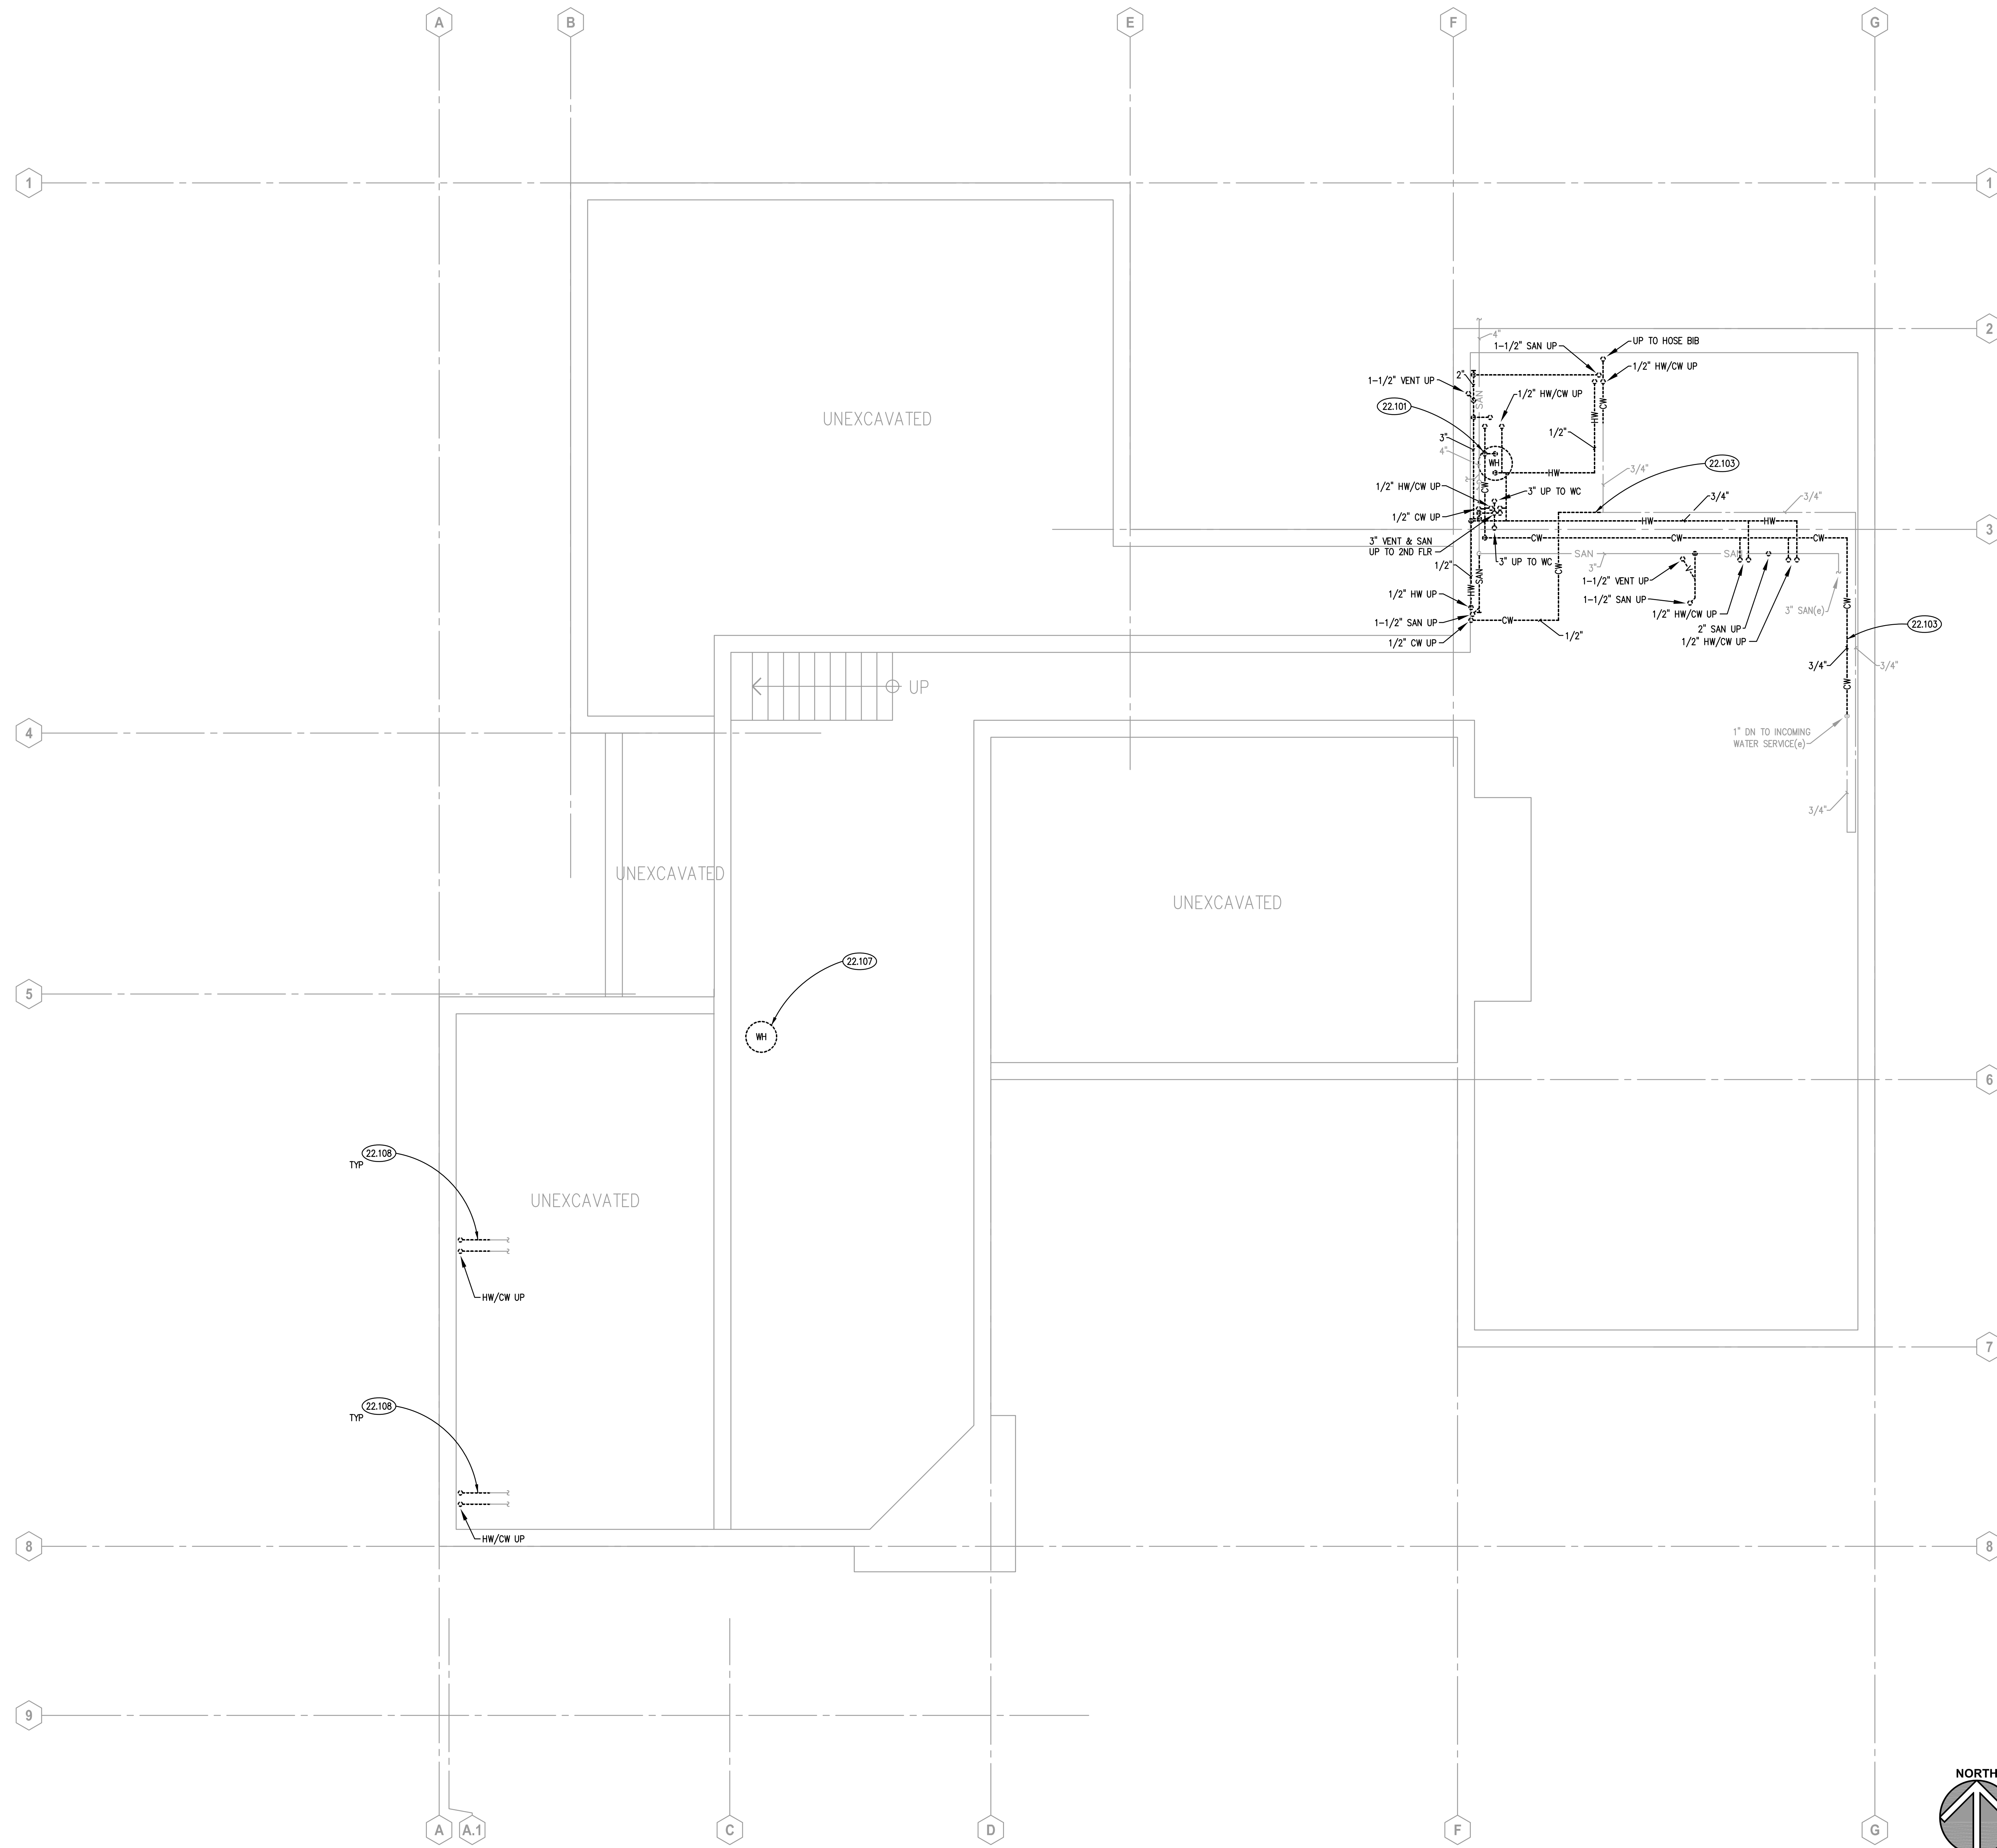

BASEMENT PLUMBING DEMOLITION PLAN
SCALE: 1/4" = 1'-0" **1**

GENERAL NOTES

1. REFER TO DRAWING G100 FOR PROJECT GENERAL NOTES.
2. ALL SANITARY, WASTE AND STORM PIPES UP TO AND INCLUDING 3 INCHES SHALL SLOPE AT 1/4 INCH PER FOOT, 4 INCHES AND LARGER SHALL SLOPE AT 1/8 INCH PER FOOT, UNLESS OTHERWISE NOTED.
3. ALL PIPING IS SHOWN DIAGRAMMATICALLY AND DOES NOT SHOW ALL OFFSETS, DROPS AND RISES. THE CONTRACTOR IS RESPONSIBLE TO PROVIDE ALL MATERIAL AND LABOR FOR A COMPLETE AND WORKING SYSTEM.
4. OBTAIN AND PAY ALL COSTS FOR PERMITS, LICENSES, CERTIFICATE FILING AND INSPECTIONS BY AUTHORITIES HAVING JURISDICTION.
5. EXISTING PIPING INDICATED ON THESE PLANS SHALL BE FIELD VERIFIED FOR EXACT LOCATIONS, QUANTITY AND PIPE SIZES.
6. DO NOT CUT THROUGH STRUCTURAL ELEMENTS WHEN INSTALLING OPENINGS REQUIRED FOR ALL PIPING, CONDUITS OR OTHER WORK. CONTRACTOR CUTTING THROUGH OR OTHERWISE DAMAGING THESE ELEMENTS WILL BE RESPONSIBLE FOR ALL ASSOCIATED ENGINEERING FEES AND SUBSEQUENT RETRO-FIT/REINFORCING DEEMED NECESSARY TO REINSTATE THE CONTINUITY OF THE DISRUPTED ELEMENTS.
7. SPACE ALLOCATION, COORDINATION WITH ELECTRICAL, ARCHITECTURAL & OTHER PLUMBING COMPONENTS HAVE BEEN MADE WITH RESPECT TO ALL EQUIPMENT SCHEDULED ON THESE DRAWINGS AND IN THE SPECIFICATIONS OF THE FIRST NAMED MANUFACTURER ONLY. OTHER MANUFACTURERS ARE ACCEPTABLE PROVIDED THEY MEET PERFORMANCE REQUIREMENTS AND AFOREMENTIONED COORDINATION.
8. COORDINATE ROUGH-INS FOR AND INSTALLATION OF PLUMBING FIXTURES WITH ACCESSIBILITY AND MOUNTING INFORMATION CONTAINED ON ARCHITECTURAL DRAWINGS.
9. COORDINATE LOCATIONS OF ROUGH-INS FOR SINKS WITH CASEWORK ELEVATIONS CONTAINED ON ARCHITECTURAL DRAWINGS.
10. DRAINAGE AND VENT SYSTEM SHALL BE PRESSURE TESTED WITH WATER OR AIR.

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BID DOCUMENTS	

JOB NO.	19-428-1250
DRAWN	BWG
CHECKED	DDW
APPROVED	DDW

SHEET TITLE
BASEMENT PLUMBING DEMOLITION PLAN

SHEET NUMBER
P200

KEYNOTES

KEYNOTES ARE TYPICALLY NOT DUPLICATED WITHIN A GIVEN DETAIL. AN UN-KEYNOTED ITEM IN A DETAIL IS THE SAME AS A KEYNOTED ITEM HAVING THE SAME APPEARANCE WITHIN THE SAME DETAIL.

- 22.100 REMOVE PLUMBING FIXTURE. REMOVE HOT AND COLD WATER PIPING BACK TO WITHIN 24 INCHES OF NEXT ACTIVE BRANCH. REMOVE WASTE AND VENT PIPING BACK TO NEAREST MAIN AND PROVIDE CAP. REFER TO BASEMENT PLUMBING DEMOLITION PLAN.
- 22.102 REMOVE HOT, COLD, WASTE AND VENT PIPING BACK TO CEILING. PIPING TO BE REROUTED, REFER TO NEW WORK PLANS.
- 22.104 REMOVE PLUMBING FIXTURE. REMOVE HOT AND COLD WATER PIPING BACK TO WITHIN 24 INCHES OF NEXT ACTIVE BRANCH AND PROVIDE PERMANENT CAP ON PIPE. REMOVE WASTE AND VENT PIPING BACK TO NEXT ACTIVE BRANCH AND CAP.
- 22.105 REMOVE SINK. EXISTING WATER PIPING HAS BURST FROM FREEZING. REMOVE HOT WATER AND COLD WATER PIPING BACK APPROXIMATELY 10 FEET IN CRAWL SPACE BELOW TO REMOVE SECTIONS OF PIPE THAT HAVE BURST. PROVIDE TEMPORARY CAP FOR NEW CONNECTION. FIELD VERIFY EXACT LOCATION OF PIPING AND AMOUNT OF PIPING TO BE REMOVED TO ENSURE A COMPLETE AND OPERATIONAL SYSTEM.
- 22.106 PROVIDE TEMPORARY CAP ON WASTE AND VENT PIPING FOR NEW CONNECTION.

ROOM SCHEDULE

RM. NO.	ROOM NAME	RM. NO.	ROOM NAME
105	EXISTING BEDROOM		
106	EXISTING BATHROOM		
107	EXISTING LIVING ROOM		
108	EXISTING STORAGE		
109	EXISTING STORAGE		
110	EXISTING CORRIDOR		
111	EXISTING BATHROOM		
112	EXISTING JANITOR'S CLOSET		
113	EXISTING DINING ROOM		
114	EXISTING KEEPING ROOM		
115	EXISTING PANTRY		
116	EXISTING KITCHENETTE		
117	EXISTING GREEN HOUSE		
118	EXISTING FOYER		
119	EXISTING GARAGE		
120	EXISTING STORAGE		

GENERAL NOTES

1. REFER TO DRAWING G100 FOR PROJECT GENERAL NOTES.
2. ALL SANITARY, WASTE AND STORM PIPES UP TO AND INCLUDING 3 INCHES SHALL SLOPE AT 1/4 INCH PER FOOT, 4 INCHES AND LARGER SHALL SLOPE AT 1/8 INCH PER FOOT, UNLESS OTHERWISE NOTED.
3. ALL PIPING IS SHOWN DIAGMATICALLY AND DOES NOT SHOW ALL OFFSETS, DROPS AND RISES. THE CONTRACTOR IS RESPONSIBLE TO PROVIDE ALL MATERIAL AND LABOR FOR A COMPLETE AND WORKING SYSTEM.
4. OBTAIN AND PAY ALL COSTS FOR PERMITS, LICENSES, CERTIFICATE FILING AND INSPECTIONS BY AUTHORITIES HAVING JURISDICTION.
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7. SPACE ALLOCATION, COORDINATION WITH ELECTRICAL, ARCHITECTURAL & OTHER PLUMBING COMPONENTS HAVE BEEN MADE WITH RESPECT TO ALL EQUIPMENT SCHEDULED ON THESE DRAWINGS AND IN THE SPECIFICATIONS OF THE FIRST NAMED MANUFACTURER ONLY. OTHER MANUFACTURERS ARE ACCEPTABLE PROVIDED THEY MEET PERFORMANCE REQUIREMENTS AND AFOREMENTIONED COORDINATION.
8. COORDINATE ROUGH-INS FOR AND INSTALLATION OF PLUMBING FIXTURES WITH ACCESSIBILITY AND MOUNTING INFORMATION CONTAINED ON ARCHITECTURAL DRAWINGS.
9. COORDINATE LOCATIONS OF ROUGH-INS FOR SINKS WITH CASEWORK ELEVATIONS CONTAINED ON ARCHITECTURAL DRAWINGS.
10. DRAINAGE AND VENT SYSTEM SHALL BE PRESSURE TESTED WITH WATER OR AIR.

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01/09/22	BID DOCUMENTS
JOB NO.	19-428-1250
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APPROVED	DDW
SHEET TITLE	
FIRST FLOOR PLUMBING DEMOLITION PLAN	
SHEET NUMBER	



FIRST FLOOR DEMOLITION PLAN
SCALE: 1/4" = 1'-0"


NOTE: SCALES DEPICTED ON THIS DRAWING ARE NOT CORRECT UNLESS PLOTTED SHEET SIZE IS 30 X 42 INCHES.

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KEYNOTES

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- 22.202 PROVIDE RECONNECTION TO EXISTING PIPING IN CRAWL SPACE. INSULATE ALL PIPING AS SPECIFIED.
- 22.204 PROVIDE NEW ELECTRIC WATER HEATER. PROVIDE ALL MATERIALS AND LABOR TO RECONNECT TO EXISTING HOT AND COLD WATER PIPING.



BASEMENT PLUMBING PLAN ①
SCALE: 1/4" = 1'-0"

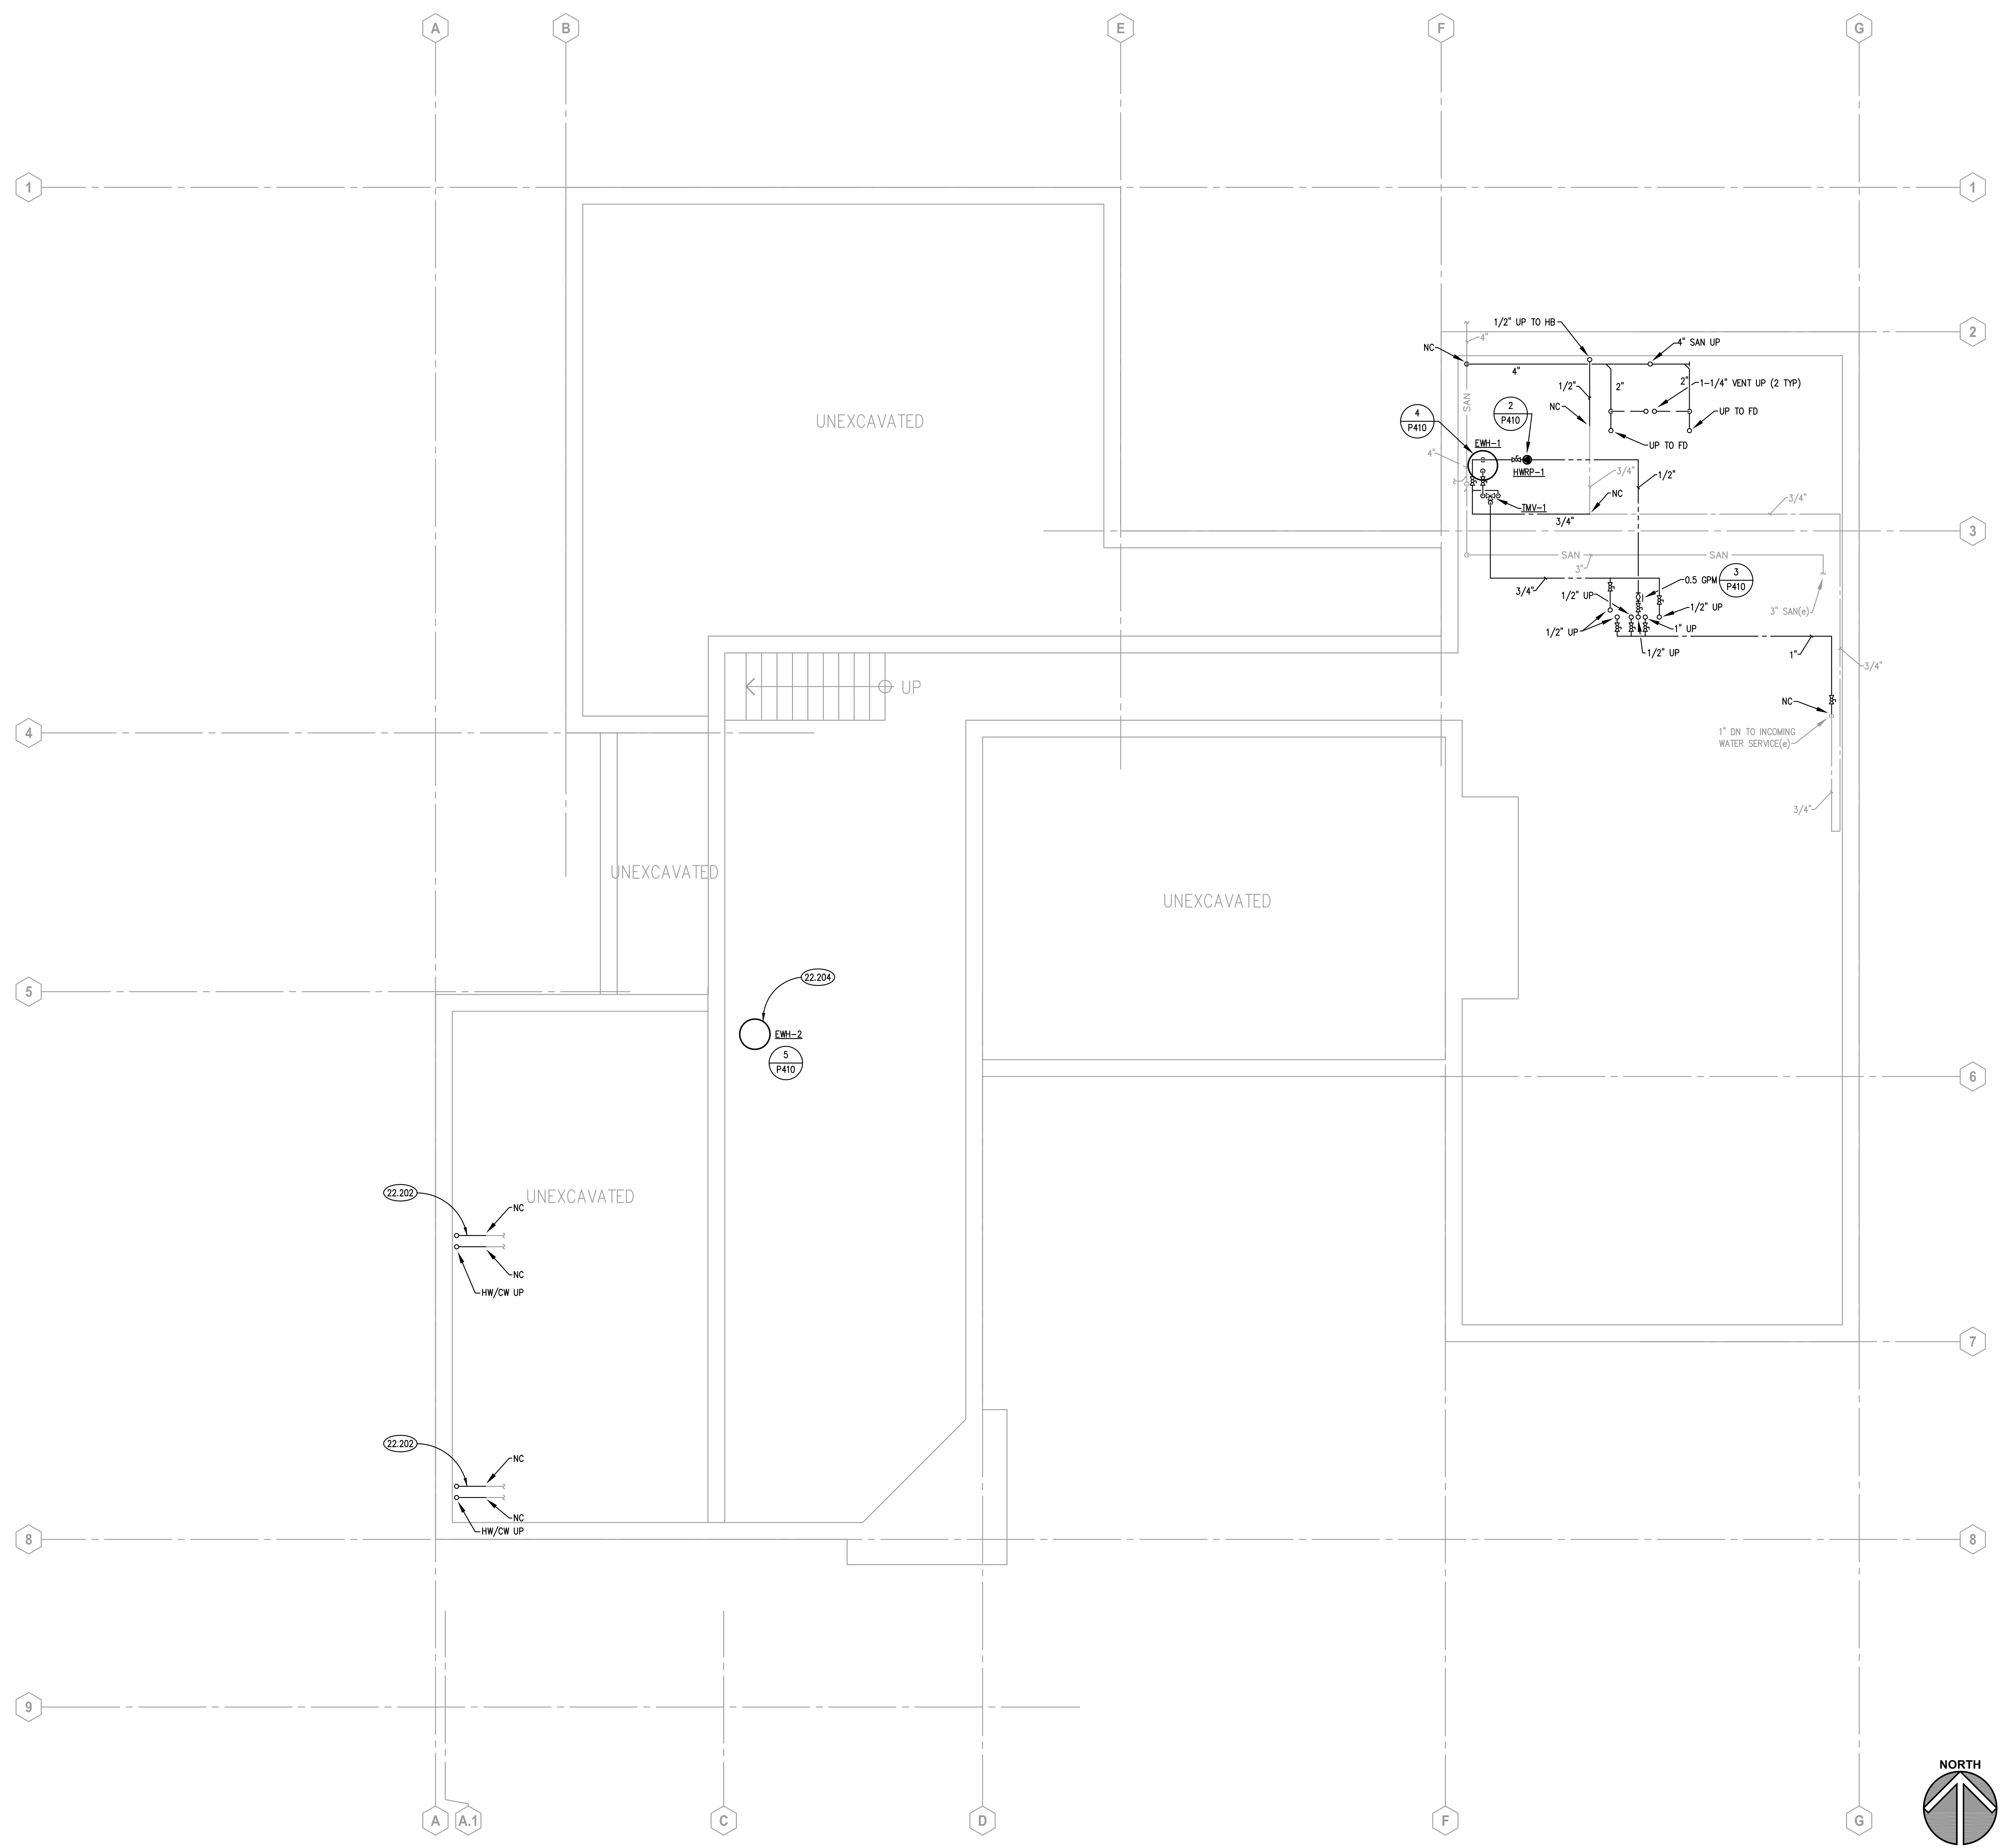GENERAL NOTES

- REFER TO DRAWING G100 FOR PROJECT GENERAL NOTES.
- ALL SANITARY, WASTE AND STORM PIPES UP TO AND INCLUDING 3 INCHES SHALL SLOPE AT 1/4 INCH PER FOOT, 4 INCHES AND LARGER SHALL SLOPE AT 1/8 INCH PER FOOT, UNLESS OTHERWISE NOTED.
- ALL PIPING IS SHOWN DIAGRAMMATICALLY AND DOES NOT SHOW ALL OFFSETS, DROPS AND RISES. THE CONTRACTOR IS RESPONSIBLE TO PROVIDE ALL MATERIAL AND LABOR FOR A COMPLETE AND WORKING SYSTEM.
- OBTAIN AND PAY ALL COSTS FOR PERMITS, LICENSES, CERTIFICATE FILING AND INSPECTIONS BY AUTHORITIES HAVING JURISDICTION.
- EXISTING PIPING INDICATED ON THESE PLANS SHALL BE FIELD VERIFIED FOR EXACT LOCATIONS, QUANTITY AND PIPE SIZES.
- DO NOT CUT THROUGH STRUCTURAL ELEMENTS WHEN INSTALLING OPENINGS REQUIRED FOR ALL PIPING, CONDUITS OR OTHER WORK. CONTRACTOR CUTTING THROUGH OR OTHERWISE DAMAGING THESE ELEMENTS WILL BE RESPONSIBLE FOR ALL ASSOCIATED ENGINEERING FEES AND SUBSEQUENT RETRO-FIT/REINFORCING DEEMED NECESSARY TO REINSTATE THE CONTINUITY OF THE DISRUPTED ELEMENTS.
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- COORDINATE ROUGH-INS FOR AND INSTALLATION OF PLUMBING FIXTURES WITH ACCESSIBILITY AND MOUNTING INFORMATION CONTAINED ON ARCHITECTURAL DRAWINGS.
- COORDINATE LOCATIONS OF ROUGH-INS FOR SINKS WITH CASEWORK ELEVATIONS CONTAINED ON ARCHITECTURAL DRAWINGS.
- DRAINAGE AND VENT SYSTEM SHALL BE PRESSURE TESTED WITH WATER OR AIR.

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SHEET TITLE	

BASEMENT PLUMBING PLAN	
SHEET NUMBER	

P300

NOTE: SCALES DEPICTED ON THIS DRAWING ARE NOT CORRECT UNLESS PLOTTED SHEET SIZE IS 30 X 42 INCHES.


KEYNOTES

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- 22.200 PROVIDE NEW WALL HYDRANT AT LOCATION OF REMOVED HOSE BIB. PROVIDE ALL MATERIALS AND LABOR TO MODIFY PIPING TO MAKE THE CONNECTION.
- 22.201 PROVIDE NEW CONNECTION TO EXISTING HOT WATER, COLD WATER, VENT AND WASTE PIPING FROM SECOND FLOOR. FIELD VERIFY EXACT LOCATION AND CONFIGURATION. PROVIDE ALL MATERIAL AND LABOR TO MODIFY PIPING AS REQUIRED TO MAKE THE CONNECTION.
- 22.203 PROVIDE ALL MATERIALS AND LABOR TO RECONNECT NEW SINK TO EXISTING WASTE AND VENT LINES.
- 22.205 PROVIDE ANY MODIFICATIONS TO EXISTING WASTE AND VENT PIPE AS REQUIRED TO CHANGE FROM TWO BOWL NON-ADA TO SINGLE BOWL ADA COMPLIANT SINK. RECONNECT TO EXISTING WASTE AND VENT LINES.

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KENDALL COUNTY FOREST PRESERVE DISTRICT
110 W. MADISON STREET
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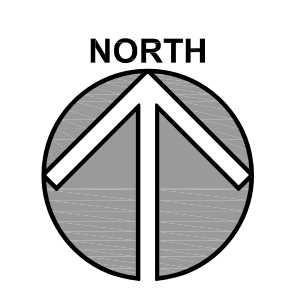


ROOM SCHEDULE

RM. NO.	ROOM NAME	RM. NO.	ROOM NAME
105	NOT USED	120	EXISTING STORAGE
106	NOT USED		
107	EXISTING LIVING ROOM		
108	EXISTING STORAGE		
109	EXISTING STORAGE		
110	EXISTING CORRIDOR	203.1	EXISTING CLOSET
111	EXISTING BATHROOM		
112	EXISTING JANITOR'S CLOSET		
113	EXISTING DINING ROOM		
114	EXISTING KEEPING ROOM		
115	EXISTING PANTRY		
116	EXISTING KITCHEN		
117	EXISTING GREEN HOUSE		
118	EXISTING FOYER		
119	EXISTING GARAGE		

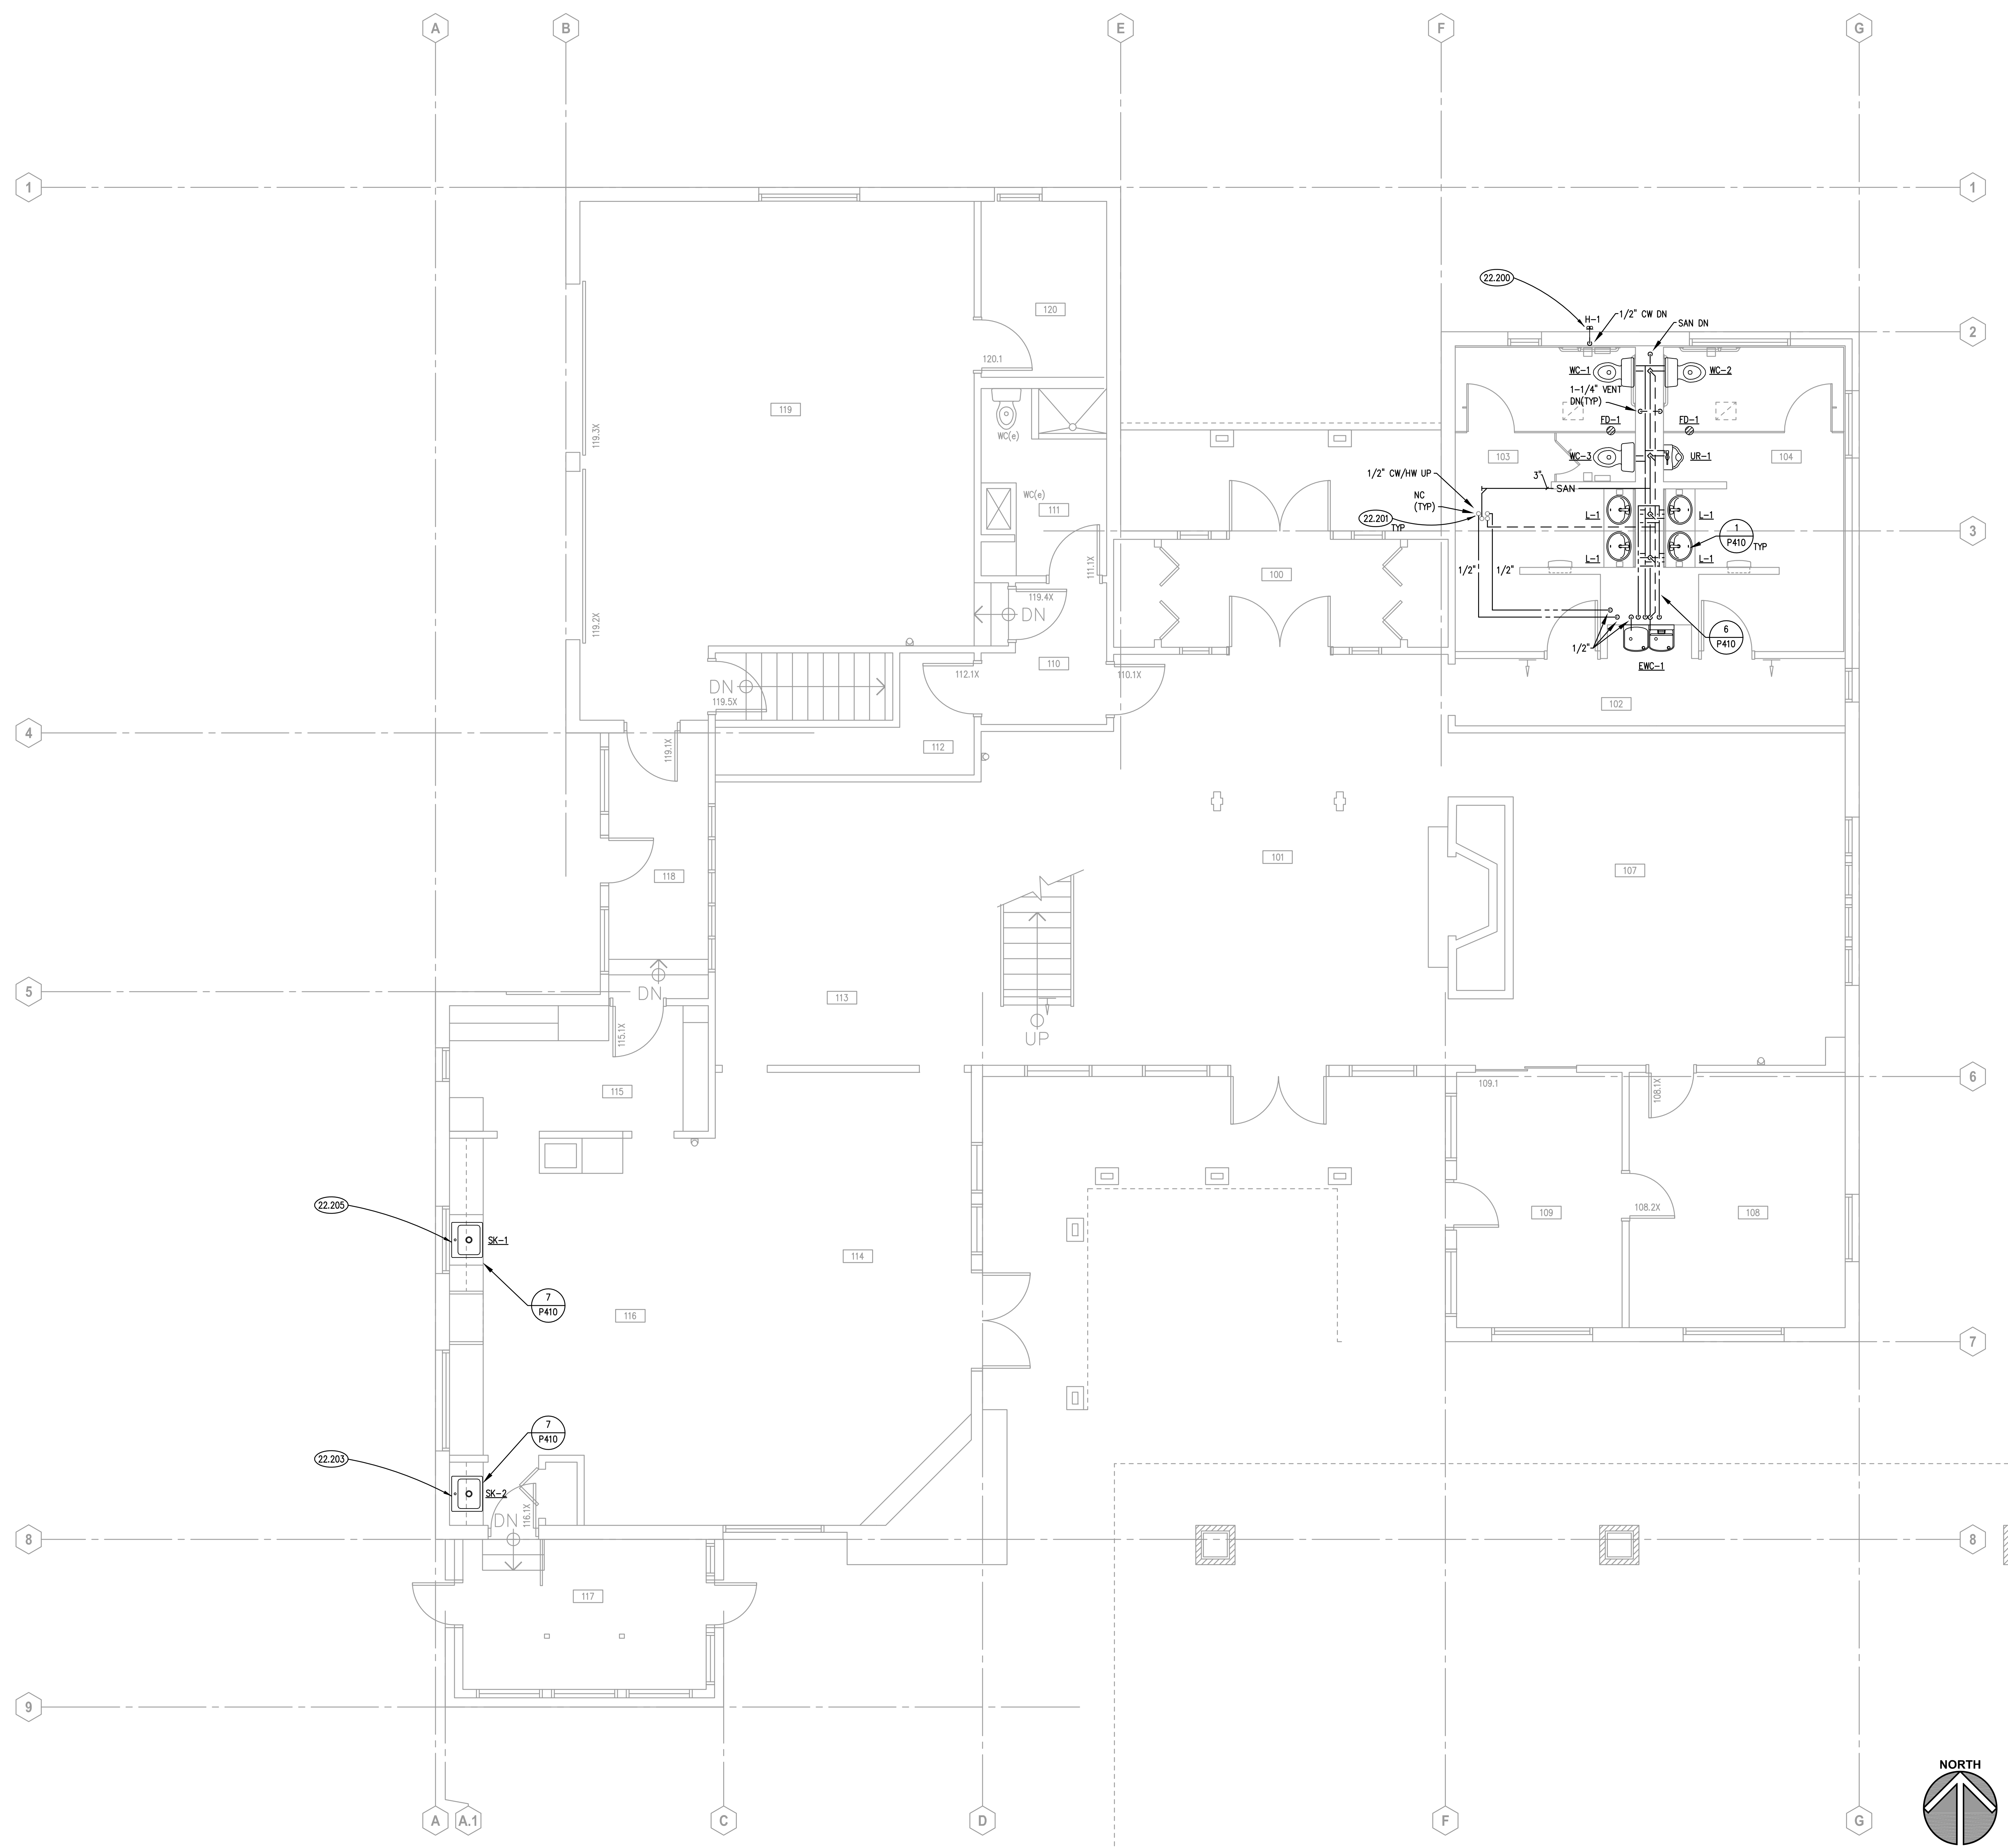GENERAL NOTES

1. REFER TO DRAWING G100 FOR PROJECT GENERAL NOTES.
2. ALL SANITARY, WASTE AND STORM PIPES UP TO AND INCLUDING 3 INCHES SHALL SLOPE AT 1/4 INCH PER FOOT, 4 INCHES AND LARGER SHALL SLOPE AT 1/8 INCH PER FOOT, UNLESS OTHERWISE NOTED.
3. ALL PIPING IS SHOWN DIAGRAMMATICALLY AND DOES NOT SHOW ALL OFFSETS, DROPS AND RISERS. THE CONTRACTOR IS RESPONSIBLE TO PROVIDE ALL MATERIAL AND LABOR FOR A COMPLETE AND WORKING SYSTEM.
4. OBTAIN AND PAY ALL COSTS FOR PERMITS, LICENSES, CERTIFICATE FILING AND INSPECTIONS BY AUTHORITIES HAVING JURISDICTION.
5. EXISTING PIPING INDICATED ON THESE PLANS SHALL BE FIELD VERIFIED FOR EXACT LOCATIONS, QUANTITY AND PIPE SIZES.
6. DO NOT CUT THROUGH STRUCTURAL ELEMENTS WHEN INSTALLING OPENINGS REQUIRED FOR ALL PIPING, CONDUTS OR OTHER WORK. CONTRACTOR CUTTING THROUGH OR OTHERWISE DAMAGING THESE ELEMENTS WILL BE RESPONSIBLE FOR ALL ASSOCIATED ENGINEERING FEES AND SUBSEQUENT RETRO-FIT/REINFORCING DEEMED NECESSARY TO REINSTATE THE CONTINUITY OF THE DISRUPTED ELEMENTS.
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8. COORDINATE ROUGH-INS FOR AND INSTALLATION OF PLUMBING FIXTURES WITH ACCESSIBILITY AND MOUNTING INFORMATION CONTAINED ON ARCHITECTURAL DRAWINGS.
9. COORDINATE LOCATIONS OF ROUGH-INS FOR SINKS WITH CASEWORK ELEVATIONS CONTAINED ON ARCHITECTURAL DRAWINGS.
10. DRAINAGE AND VENT SYSTEM SHALL BE PRESSURE TESTED WITH WATER OR AIR.




FIRST FLOOR PLUMBING PLAN
SCALE: 1/4" = 1'-0"


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DESCRIPTION	

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FIRST FLOOR PLUMBING PLAN	
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P310

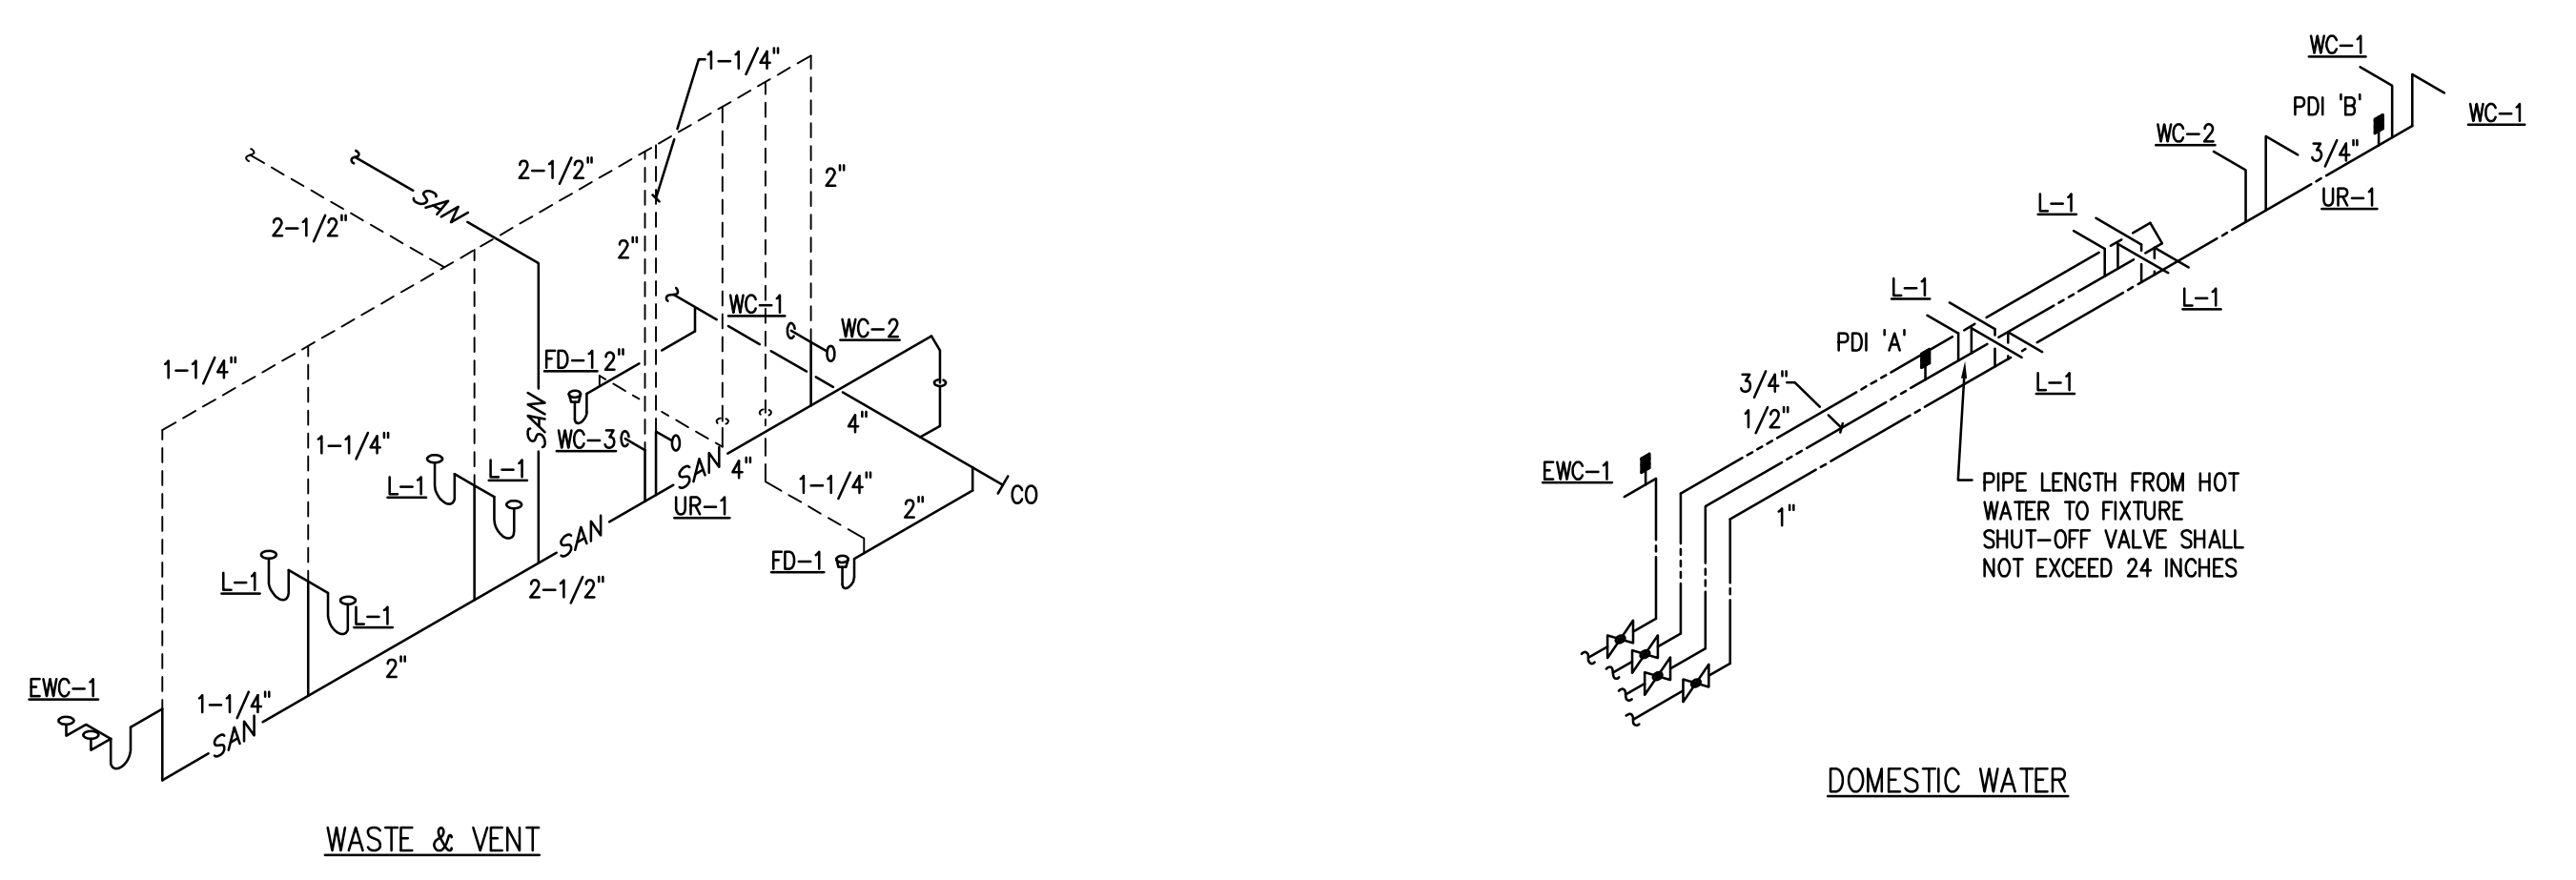

RISER DIAGRAM
SCALE: NTS **6**

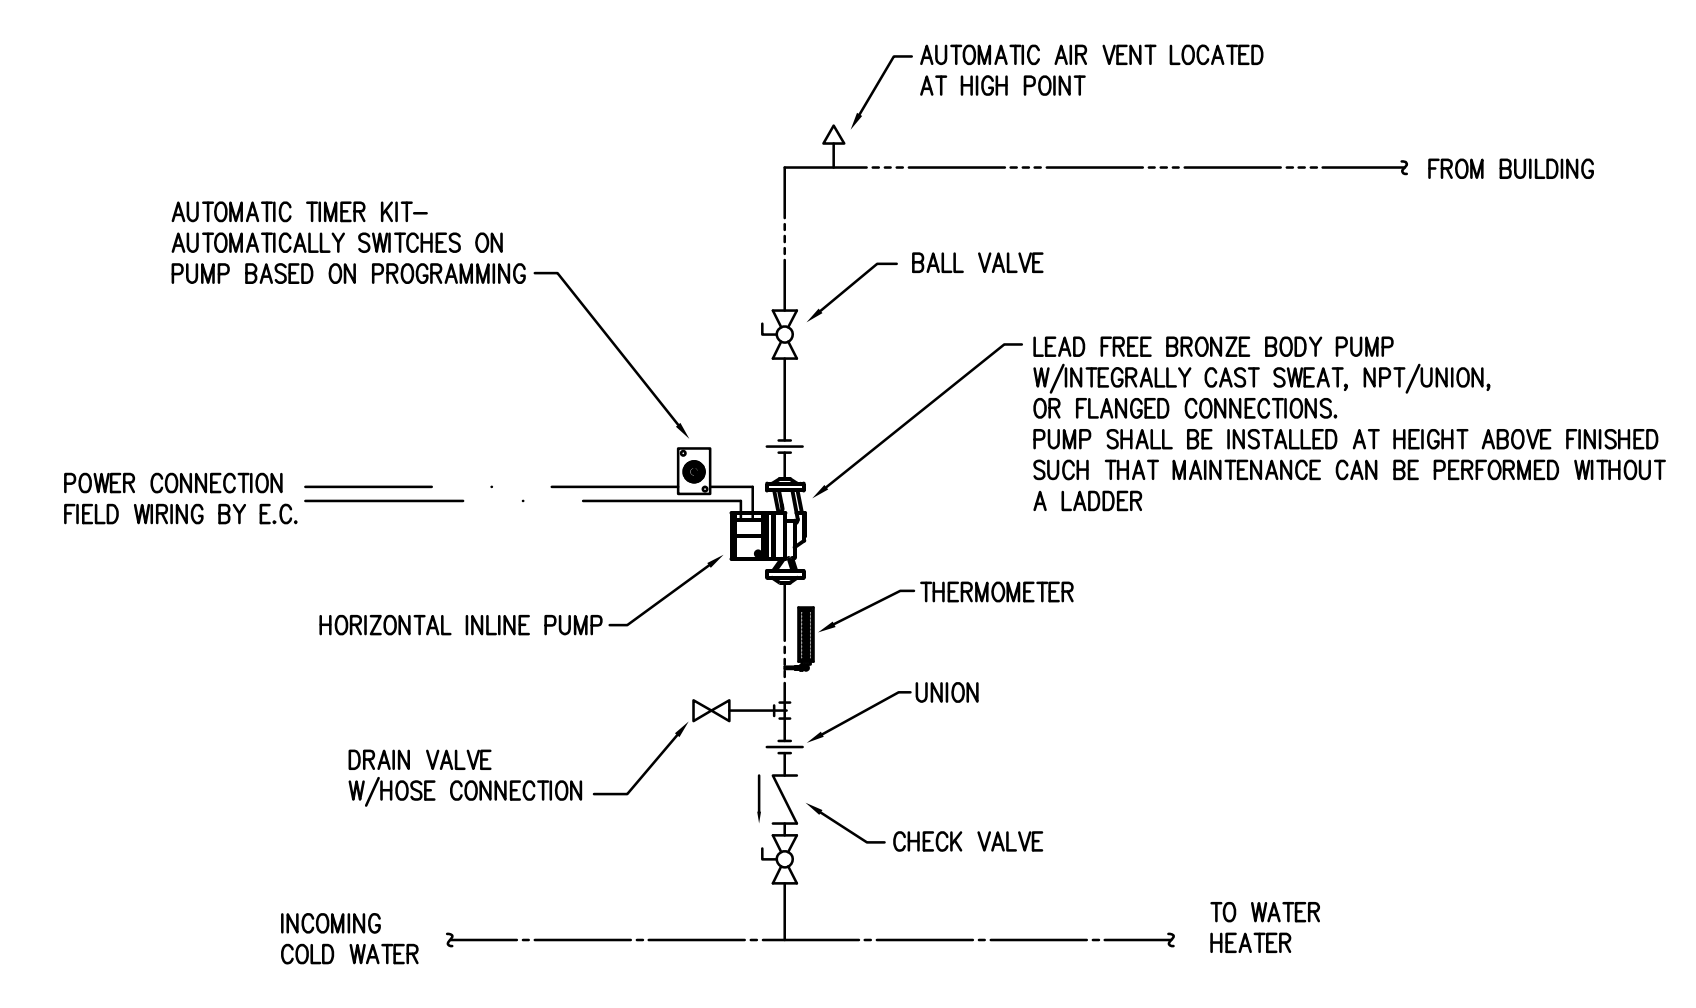

HOT WATER RECIRCULATION PUMP DETAIL
SCALE: NTS **2**

PLUMBING FIXTURE SCHEDULE

TAG	DESCRIPTION	COLD	HOT	WASTE	VENT	REMARKS
WC-1	WATER CLOSET-FLUSH TANK	1/2"	-	4"	2"	ADAAG COMPLIANT/RIGHT HAND TRIP LEVER
WC-2	WATER CLOSET-FLUSH TANK	1/2"	-	4"	2"	ADAAG COMPLIANT/LEFT HAND TRIP LEVER
WC-3	WATER CLOSET-FLUSH TANK	1/2"	-	4"	2"	
UR-1	URINAL-FLUSH VALVE	3/4"	-	2"	1-1/2"	ADAAG COMPLIANT
L-1	LAVATORY BOWL - DIV 12	1/2"	1/2"	1-1/2"	1-1/4"	ADAAG COMPLIANT
EW-1	ELECTRIC WATER COOLER	1/2"	-	1-1/4"	1-1/4"	ADAAG COMPLIANT
SK-1	BOWL - DIV 12	1/2"	1/2"	1-1/2"	1-1/2"	ADAAG COMPLIANT
SK-2	BOWL - DIV 12	1/2"	1/2"	1-1/2"	1-1/2"	

1. ALL PLUMBING MATERIALS AND INSTALLATIONS SHALL BE IN STRICT ACCORDANCE WITH ALL STATE AND LOCAL PLUMBING RULES AND REGULATIONS CURRENTLY IN EFFECT, GOVERNED BY THE ADMINISTRATIVE AUTHORITY HAVING JURISDICTION.
2. THE PLUMBING CONTRACTOR IS RESPONSIBLE FOR THE INSTALLATION OF ALL TRAPS AND CLEANOUTS AS NECESSARY OF THE LOCALITY.
3. THE OPENINGS IN WALLS FOR THE PASSAGE OF PIPES SHALL BE TOTALLY FIRE SEALED TO THE SATISFACTION OF THE PLUMBING INSPECTOR AND/OR THE AUTHORITY HAVING JURISDICTION.

ELECTRIC WATER HEATER SCHEDULE

MARK	EW-1	EW-2
MODEL	DEN-52	DEN-66
TYPE	STORAGE	STORAGE
TANK SIZE (GAL.)	50	66
RECOVERY @ 100 DEGREE F RISE	20	18
HEATING ELEMENT (KW)	5.0	4.5
ELECTRICAL (V/PH/Hz)	240/1/60	240/1/60
SERVICE	POTABLE HOT	POTABLE HOT
REMARKS	1	1

1. MODEL BASED ON A.O. SMITH

PUMP SCHEDULE


MARK	HWRP-1
MODEL	e3-4
WATER FLOW RATE (GPM)	0.5
HEAD (FT)	4
TYPE	IN-LINE
MOTOR SIZE (HP)	ECM 5-28
ELECTRICAL (V/PH/Hz)	120/1/60
MOTOR SPEED (RPM)	-
SERVICE	HOT WATER RECIRC.
REMARKS	1

1. MODEL BASED ON B&G


EXPANSION TANK SCHEDULE

MARK	ET-1
MODEL	ST-5
TANK VOLUME (GAL)	2.1
TANK ACCEPTANCE (GAL)	0.9
LENGTH x DIAMETER (IN x IN)	14 x 8
MAXIMUM DESIGN PRESSURE (PSIG)	150
MAXIMUM DESIGN TEMPERATURE (°F)	200
REMARKS	1

1. MODEL BASED ON AMTROL

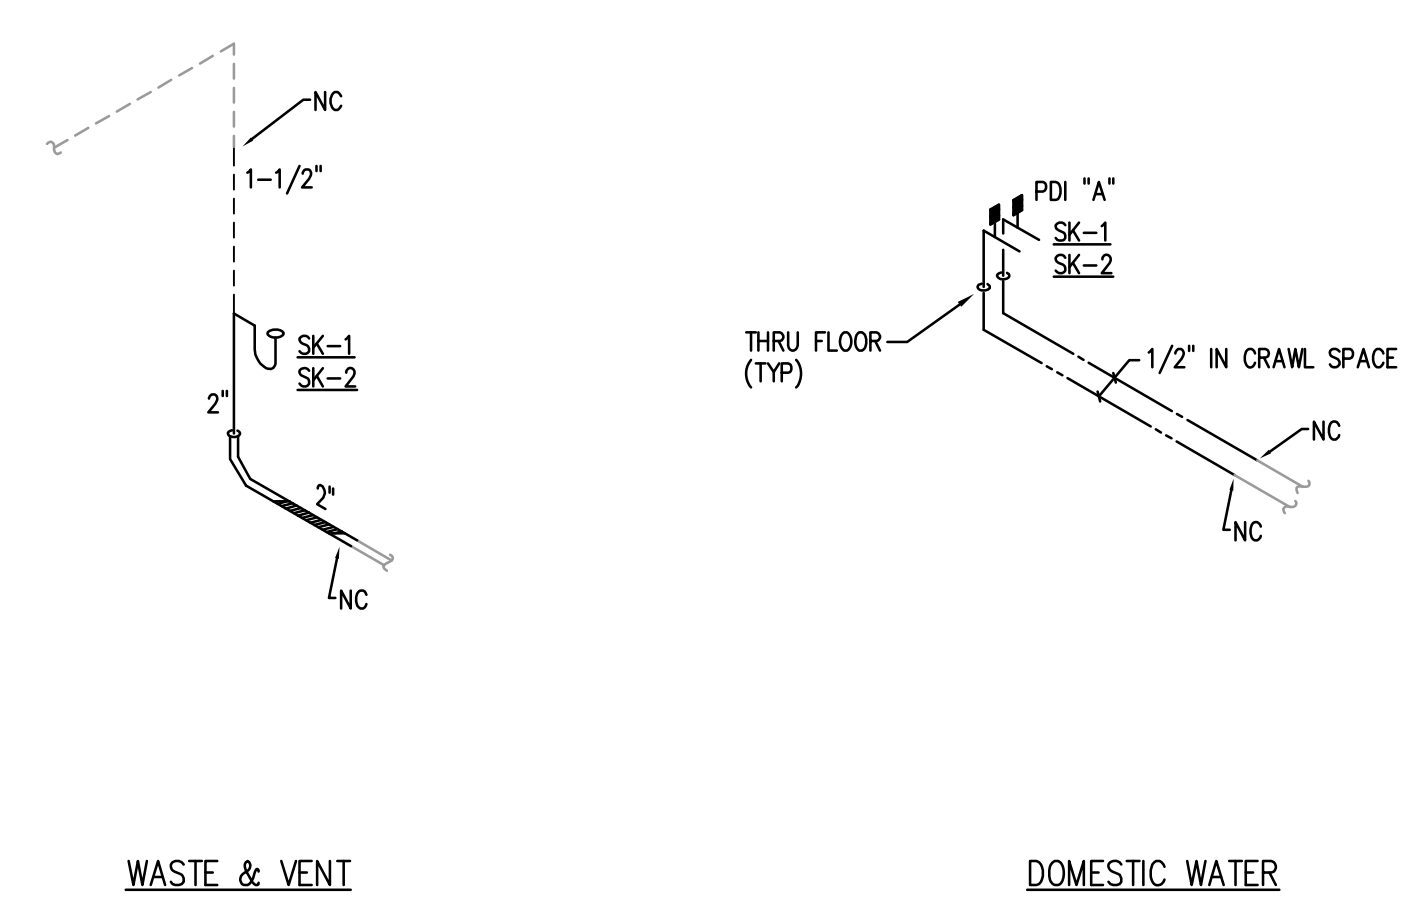

RISER DIAGRAM
SCALE: NTS **7**

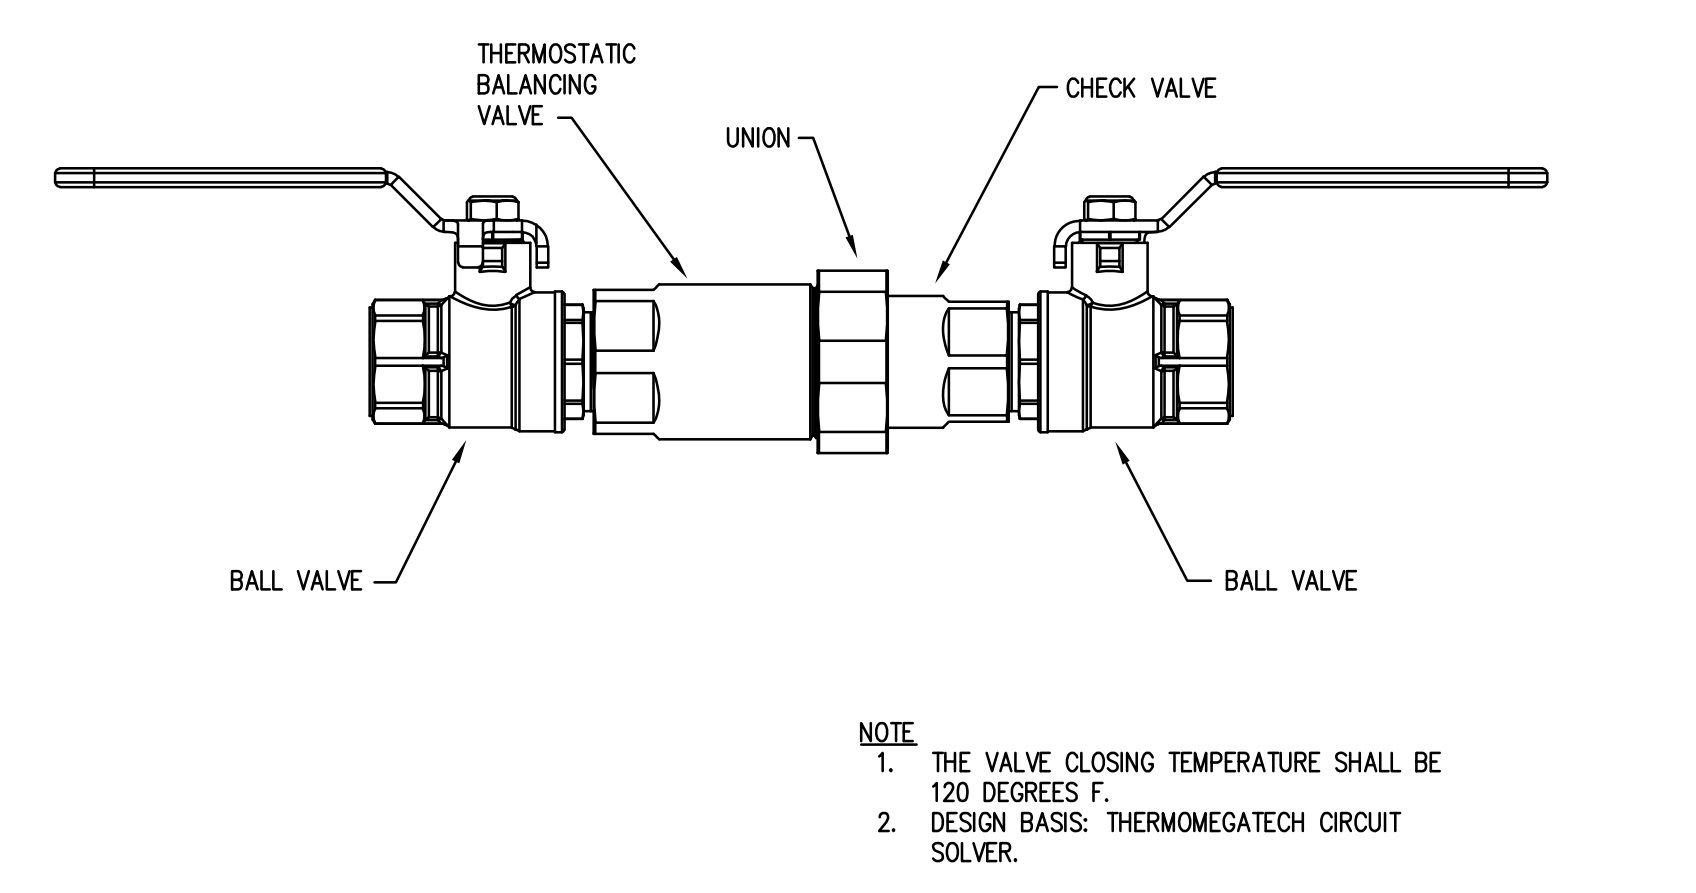

THERMOSTATIC SELF-ACTUATING VALVE DETAILS
SCALE: NTS **3**

ABBREVIATIONS
SCALE: NTS




&	AND	INCR	INCREASER
Ø	DIAMETER OR ROUND	INSUL	INSULATION
ACT	ACTUAL	INT	INTERNAL
AD	ACCESS DOOR	KW	KILOWATT
AFF	ABOVE FINISHED FLOOR	L	LAVATORY
AHU	AIR HANDLING UNIT	LAV	LAVATORY
ALT	ALTERNATE	LT	LAUNDRY TUB
ALUM	ALUMINUM	MAX	MAXIMUM
AP	ACCESS PANEL	MB	MOP BASIN
APPROX	APPROXIMATE	MH	MECHANICAL
AS	AIR SEPARATOR	MFR	MANUFACTURER
AV	ACID VENT	MG	MEDIUM
AVG	AVERAGE	MIN	MINIMUM
AVTR	ACID VENT THROUGH ROOF	MISC	MISCELLANEOUS
AW	ACID WASTE	NC	NEW CONNECTION
BLR	BOILER	NO / #	NUMBER
BM	BEAT	NOM	NOMINAL
BTM	BOTTOM	OD	OUTSIDE DIAMETER
BTU	BRITISH THERMAL UNIT	OPNG	OPENING
CFH	CUBIC FEET PER HOUR	PD	PUMP DISCHARGE
CH	CHILLER	PLUMB	PLUMBING AND DRAINAGE
CHP	CAST IN PLACE	PDI	INSTITUTE
CLG	CEILING	PRESS	PRESSURE
CLNG	CEILING	PSF	POUNDS PER SQUARE FOOT
CMU	CONCRETE MASONRY UNIT	PSIA	POUNDS PER SQUARE INCH, ABSOLUTE
CO	CLEANOUT	PSIG	POUNDS PER SQUARE INCH, GAUGE
CONT	CONTINUATION	R	RADIUS
CS	CUP SINK	RCO	ROOFING CLEAN OUT
CT	COOLING TOWER	RD	ROOF DRAIN
CW	DOMESTIC COLD WATER	REINF	REINFORCING
DBL	DOUBLE	REIN	REQUIRED
DCBP	DOUBLE CHECK BACKFLOW PREVENTER	REV	REVISION
DDBP	DOUBLE CHECK DETECTOR BACKFLOW PREVENTER	RPM	REVOLUTIONS PER MINUTE
DEG	DEGREE	RPZBP	REDUCED PRESSURE ZONE BACKFLOW PREVENTER
DENS	DENSITY	SAN	SANITARY
DF	DRINKING FOUNTAIN	SCHED	SCHEDULE
DIAM	DIAMETER	SD	SHOWER DRAIN
DN	DOWN	SF	SQUARE FEET
DWG	DRAWING	SH	SHOWER
(e)	EXISTING	SHT	SHEET
EL	ELEVATION	SK	SINK
EQUIP	EQUIPMENT	SO	SQUARE
ES	EMERGENCY STATION	SS	SERVICE SINK
ET	EXPANSION TANK	ST	STORM
ETR	EXISTING TO REMAIN	SUSP	SUSPENDED
EW	ELECTRIC WATER COOLER	TB	TRIPLE BASIN
EXT	EXTERNAL	TD	TRENCH DRAIN
F	FAHRENHEIT	THK	THICK
FCD	FLOOR CLEANOUT	TYP	TYPICAL
FD	FLOOR DRAIN	THK	THERMOSTATIC MIXING VALVE
FDR	FLOOR DRAIN	UF	UNDER FLOOR SLAB
FT	FEET	UR	URNAL
FTG	FOOTING	V	VERTICAL
GA	NATURAL GAS, LOW PRESSURE	VERT	VERTICAL THROUGH ROOF
GC	GENERAL CONTRACTOR	W/	WITH
GPM	GALLONS PER MINUTE	W/O	WITHOUT
HB	HOSE BIB	W	WASTE
HORIZ	HORIZONTAL	WC	WATER CLOSET
HP	HORSEPOWER	WCO	WALL CLEANOUT
HW	DOMESTIC HOT WATER	WH	WATER HAMMER
HWR	HOT WATER RECIRCULATION	WHA	WATER HAMMER ARRESTER
HWRP	HOT WATER RECIRCULATION		
ID	INSIDE DIAMETER		

THIS LIST IS AN ALL INCLUSIVE MASTER LIST USED BY THIS FIRM. THE INCLUSION OF THESE ABBREVIATIONS INTO THESE DOCUMENTS DOES NOT IMPLY THAT ALL THE ABBREVIATIONS ARE INCORPORATED INTO THIS PROJECT.

PLUMBING SYMBOLS
SCALE: NTS

---	COLD WATER PIPING	---	GATE VALVE
---	HOT WATER PIPING	---	CHECK VALVE
---	HOT WATER RECIRC PIPING	---	BALL VALVE
---	HOT WATER PIPING (TEMP)	---	GAS COCK VALVE
---	VENT PIPING	---	GAS PRESSURE REGULATOR
---	WASTE PIPING	---	PRESSURE REDUCING VALVE
---	SANITARY WASTE PIPING	---	BALANCING VALVE
---	WASTE PIPE, UNDERGROUND	---	BACKFLOW PREVENTER
---	STORM PIPING	---	STRAINER
---	STORM PIPING, UNDERGROUND	---	RELIEF VALVE
---	ACID WASTE PIPE, UNGD	---	FLOOR DRAIN, ROUND
---	ACID WASTE PIPE, UNGD	---	FLOOR DRAIN, SQUARE
---	GAS PIPING, LOW PRESSURE	---	FLEXIBLE PIPE CONNECTION
---	GAS PIPING, MEDIUM PRESS	---	WATER METER
---	SUBSOIL DRAIN	---	GAS METER
---	PIPE ELBOW DOWN	---	PIPE FLANGE
---	PIPE ELBOW UP	---	CAP
---	PIPE TEE, DOWN	---	DRIP POCKET
---	PIPE TEE, UP	---	PRESSURE GAUGE
---	HOSE BIB	---	TEMPERATURE GAUGE
---	THERMOSTATIC BALANCING VALVE WITH CHECK AND SHUTOFFS	---	IN-LINE PUMP

THIS LIST IS AN ALL INCLUSIVE MASTER LIST USED BY THIS FIRM. THE INCLUSION OF THESE SYMBOLS INTO THESE DOCUMENTS DOES NOT IMPLY THAT ALL THE SYMBOLS ARE INCORPORATED INTO THIS PROJECT.

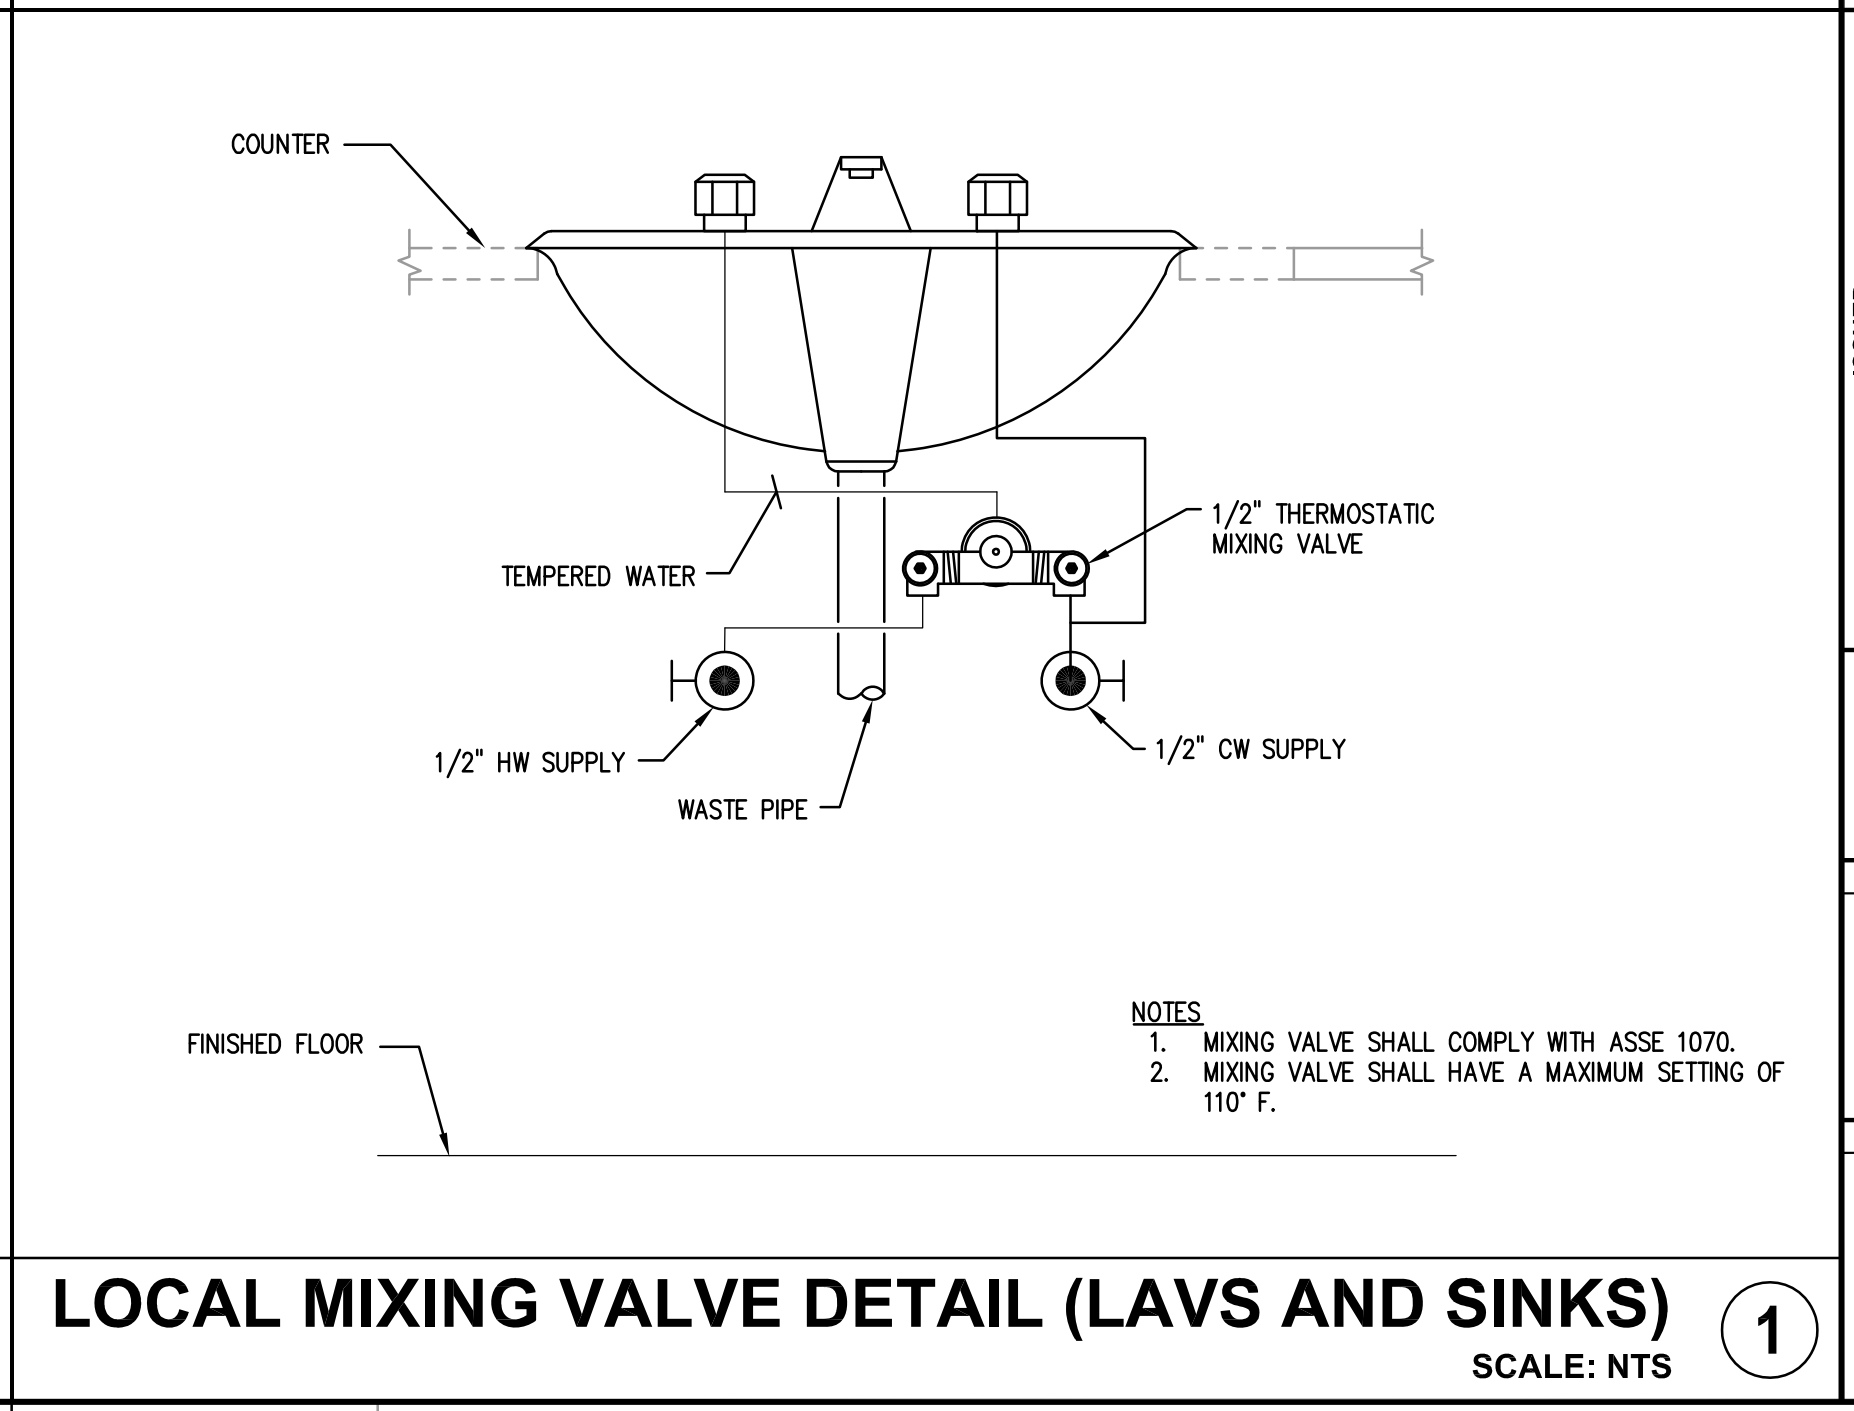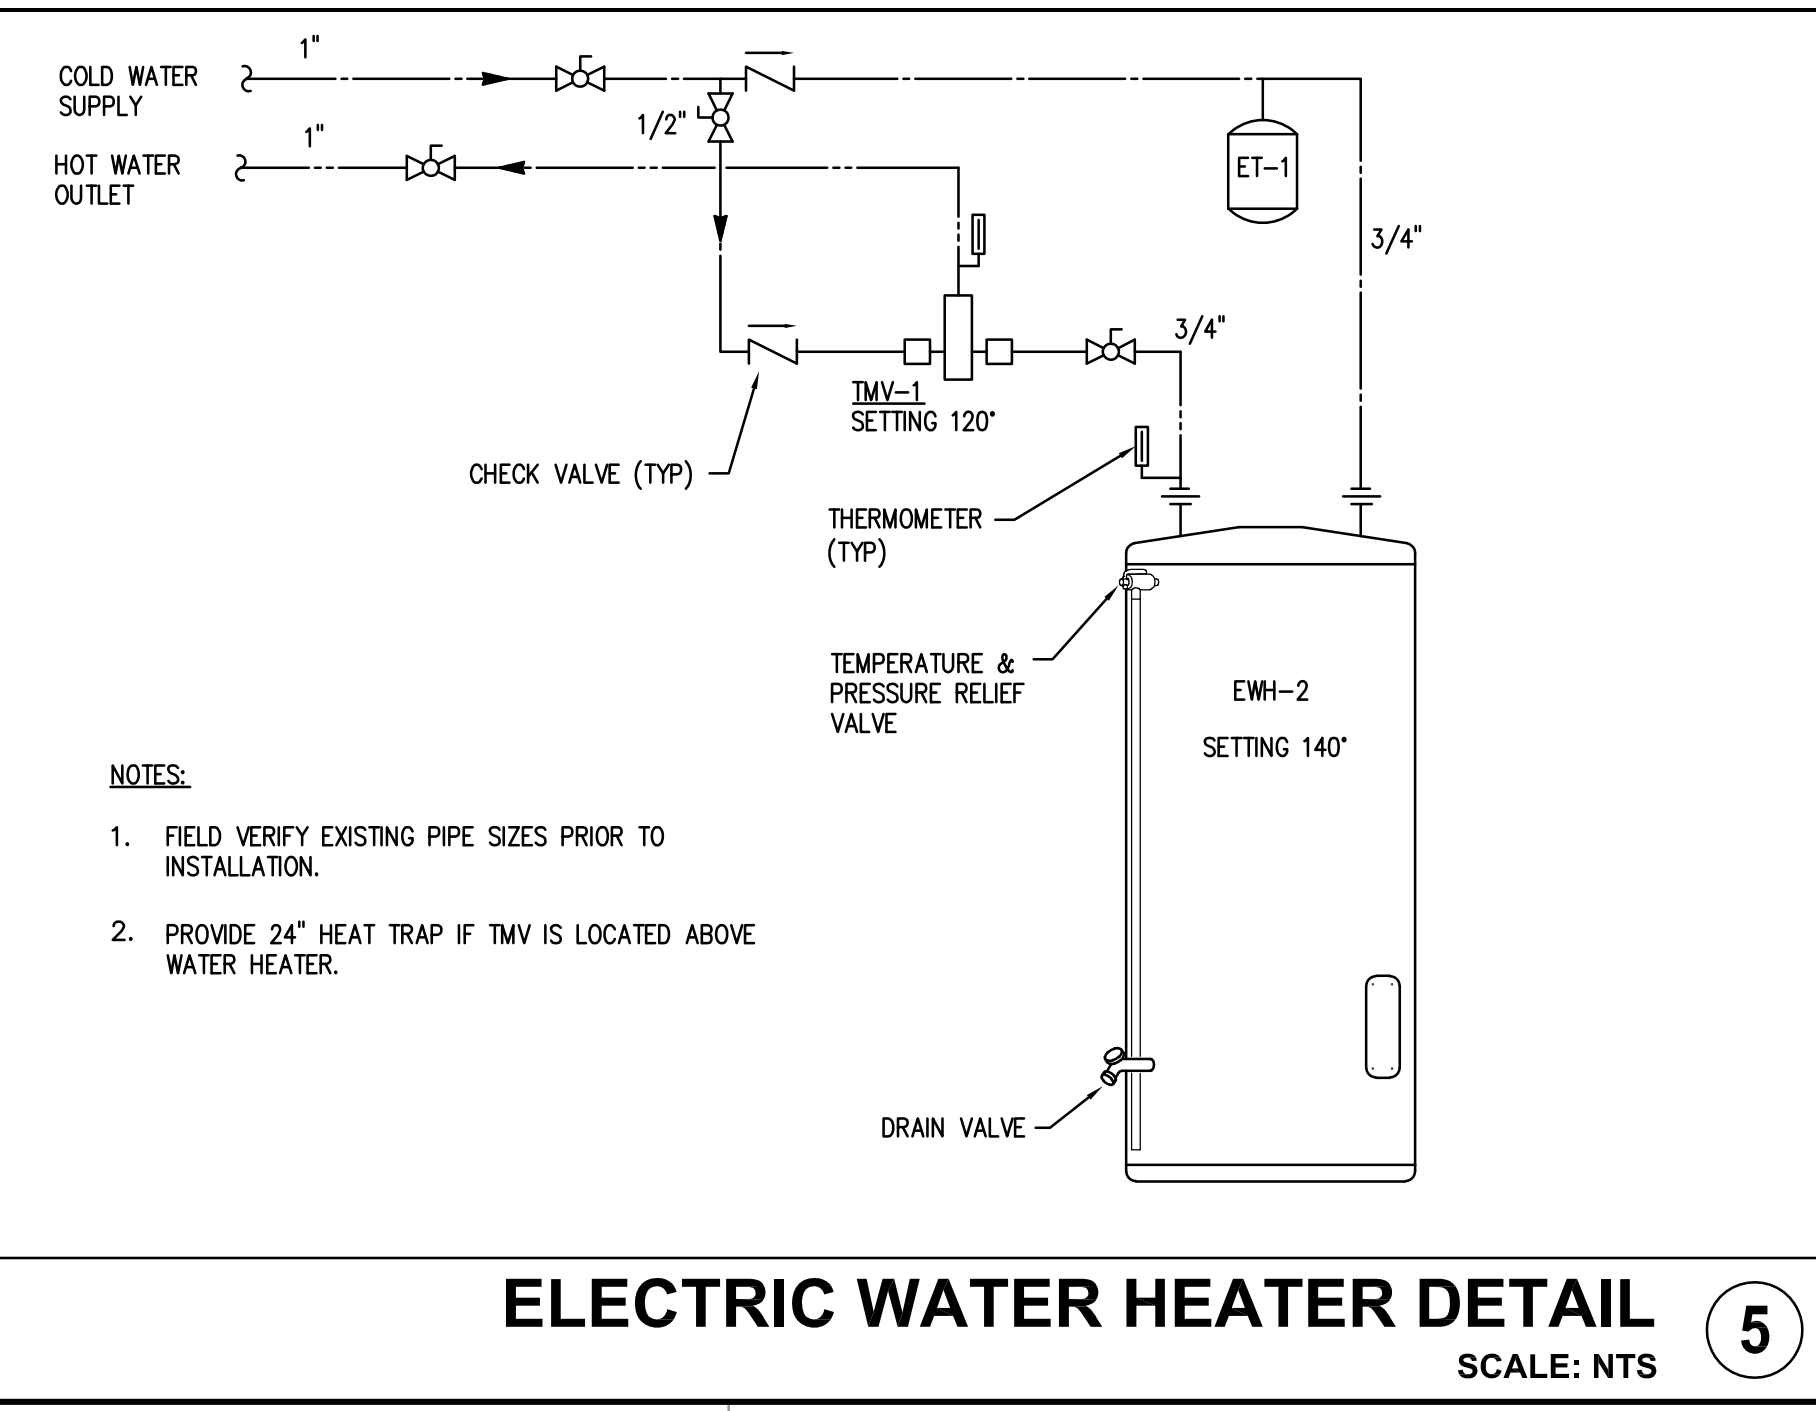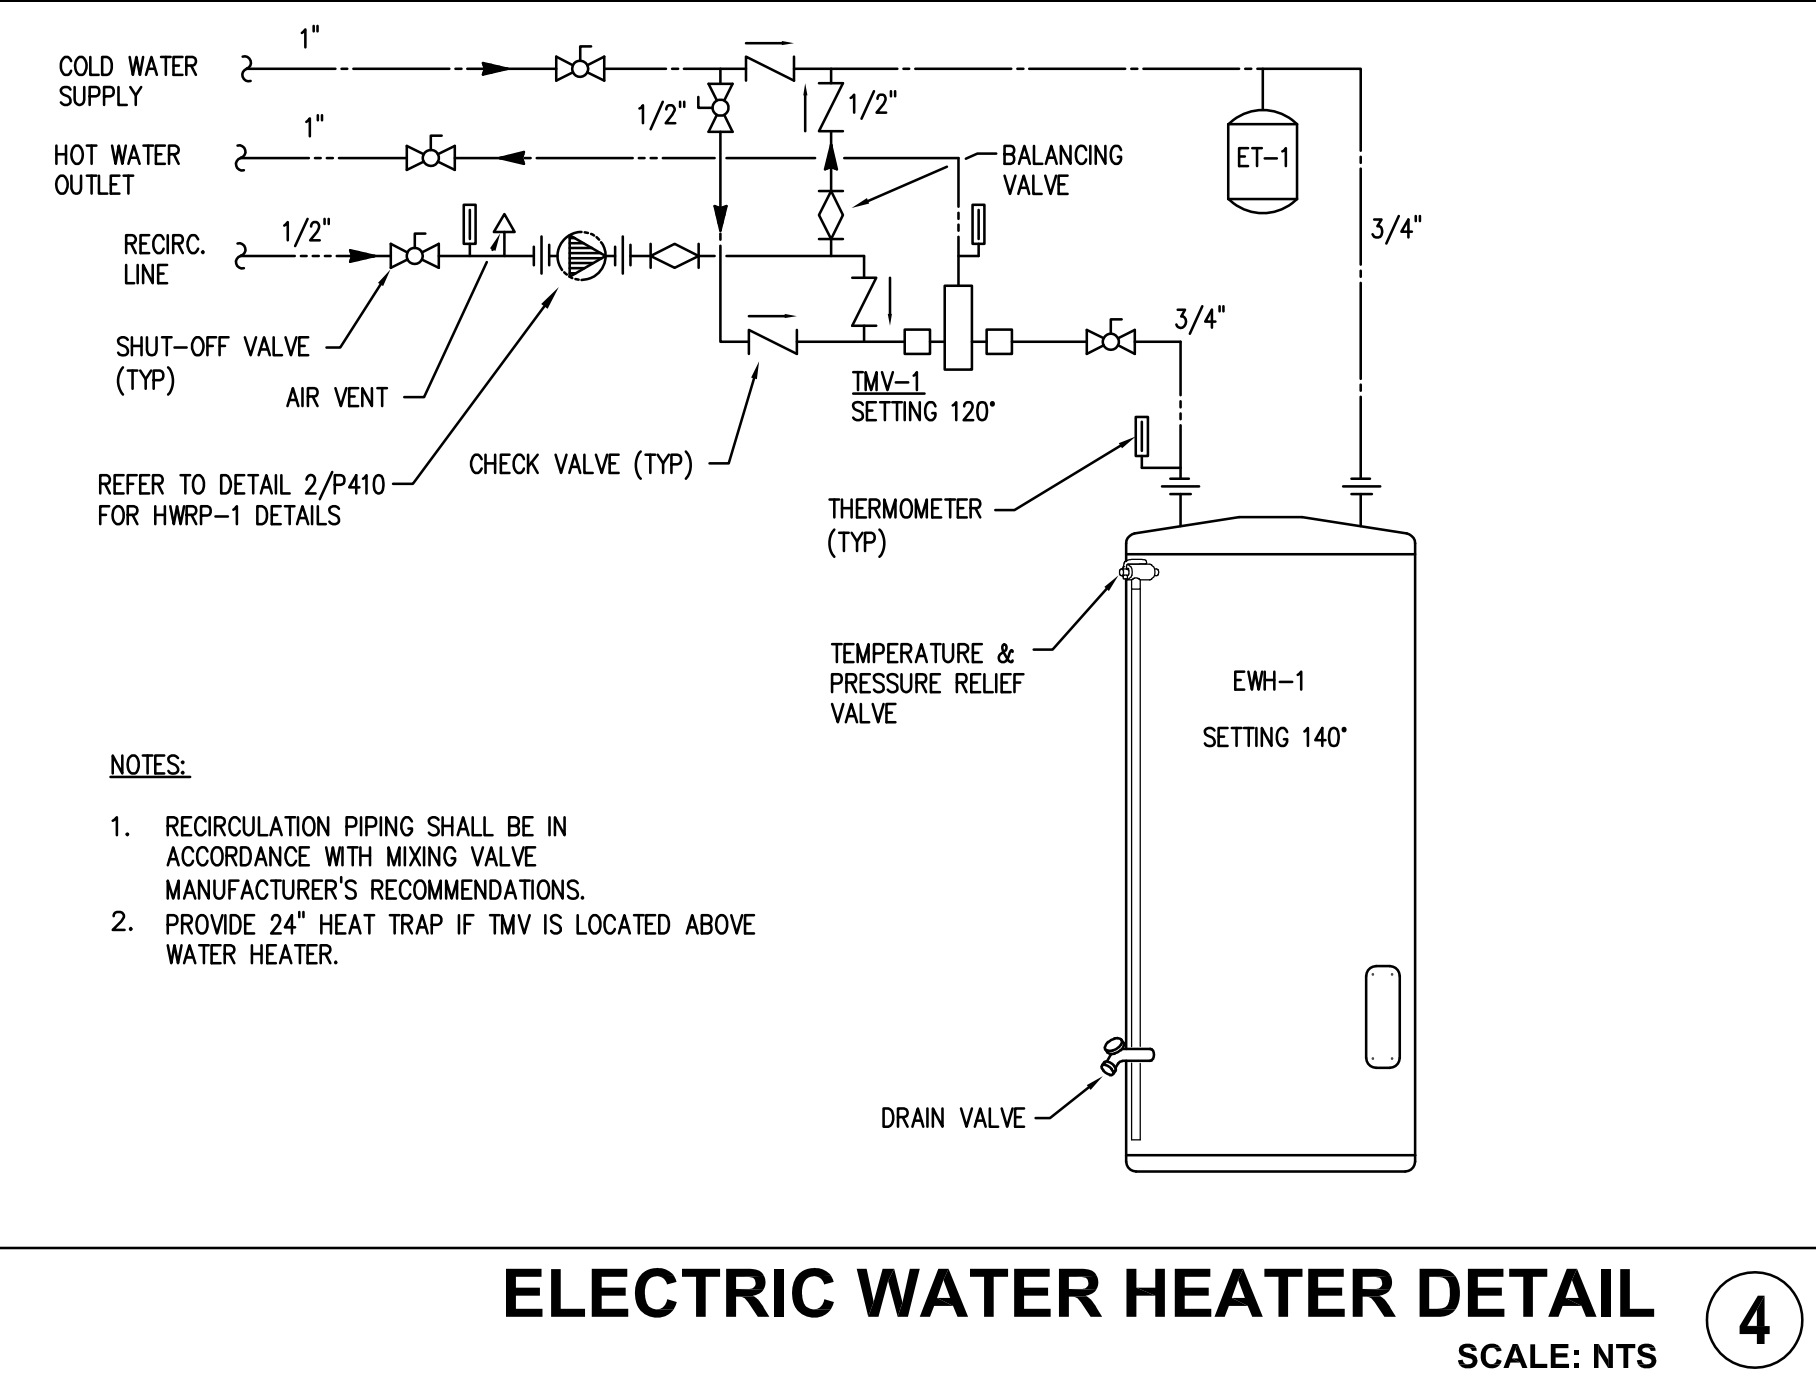

ABBREVIATIONS

Table with columns: SYMBOL, DESCRIPTION, SYMBOL, DESCRIPTION. Lists various electrical symbols and their meanings, including terms like AMP, BREAKER, CONDUIT, and various types of switches and outlets.

THIS IS A MASTER LEGEND AND NOT ALL SYMBOLS, ABBREVIATIONS, ETC., ARE NECESSARILY USED IN THIS PROJECT.

ELECTRICAL SYMBOLS LIST

Table with columns: SYMBOL, DESCRIPTION, SYMBOL, DESCRIPTION, SYMBOL, DESCRIPTION. Lists electrical symbols for luminaries, power equipment, mounting heights, miscellaneous, and security/signaling systems.

NOTE: SCALES DEPICTED ON THIS DRAWING ARE NOT CORRECT UNLESS PLOTTED SHEET SIZE IS 30 X 42 INCHES.

KLUBER Architects + Engineers

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KEN PICKERILL HOUSE RENOVATIONS KENDALL COUNTY FOREST PRESERVE DISTRICT 110 W. MADISON STREET YORKVILLE, IL 60560

Table with 2 columns: REVISED, BIDD DOCUMENTS. Shows revision history.

Table with 2 columns: JOB NO., DRAWN, CHECKED, APPROVED. Shows project details and approvals.

ELECTRICAL SYMBOLS LIST & ABBREVIATIONS


SHEET NUMBER E050

PU1250 - Kendall County Forest Preserve - Pickerill Estate House Conversion03_04.dwg (1/25/2021 10:02:24 AM, ATR)

KEYNOTES

KEYNOTES ARE TYPICALLY NOT DUPLICATED WITHIN A GIVEN DETAIL. AN UN-KEYNOTED ITEM IN A DETAIL IS THE SAME AS A KEYNOTED ITEM HAVING THE SAME APPEARANCE WITHIN THE SAME DETAIL.

- 26.101 DEMOLISH EXISTING MAIN DISCONNECT SWITCH. PROTECT EXISTING FEEDERS TO BE REUSED FOR NEW DISTRIBUTION PANEL.
- 26.102 DEMOLISH EXISTING ELECTRICAL CONNECTION TO ELECTRIC WATER HEATER TO BE REPLACED.

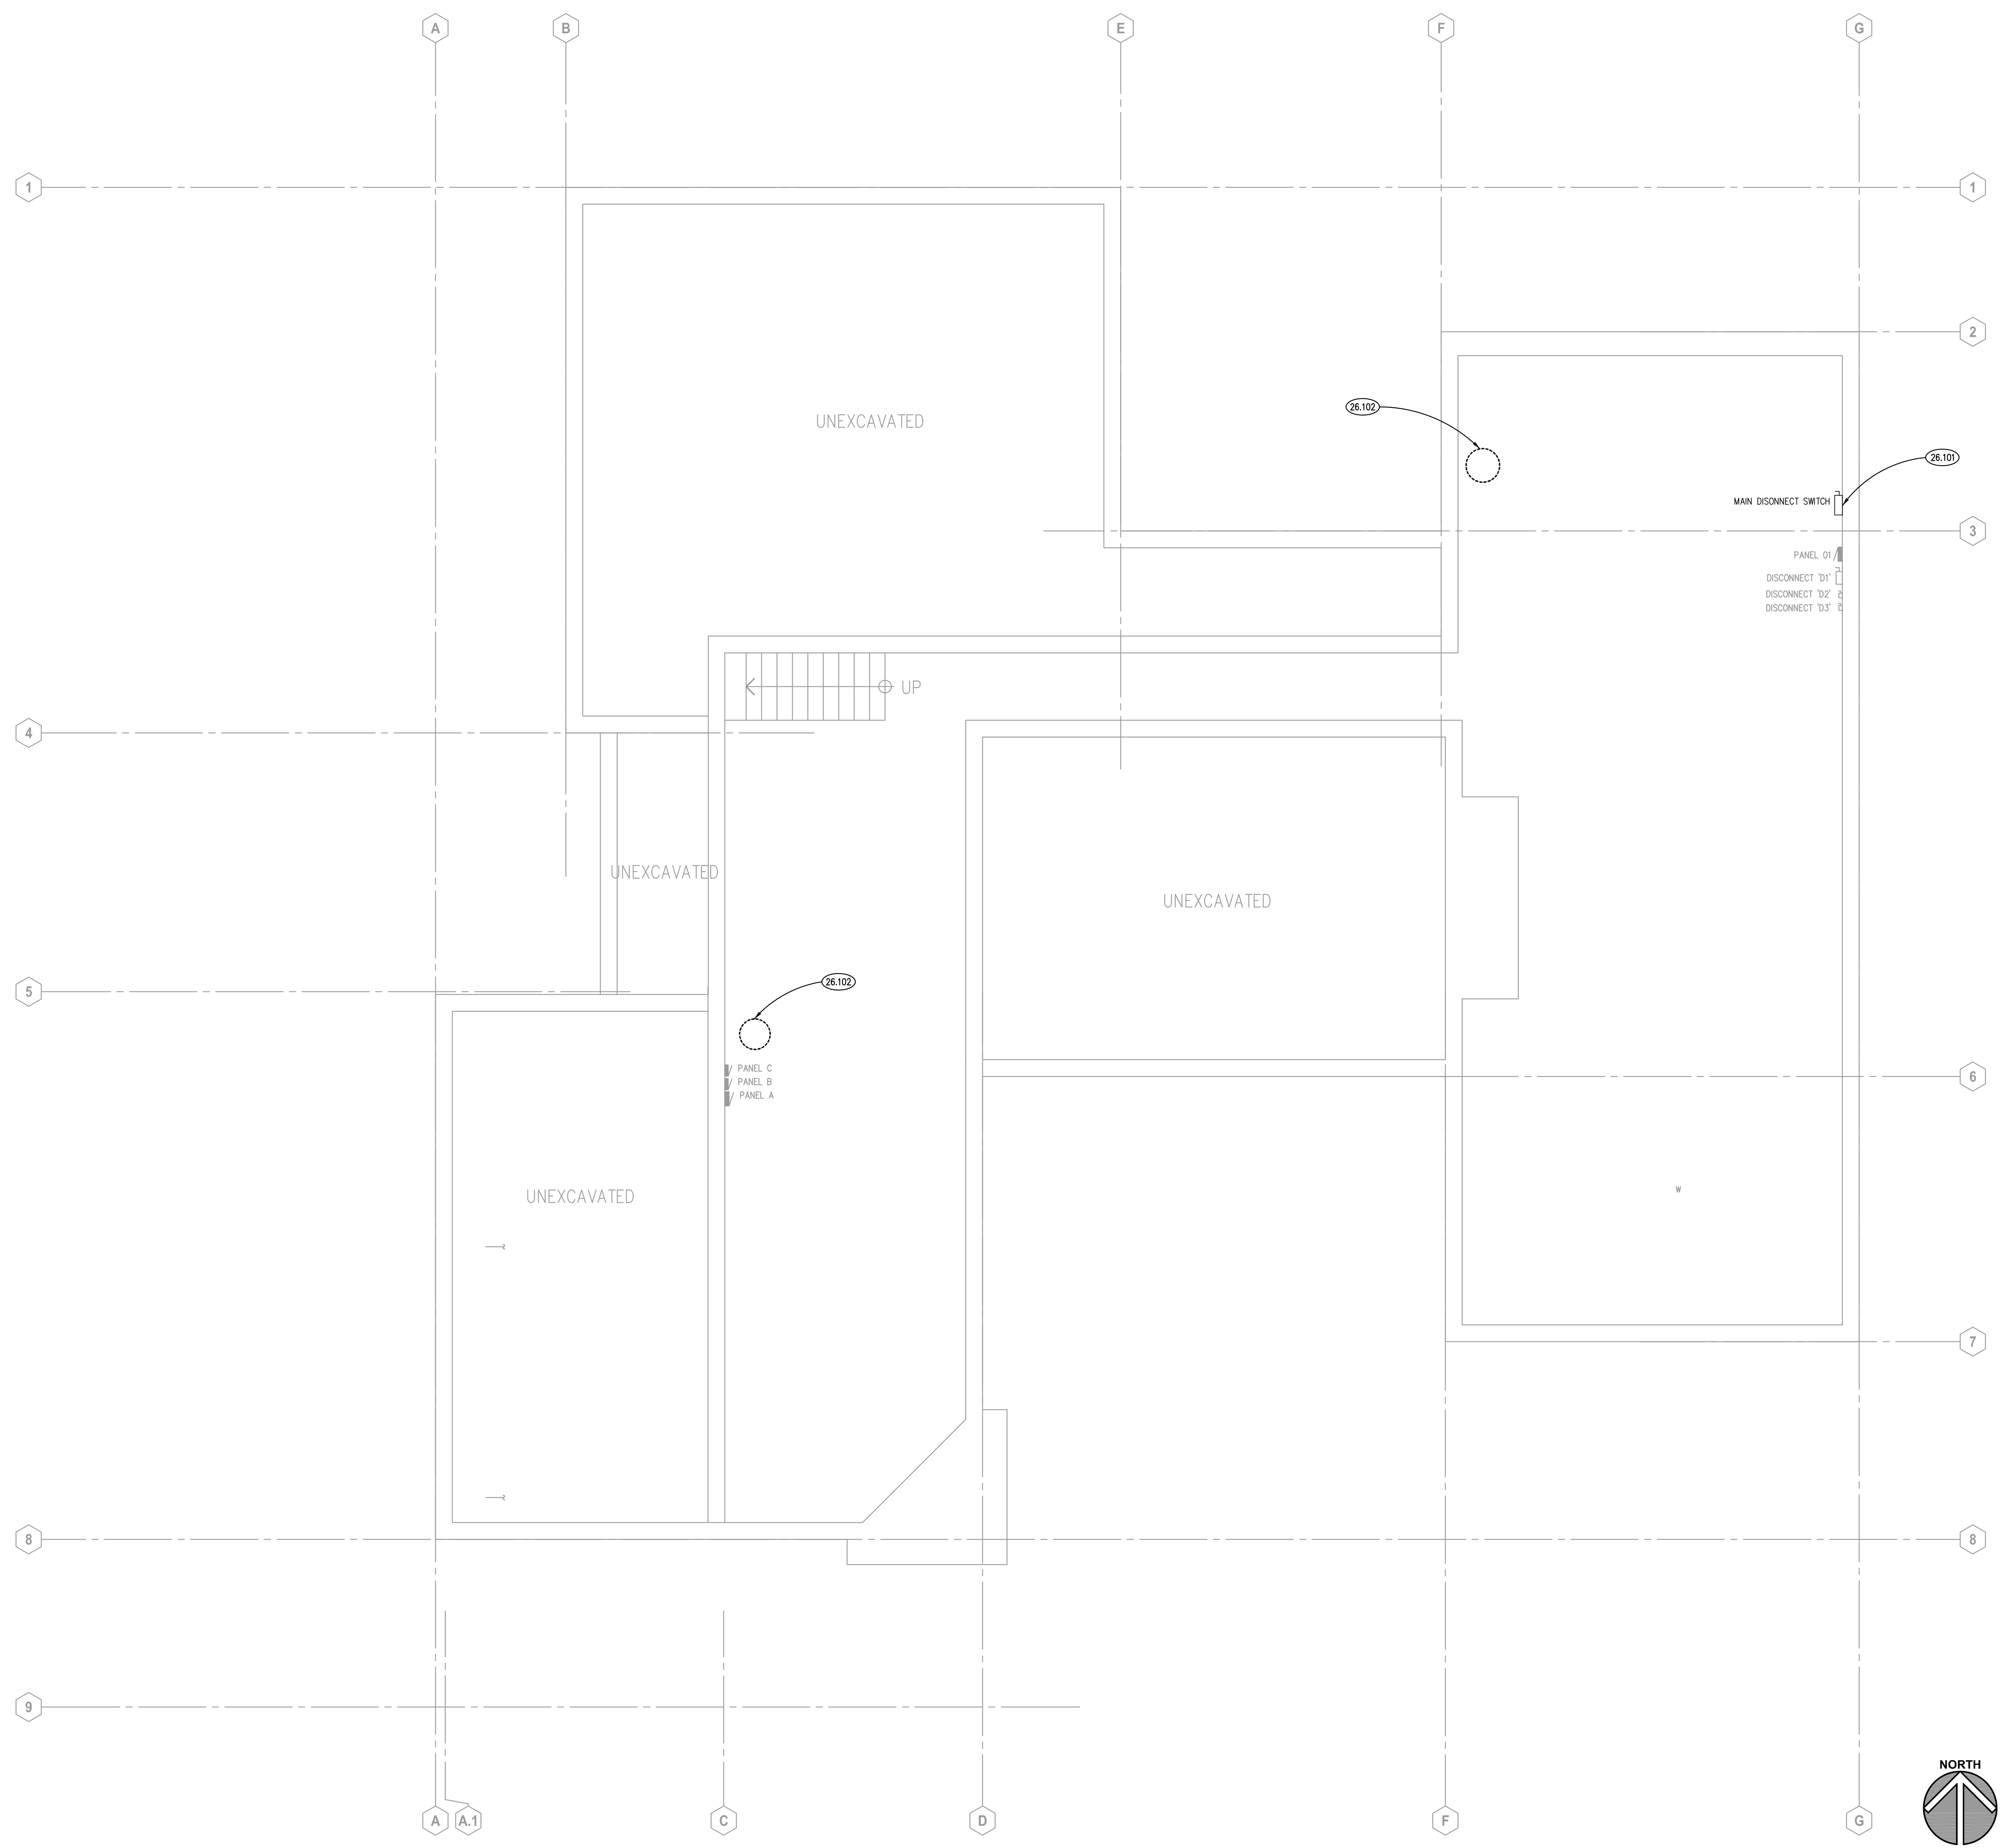

GENERAL NOTES

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- INTENT OF DRAWINGS: THESE DRAWINGS ARE INTENDED TO RELAY TO CONTRACTOR A DESIGN INTENT. INCLUDE IN BID ALL LABOR AND MATERIALS NECESSARY FOR A COMPLETE AND OPERATIONAL SYSTEM AS REASONABLY INFERABLE, AS DETERMINED BY ARCHITECT, TO ACCOMPLISH THE INTENT OF THESE DRAWINGS.
- REFER TO ARCHITECTURAL, PLUMBING, AND MECHANICAL PLANS, SHOP DRAWINGS AND MANUFACTURERS INSTALLATION INSTRUCTIONS FOR ADDITIONAL INFORMATION ON EXACT POWER, WIRING & ROUGH-IN REQUIREMENTS AND LOCATIONS OF DEVICES.
- UNLESS NOTED OTHERWISE, ALL HOMERUNS SHALL CONSIST OF A MAXIMUM OF 2 CIRCUITS (PHASE A & B, NEUTRAL & GROUND) IN 1/2" MINIMUM WIRE SIZE SHALL BE #12 AWG. WIRE SIZE FOR HOMERUN CIRCUITS SHALL BE 2#12, 1#12N & 1#12G.
- SECURE ALL JUNCTION BOXES TO BUILDING STRUCTURE PER NEC REQUIREMENTS.

ISSUED	
BID DOCUMENTS	
01/09/22	

JOB NO.	19-429-1250
DRAWN	ATR
CHECKED	MTK
APPROVED	MTK

SHEET TITLE

BASEMENT ELECTRICAL DEMOLITION PLAN

SHEET NUMBER

BASEMENT ELECTRICAL DEMOLITION PLAN 1

SCALE: 1/4" = 1'-0"

E200

KEYNOTES

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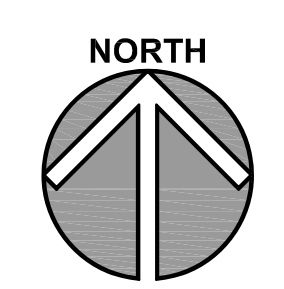
- 26.103 AREA OF TOTAL DEMOLITION. DEMOLISH ALL ELECTRICAL DEVICES WITHIN THIS AREA, INCLUDING BUT NOT LIMITED TO: RECEPTACLES, LUMINAIRES, SWITCHES, CONNECTIONS TO EQUIPMENT.
- 26.104 DISCONNECT AND PROTECT EXISTING BRANCH CIRCUITRY FOR LIGHTING TO BE REPLACED.
- 26.105 EXISTING KITCHEN ISLAND TO BE DEMOLISHED. DEMOLISH ALL ELECTRICAL CONNECTIONS TO STOVE TOP, RECEPTACLES, DISHWASHER AND ALL OTHER ELECTRICAL FIXTURES.

ROOM SCHEDULE

RM. NO.	ROOM NAME	RM. NO.	ROOM NAME
105	EXISTING BEDROOM		
106	EXISTING BATHROOM		
107	EXISTING LIVING ROOM		
108	EXISTING STORAGE		
109	EXISTING STORAGE		
110	EXISTING CORRIDOR		
111	EXISTING BATHROOM		
112	EXISTING JANITOR'S CLOSET		
113	EXISTING DINING ROOM		
114	EXISTING KEEPING ROOM		
115	EXISTING PANTRY		
116	EXISTING KITCHENETTE		
117	EXISTING GREEN HOUSE		
118	EXISTING FOYER		
119	EXISTING GARAGE		
120	EXISTING STORAGE		

GENERAL NOTES

1. REFER TO DRAWING G100 FOR PROJECT GENERAL NOTES.
2. INTENT OF DRAWINGS: THESE DRAWINGS ARE INTENDED TO RELAY TO CONTRACTOR A DESIGN INTENT. INCLUDE IN BID ALL LABOR AND MATERIALS NECESSARY FOR A COMPLETE AND OPERATIONAL SYSTEM AS REASONABLY INFERRABLE, AS DETERMINED BY ARCHITECT, TO ACCOMPLISH THE INTENT OF THESE DRAWINGS.
3. REFER TO ARCHITECTURAL, PLUMBING, AND MECHANICAL PLANS, SHOP DRAWINGS AND MANUFACTURERS INSTALLATION INSTRUCTIONS FOR ADDITIONAL INFORMATION ON EXACT POWER, WIRING & ROUGH-IN REQUIREMENTS AND LOCATIONS OF DEVICES.
4. UNLESS NOTED OTHERWISE, ALL HOMERUNS SHALL CONSIST OF A MAXIMUM OF 2 CIRCUITS (PHASE A & B, NEUTRAL & GROUND) IN 1/2" MINIMUM WIRE SIZE SHALL BE #12 AWG. WIRE SIZE FOR HOMERUN CIRCUITS SHALL BE 2#12, 1#12N & 1#12G.
5. SECURE ALL JUNCTION BOXES TO BUILDING STRUCTURE PER NEC REQUIREMENTS.



FIRST FLOOR ELECTRICAL DEMOLITION PLAN


SCALE: 1/4" = 1'-0" 1



KEYNOTES


KEYNOTES ARE TYPICALLY NOT DUPLICATED WITHIN A GIVEN DETAIL. AN UN-KEYNOTED ITEM IN A DETAIL IS THE SAME AS A KEYNOTED ITEM HAVING THE SAME APPEARANCE WITHIN THE SAME DETAIL.

26.100 DEMOLISH ELECTRICAL CONNECTION TO EXISTING ROOFTOP UNIT TO BE REMOVED AND REPLACED. DEMOLISH ASSOCIATED SUB-PANEL. DISCONNECT AND PROTECT EXISTING FEEDERS FOR REUSE FOR NEW ROOFTOP UNIT TO BE INSTALLED.

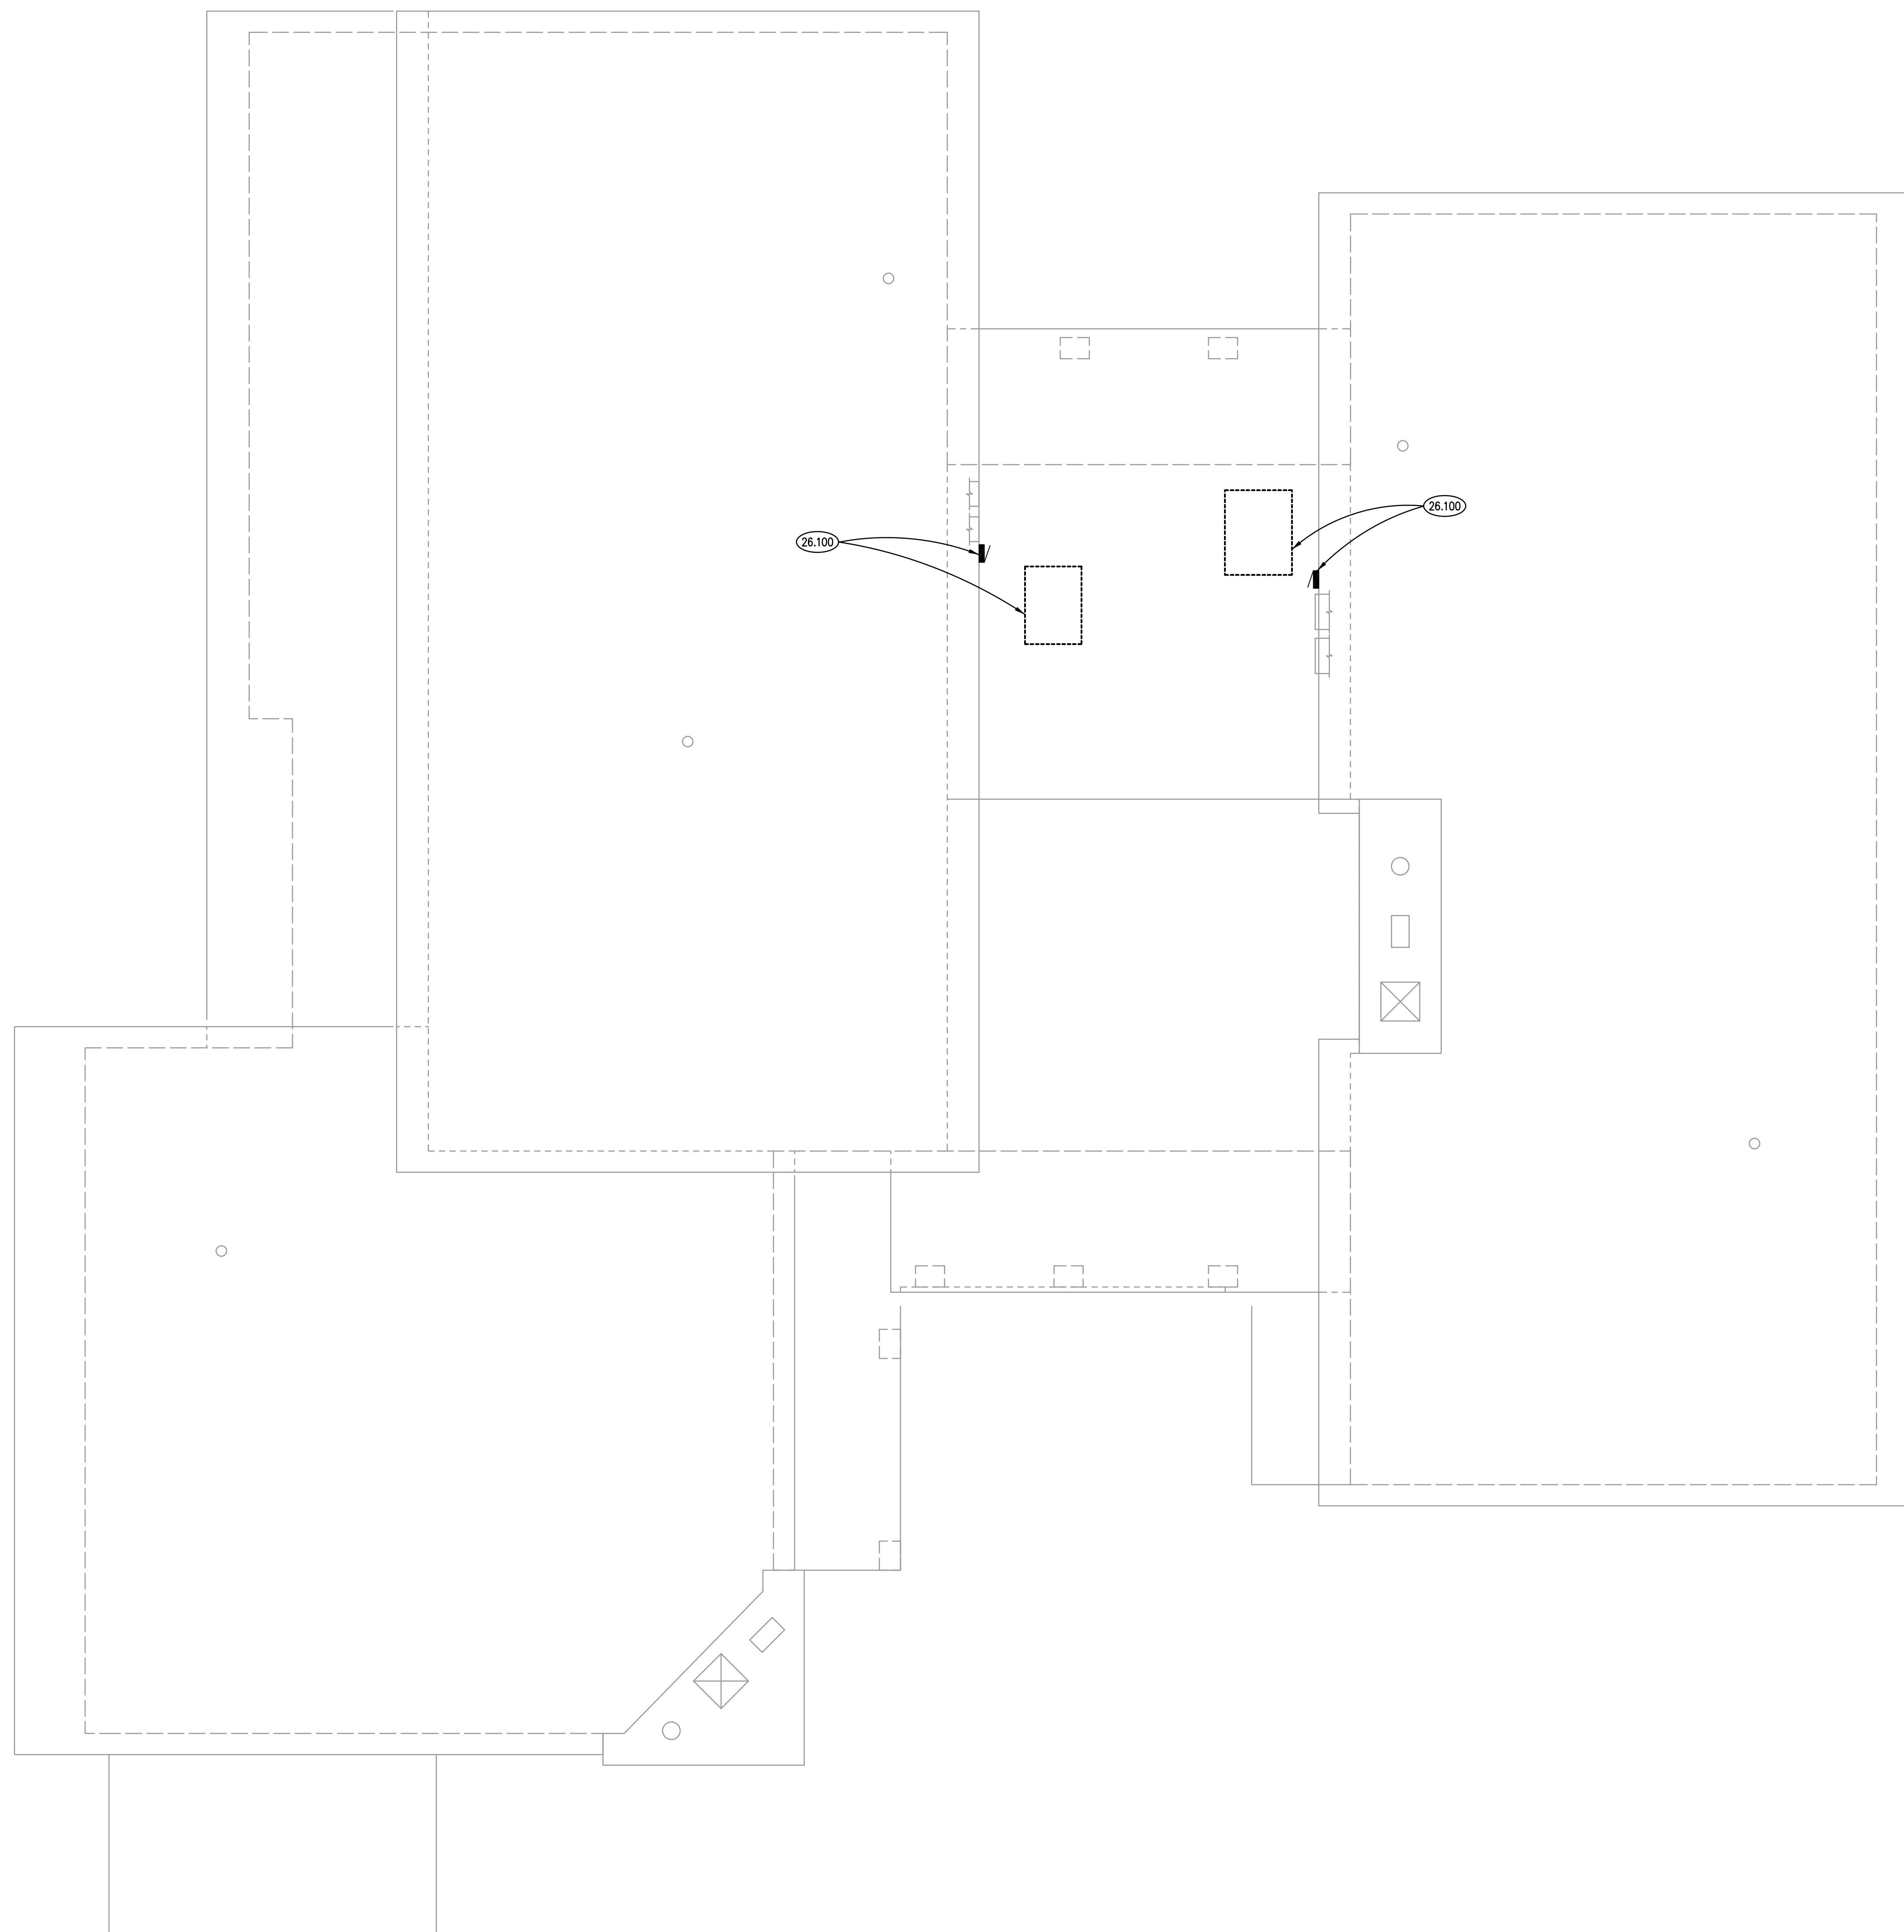

GENERAL NOTES

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ELECTRICAL DEMOLITION ROOF PLAN 1

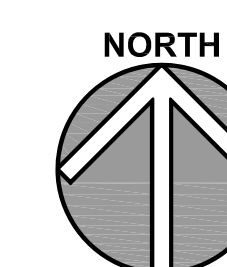SCALE: 1/4" = 1'-0"

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KEN PICKERILL HOUSE RENOVATIONS

KENDALL COUNTY FOREST PRESERVE DISTRICT
110 W. MADISON STREET
YORKVILLE, IL 60560

ISSUED	
REVISED	
DATE	
BY	
DESCRIPTION	

JOB NO.	19-429-1250
DRAWN	ATR
CHECKED	MTK
APPROVED	MTK

SHEET TITLE

ELECTRICAL
DEMOLITION ROOF
PLAN


SHEET NUMBER

E230

KEYNOTES


KEYNOTES ARE TYPICALLY NOT DUPLICATED WITHIN A GIVEN DETAIL. AN UN-KEYNOTED ITEM IN A DETAIL IS THE SAME AS A KEYNOTED ITEM HAVING THE SAME APPEARANCE WITHIN THE SAME DETAIL.

- 26.300 FIELD VERIFY EXISTING LOADS FED FROM MAIN DISCONNECT SWITCH PRIOR TO ORDER OF MAIN DISTRIBUTION PANEL. TRACE AND IDENTIFY ALL EXISTING LOADS. NOTIFY ENGINEER OF DEVIATIONS. PROVIDE NEW CIRCUIT BREAKERS AND EXTEND EXISTING BRANCH CIRCUITRY TO NEW MDP FOR ALL EXISTING LOADS TO REMAIN.
- 26.301 PROVIDE NEW ELECTRICAL CONNECTION TO ELECTRIC WATER HEATER. HOMERUN 2#10,#10G,3/4"C.

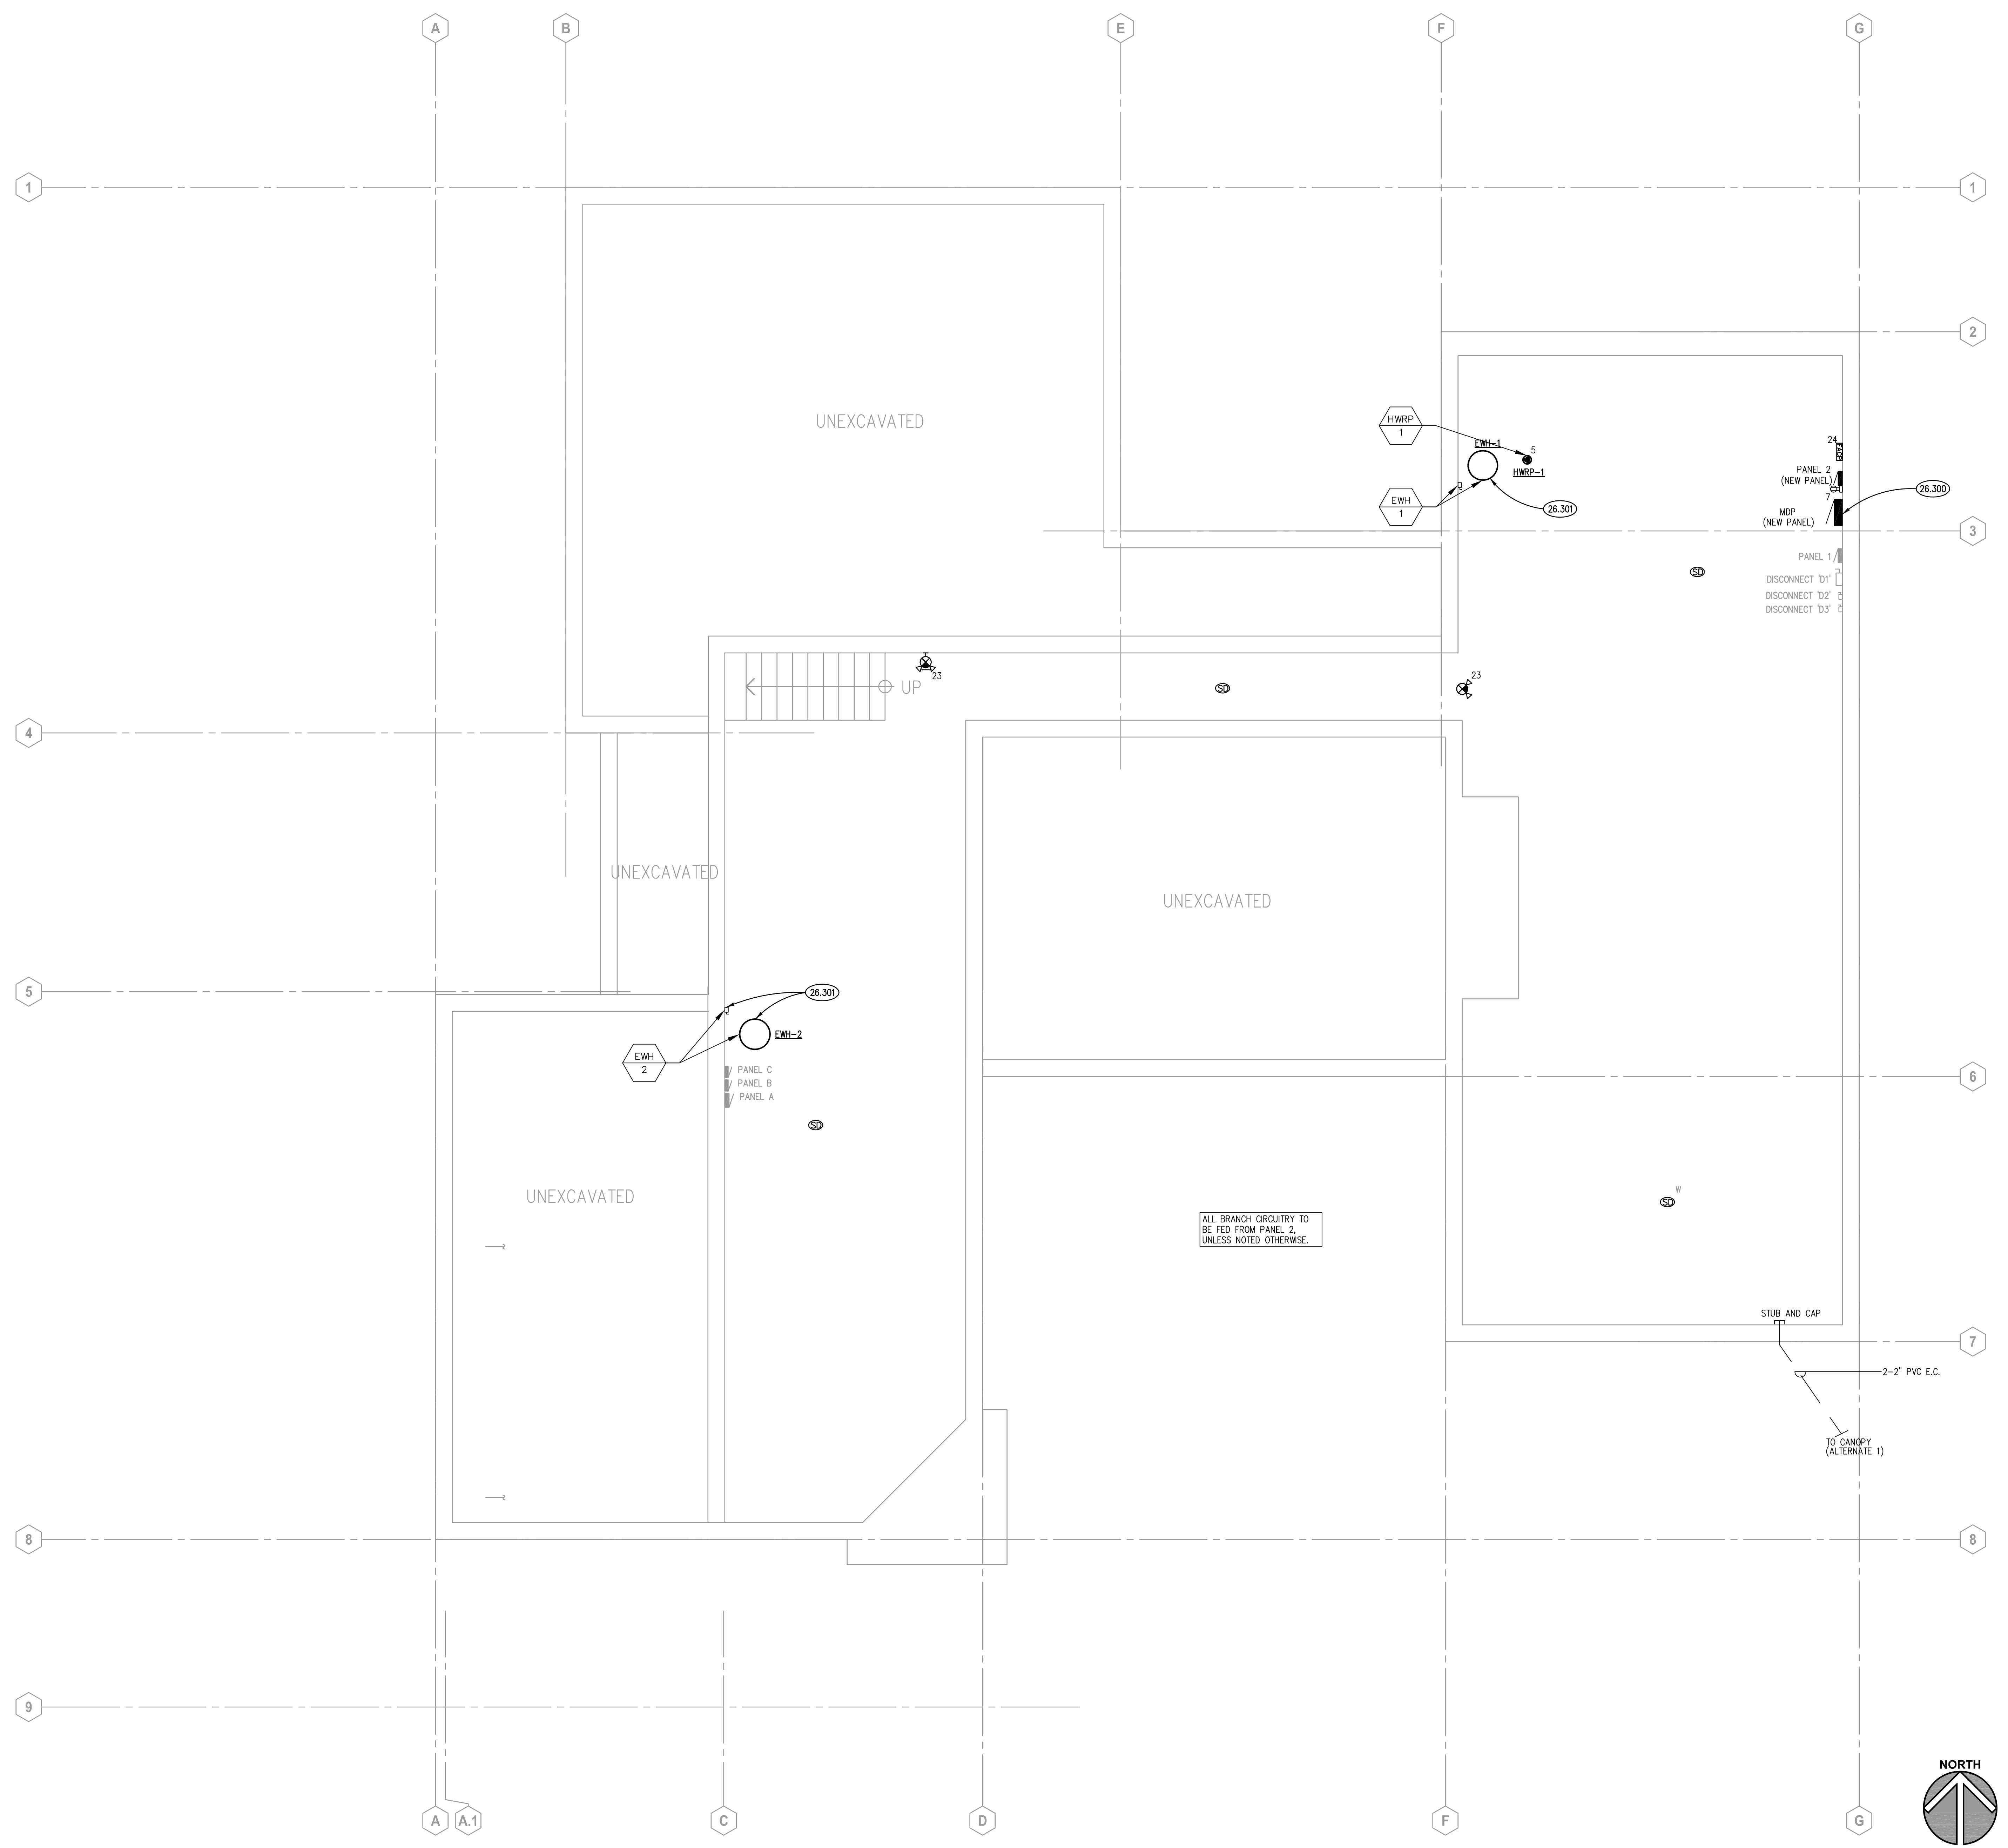

GENERAL NOTES

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- REFER TO ARCHITECTURAL, PLUMBING, AND MECHANICAL PLANS, SHOP DRAWINGS AND MANUFACTURERS INSTALLATION INSTRUCTIONS FOR ADDITIONAL INFORMATION ON EXACT POWER, WIRING & ROUGH-IN REQUIREMENTS AND LOCATIONS OF DEVICES.
- UNLESS NOTED OTHERWISE, ALL HOMERUNS SHALL CONSIST OF A MAXIMUM OF 2 CIRCUITS (PHASE A & B, NEUTRAL & GROUND) IN 1/2" C. MINIMUM WIRE SIZE SHALL BE #12 AWG. WIRE SIZE FOR HOMERUN CIRCUITS SHALL BE 2#12, 1#12N & 1#12G.
- SECURE ALL JUNCTION BOXES TO BUILDING STRUCTURE PER NEC REQUIREMENTS.

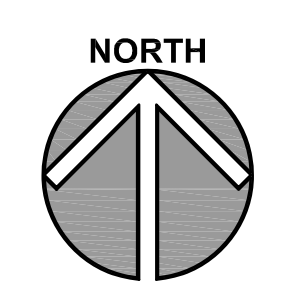

BASEMENT ELECTRICAL PLAN 1

SCALE: 1/4" = 1'-0"

ISSUED
01/10/2022
BID DOCUMENTS

JOB NO.	19-429-1250
DRAWN	ATR
CHECKED	MTK
APPROVED	MTK


SHEET TITLE
BASEMENT ELECTRICAL PLAN
SHEET NUMBER

E300

KEYNOTES

KEYNOTES ARE TYPICALLY NOT DUPLICATED WITHIN A GIVEN DETAIL. AN UN-KEYNOTED ITEM IN A DETAIL IS THE SAME AS A KEYNOTED ITEM HAVING THE SAME APPEARANCE WITHIN THE SAME DETAIL.

- 26.201 PROVIDE QTY. 2, 2" PVC E.C. FOR FUTURE SOLAR PV FROM CANOPY ATTIC SPACE TO BUILDING BASEMENT. STUB AND CAP AT EACH END.
- 26.203 LOW VOLTAGE TRANSFORMER FOR HARDSCAPE LIGHTING.
- 26.401 CANOPY LIGHTING MANUAL DIMMING CONTROL.

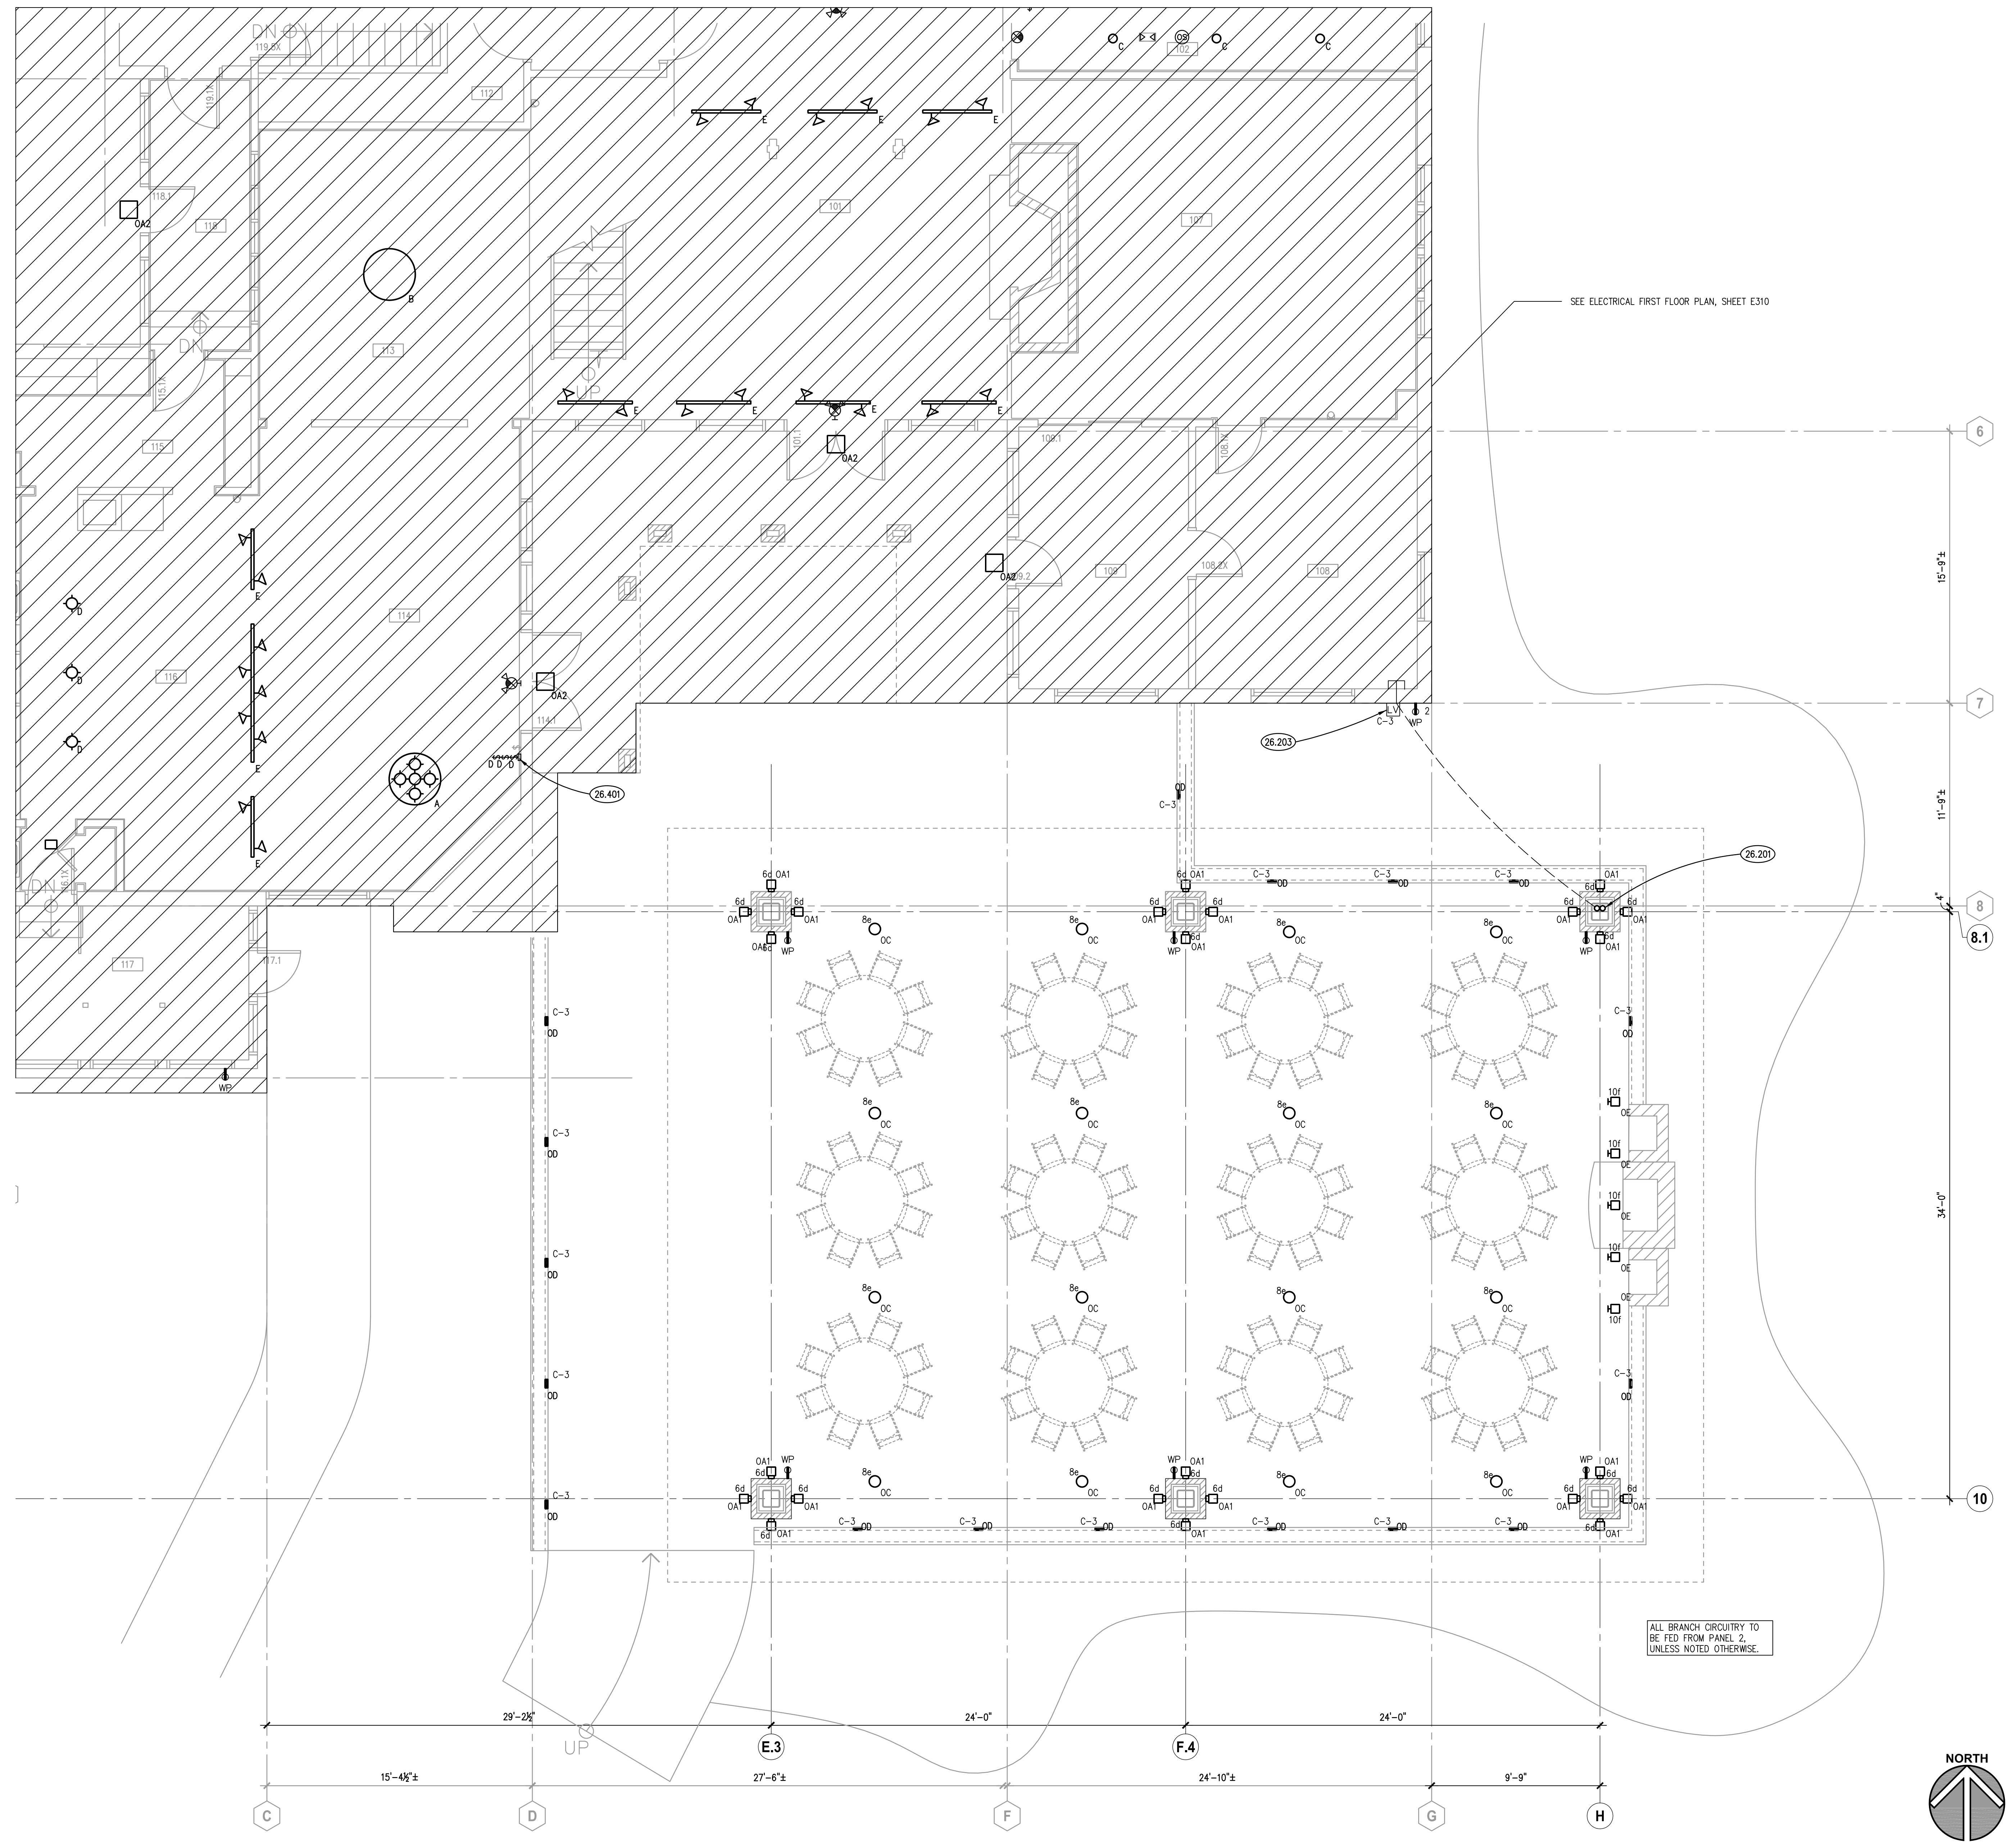

ELECTRICAL CANOPY & PATIO PLAN
 SCALE: 1/4" = 1'-0" **1**

GENERAL NOTES

1. REFER TO DRAWING G100 FOR PROJECT GENERAL NOTES.
2. INTENT OF DRAWINGS: THESE DRAWINGS ARE INTENDED TO RELAY TO CONTRACTOR A DESIGN INTENT. INCLUDE IN BID ALL LABOR AND MATERIALS NECESSARY FOR A COMPLETE AND OPERATIONAL SYSTEM AS REASONABLY INFERRABLE, AS DETERMINED BY ARCHITECT, TO ACCOMPLISH THE INTENT OF THESE DRAWINGS.
3. REFER TO ARCHITECTURAL, PLUMBING, AND MECHANICAL PLANS, SHOP DRAWINGS AND MANUFACTURERS INSTALLATION INSTRUCTIONS FOR ADDITIONAL INFORMATION ON EXACT POWER, WIRING & ROUGH-IN REQUIREMENTS AND LOCATIONS OF DEVICES.
4. UNLESS NOTED OTHERWISE, ALL HOMERUNS SHALL CONSIST OF A MAXIMUM OF 2 CIRCUITS (PHASE A & B, NEUTRAL & GROUND) IN 1/2" MINIMUM WIRE SIZE SHALL BE #12 AWG. WIRE SIZE FOR HOMERUN CIRCUITS SHALL BE 2#12, 1#12N & 1#12G.
5. SECURE ALL JUNCTION BOXES TO BUILDING STRUCTURE PER NEC REQUIREMENTS.

ISSUED	
REVISED	
DATE	
BY	
DESCRIPTION	


JOB NO.	19-429-1250
DRAWN	ATR
CHECKED	MTK
APPROVED	MTK
SHEET TITLE	ELECTRICAL CANOPY ALTERNATE 1 & PATIO PLAN
SHEET NUMBER	

KEYNOTES

KEYNOTES ARE TYPICALLY NOT DUPLICATED WITHIN A GIVEN DETAIL. AN UN-KEYNOTED ITEM IN A DETAIL IS THE SAME AS A KEYNOTED ITEM HAVING THE SAME APPEARANCE WITHIN THE SAME DETAIL.

26.202 FIELD VERIFY EXISTING LUMINAIRES' LAMP TYPE. PROVIDE NEW LED REPLACEMENT LAMP FOR RECESSED CAN LIGHTING.

26.400 UNLESS NOTED OTHERWISE - EXTEND EXISTING WIRING TO NEW LIGHTING FIXTURE AS REQUIRED TO ENSURE A COMPLETE AND OPERATIONAL SYSTEM.

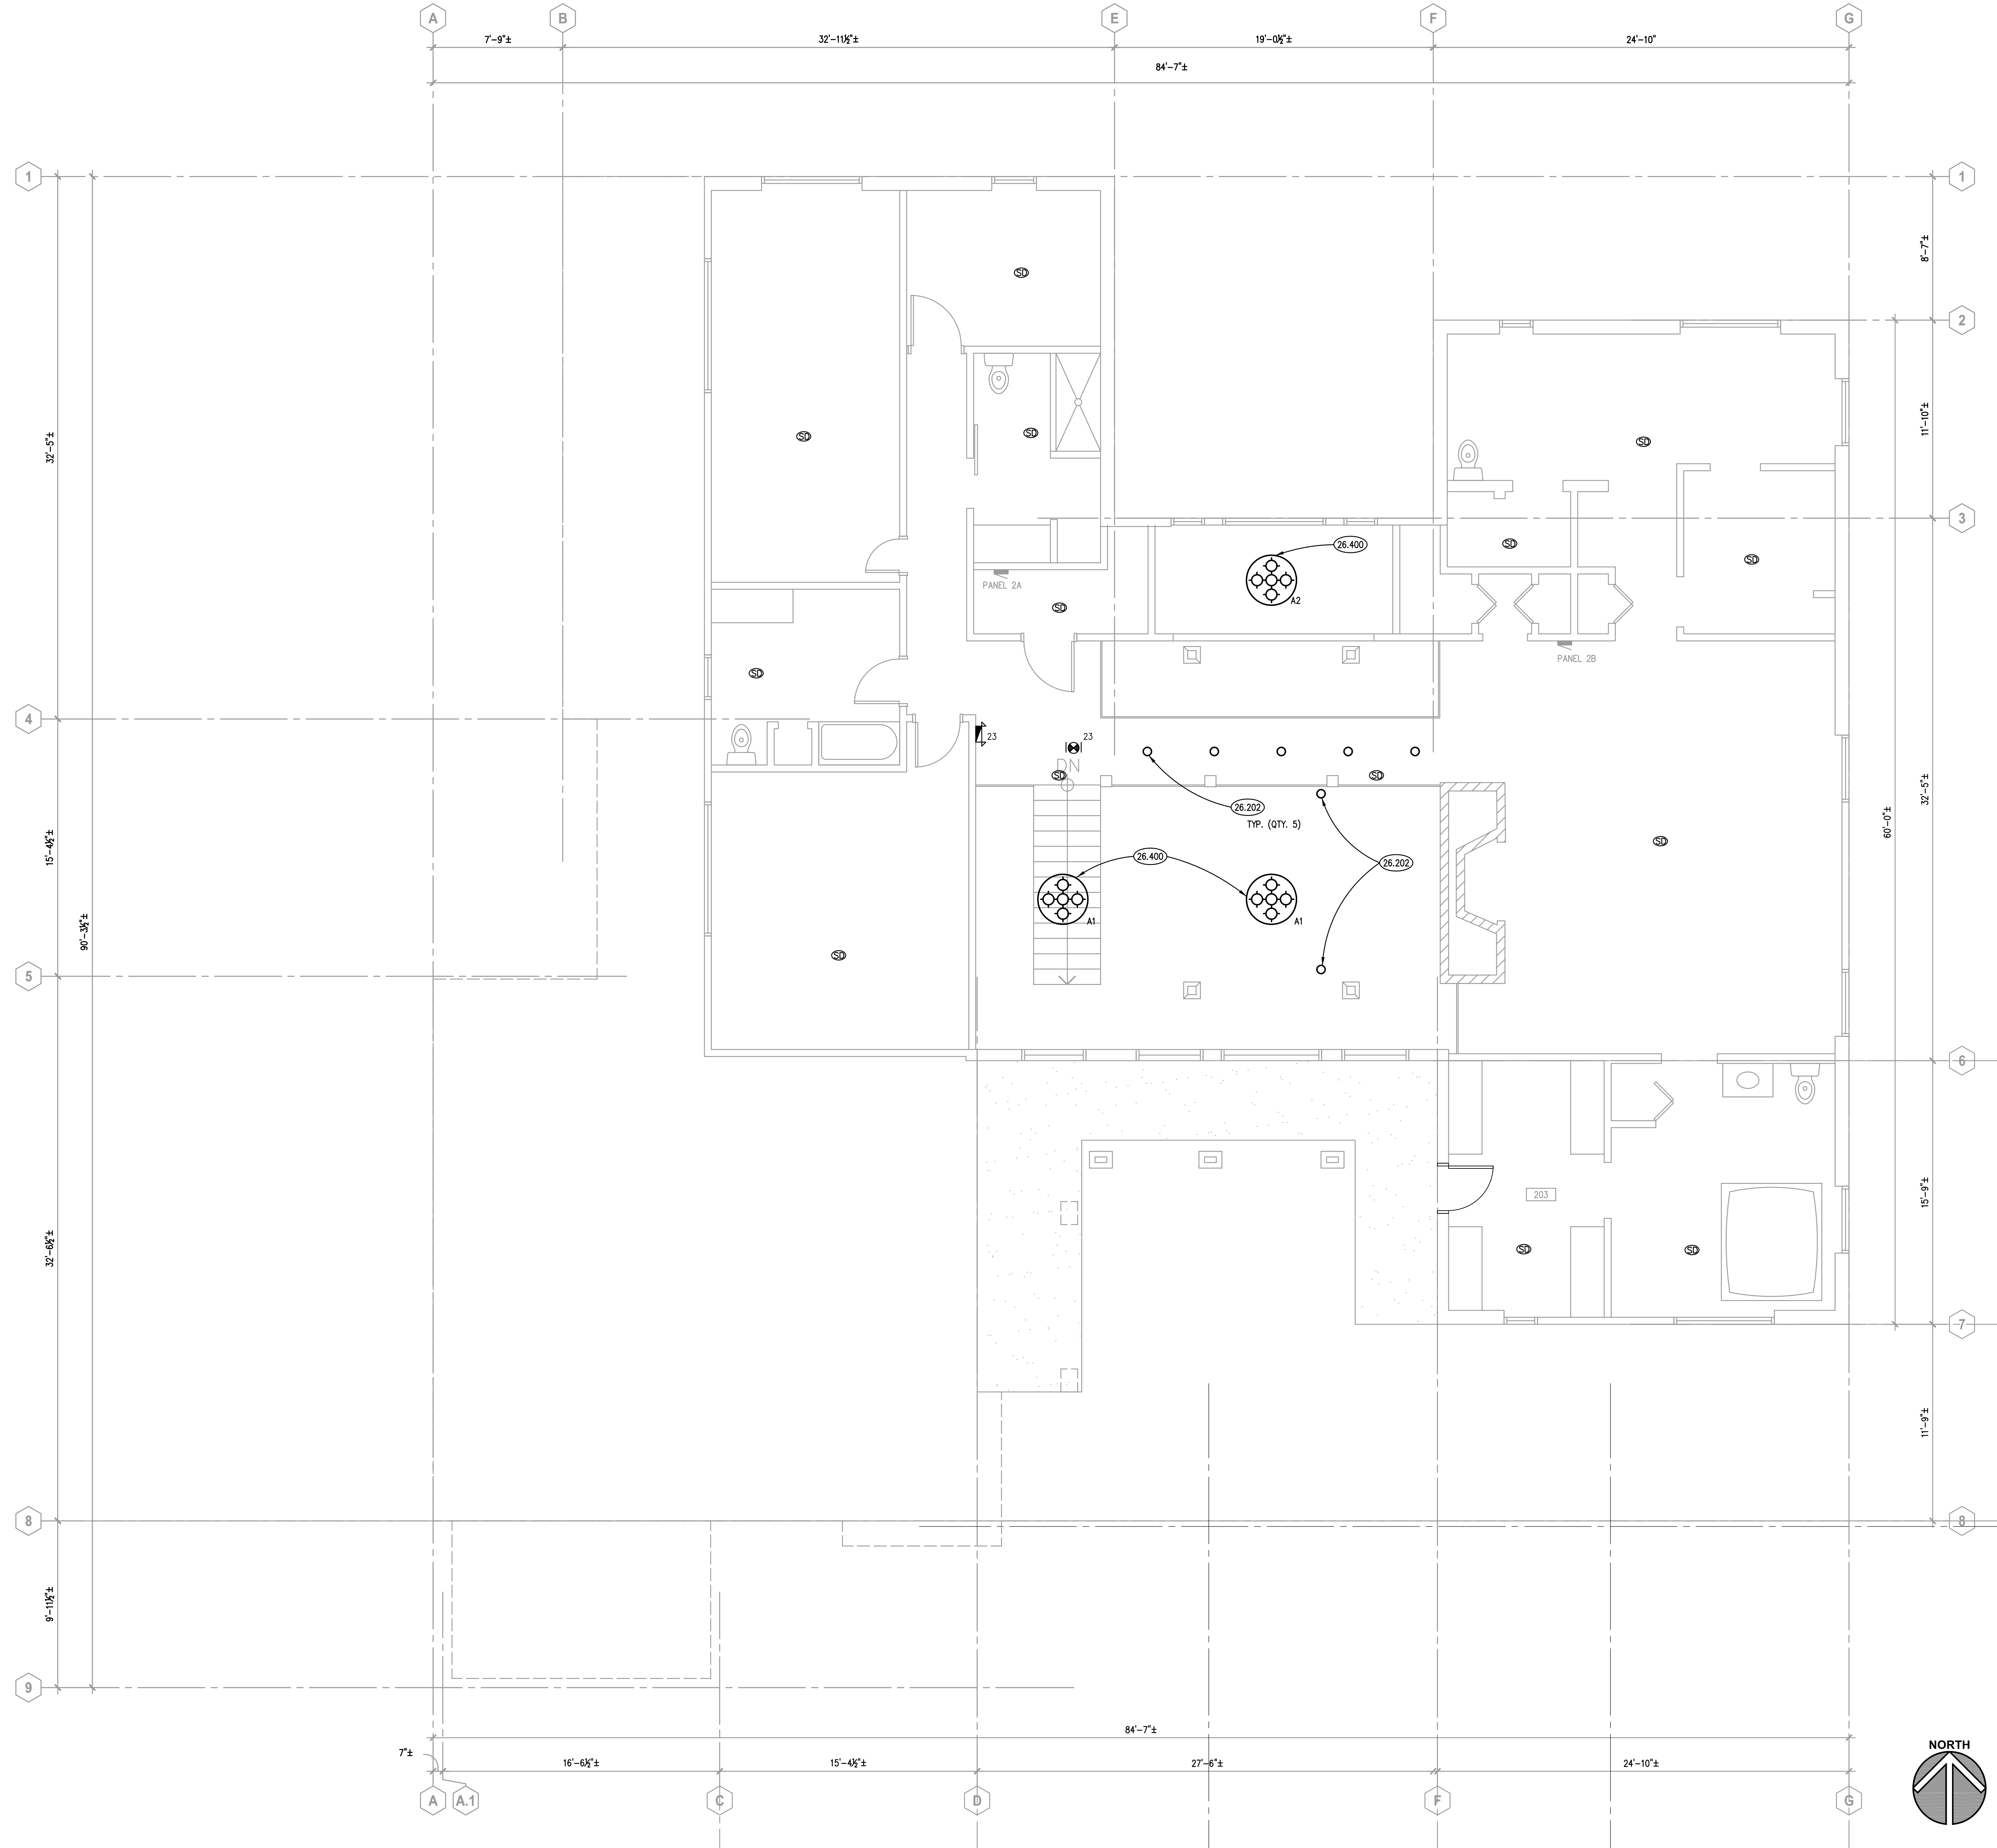

ROOM SCHEDULE

RM. NO.	ROOM NAME	RM. NO.	ROOM NAME
105	NOT USED	120	EXISTING STORAGE
106	NOT USED		
107	EXISTING LIVING ROOM		
108	EXISTING STORAGE		
109	EXISTING STORAGE		
110	EXISTING CORRIDOR	203.1	EXISTING CLOSET
111	EXISTING BATHROOM		
112	EXISTING JANITOR'S CLOSET		
113	EXISTING DINING ROOM		
114	EXISTING KEEPING ROOM		
115	EXISTING PANTRY		
116	EXISTING KITCHEN		
117	EXISTING GREEN HOUSE		
118	EXISTING FOYER		
119	EXISTING GARAGE		

GENERAL NOTES

1. REFER TO DRAWING G100 FOR PROJECT GENERAL NOTES.

SECOND FLOOR PLAN

SCALE: 1/4" = 1'-0"

ISSUED	
01/10/2021	BID DOCUMENTS

JOB NO.	19-429-1250
DRAWN	ATR
CHECKED	MTK
APPROVED	MTK

SHEET TITLE

ELECTRICAL
SECOND FLOOR PLAN

SHEET NUMBER

E320

KEYNOTES

KEYNOTES ARE TYPICALLY NOT DUPLICATED WITHIN A GIVEN DETAIL. AN UN-KEYNOTED ITEM IN A DETAIL IS THE SAME AS A KEYNOTED ITEM HAVING THE SAME APPEARANCE WITHIN THE SAME DETAIL.


- 23.203 PROVIDE ROOF TOP UNIT. PROVIDE CONNECTIONS TO EXISTING DUCTWORK. FIELD VERIFY BUILDING SUPPLY AND RETURN DUCT OPENINGS PRIOR MAKING THE CONNECTION.
- 23.204 FIELD VERIFY LOCATION OF EXISTING THERMOSTAT FOR ROOF TOP UNIT BEING REMOVED. REMOVE EXISTING THERMOSTAT AND PROVIDE NEW THERMOSTAT FOR NEW ROOF TOPS UNITS AT SAME LOCATION. REFER TO SPECIFICATIONS.

Kluber

Architects + Engineers

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Chicago, Illinois 60606
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KEN PICKERILL HOUSE RENOVATIONS
KENDALL COUNTY FOREST PRESERVE DISTRICT
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YORKVILLE, IL 60560

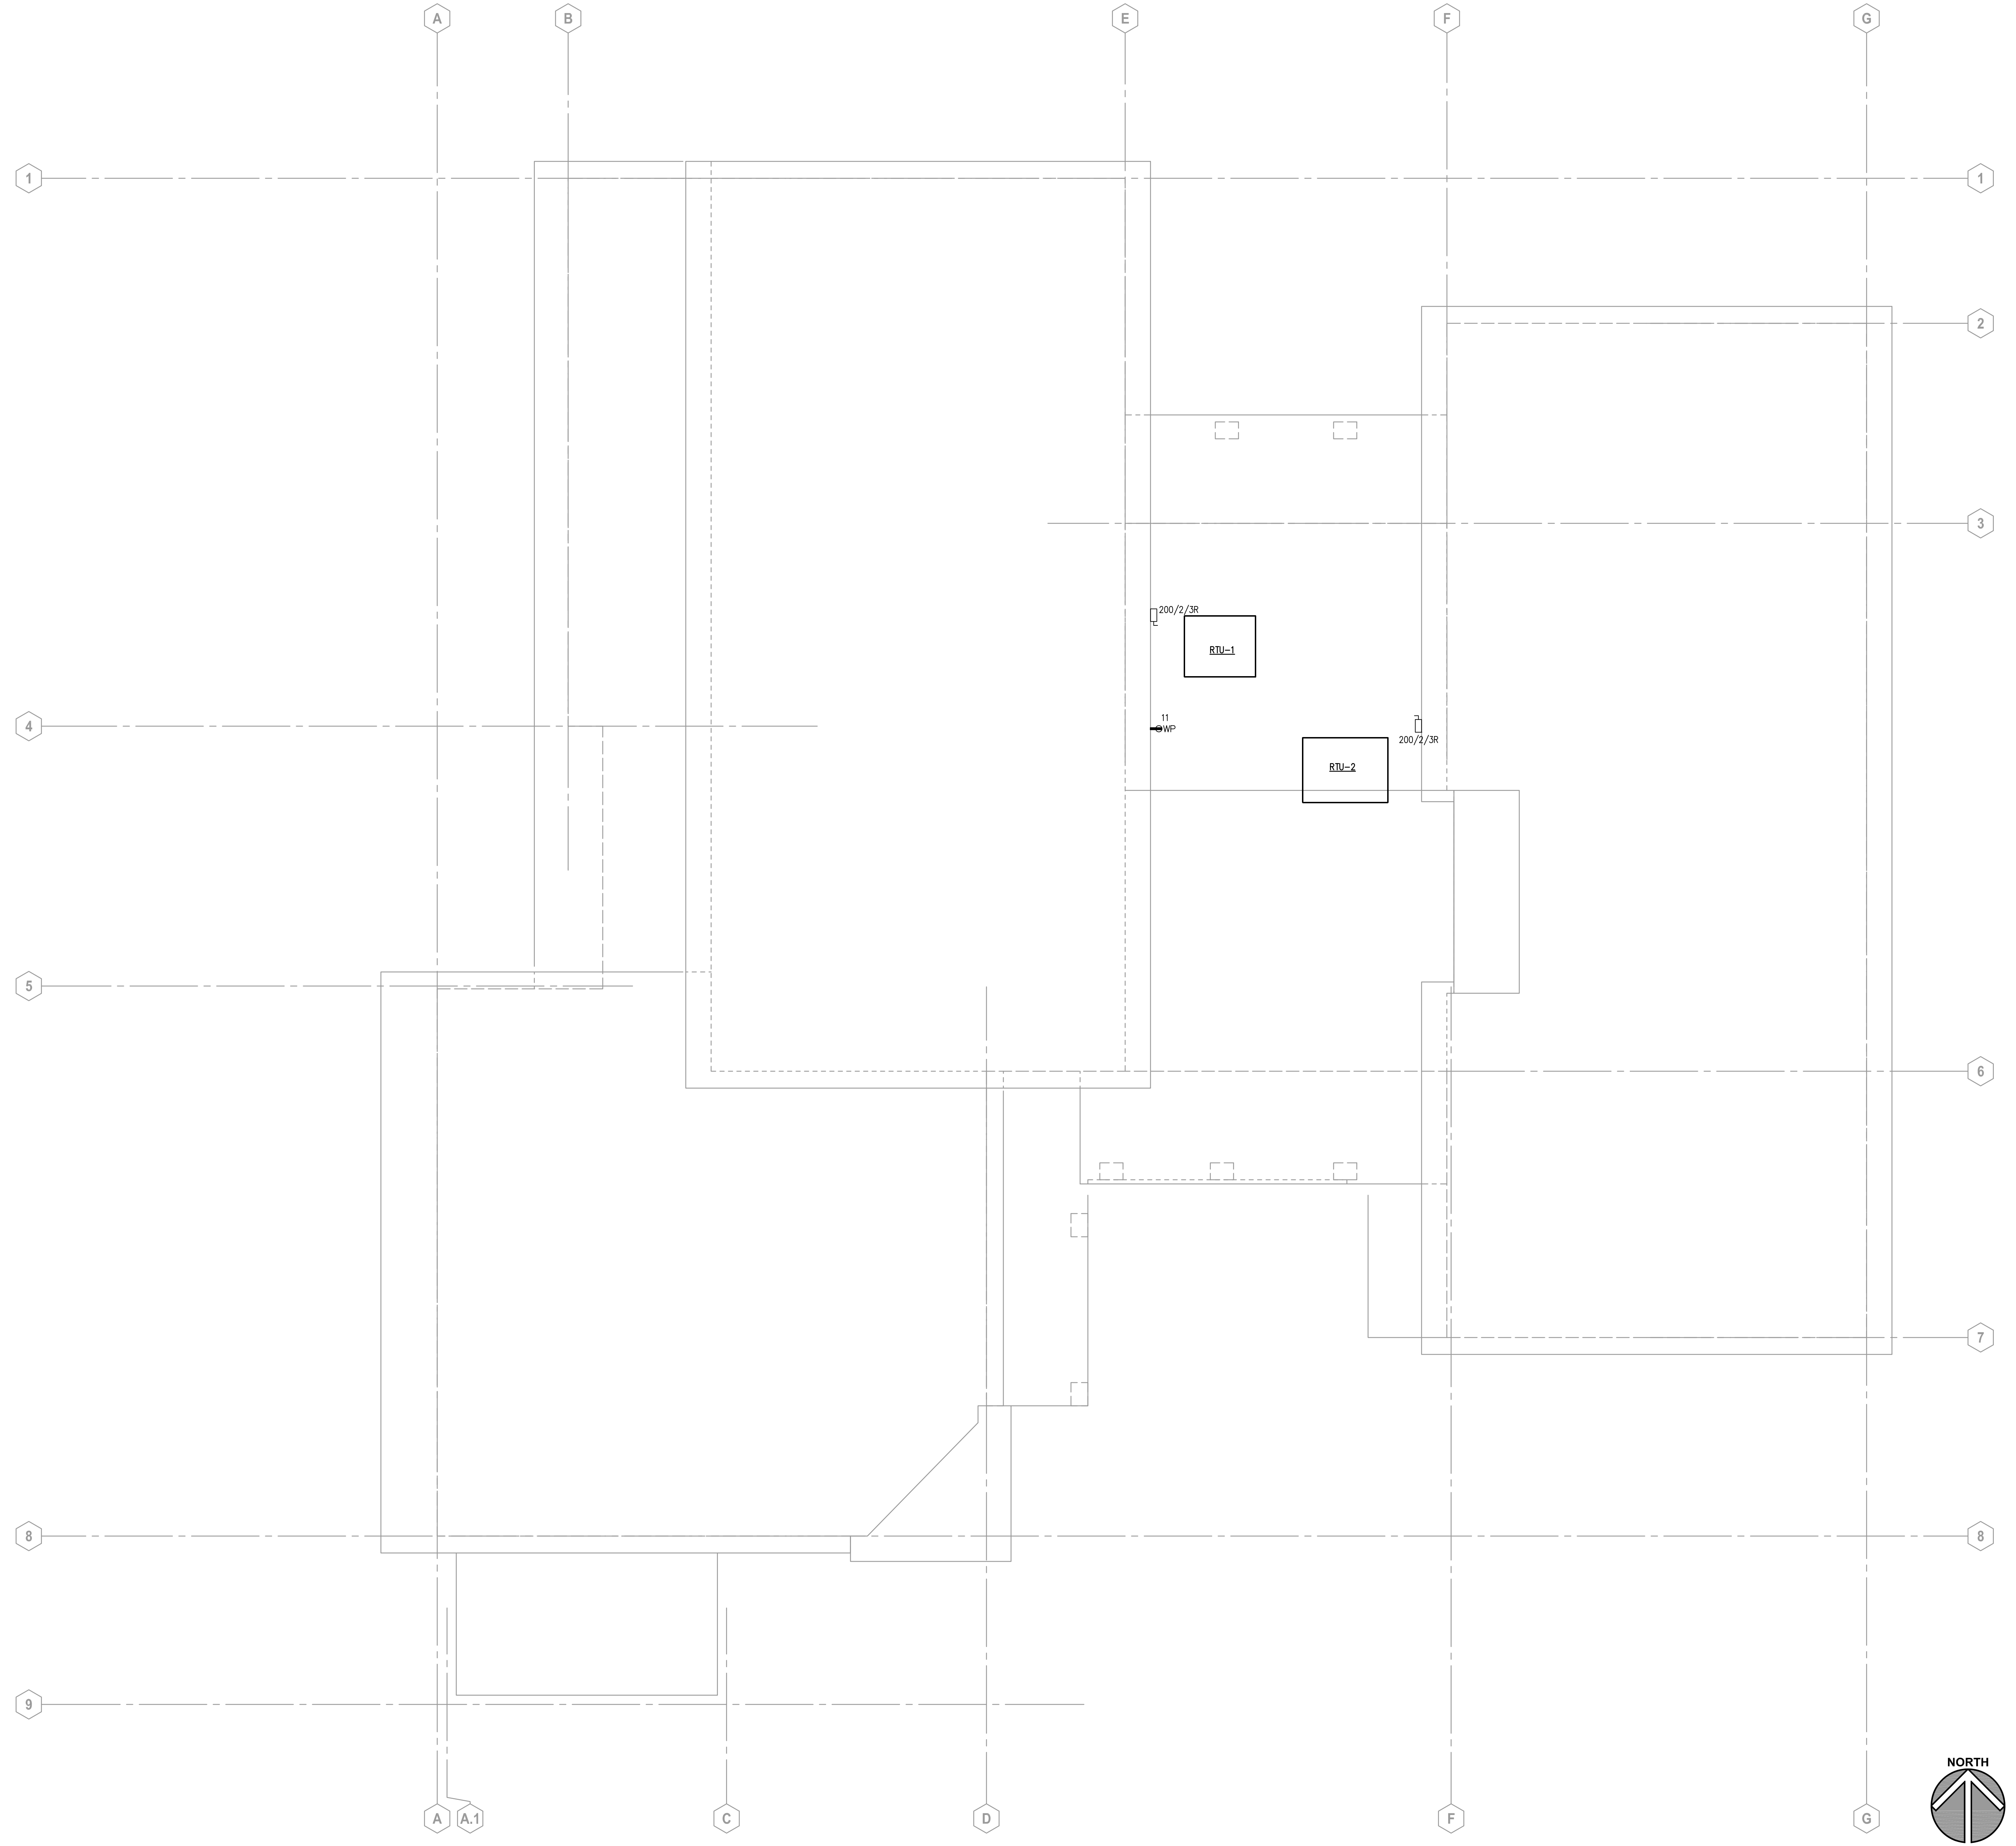

GENERAL NOTES

1. REFER TO DRAWING G100 FOR PROJECT GENERAL NOTES.
2. INTENT OF DRAWINGS: THESE DRAWINGS ARE INTENDED TO RELAY TO CONTRACTOR A DESIGN INTENT. INCLUDE IN BID ALL LABOR AND MATERIALS NECESSARY FOR A COMPLETE AND OPERATIONAL SYSTEM AS REASONABLY INFERRABLE, AS DETERMINED BY ARCHITECT, TO ACCOMPLISH THE INTENT OF THESE DRAWINGS.
3. REFER TO ARCHITECTURAL, PLUMBING, AND MECHANICAL PLANS, SHOP DRAWINGS AND MANUFACTURERS INSTALLATION INSTRUCTIONS FOR ADDITIONAL INFORMATION ON EXACT POWER, WIRING & ROUGH-IN REQUIREMENTS AND LOCATIONS OF DEVICES.
4. UNLESS NOTED OTHERWISE, ALL HOMERUNS SHALL CONSIST OF A MAXIMUM OF 2 CIRCUITS (PHASE A & B, NEUTRAL & GROUND) IN 1/2" MINIMUM WIRE SIZE SHALL BE #12 AWG. WIRE SIZE FOR HOMERUN CIRCUITS SHALL BE 2#12, 1#12N & 1#12G.
5. SECURE ALL JUNCTION BOXES TO BUILDING STRUCTURE PER NEC REQUIREMENTS.

ISSUED	
BID DOCUMENTS	
01/09/22	


JOB NO.	19-429-1250
DRAWN	ATR
CHECKED	MTK
APPROVED	MTK

SHEET TITLE
ELECTRICAL ROOF PLAN


SHEET NUMBER
E330

ELECTRICAL ROOF PLAN 1


SCALE: 1/4" = 1'-0"

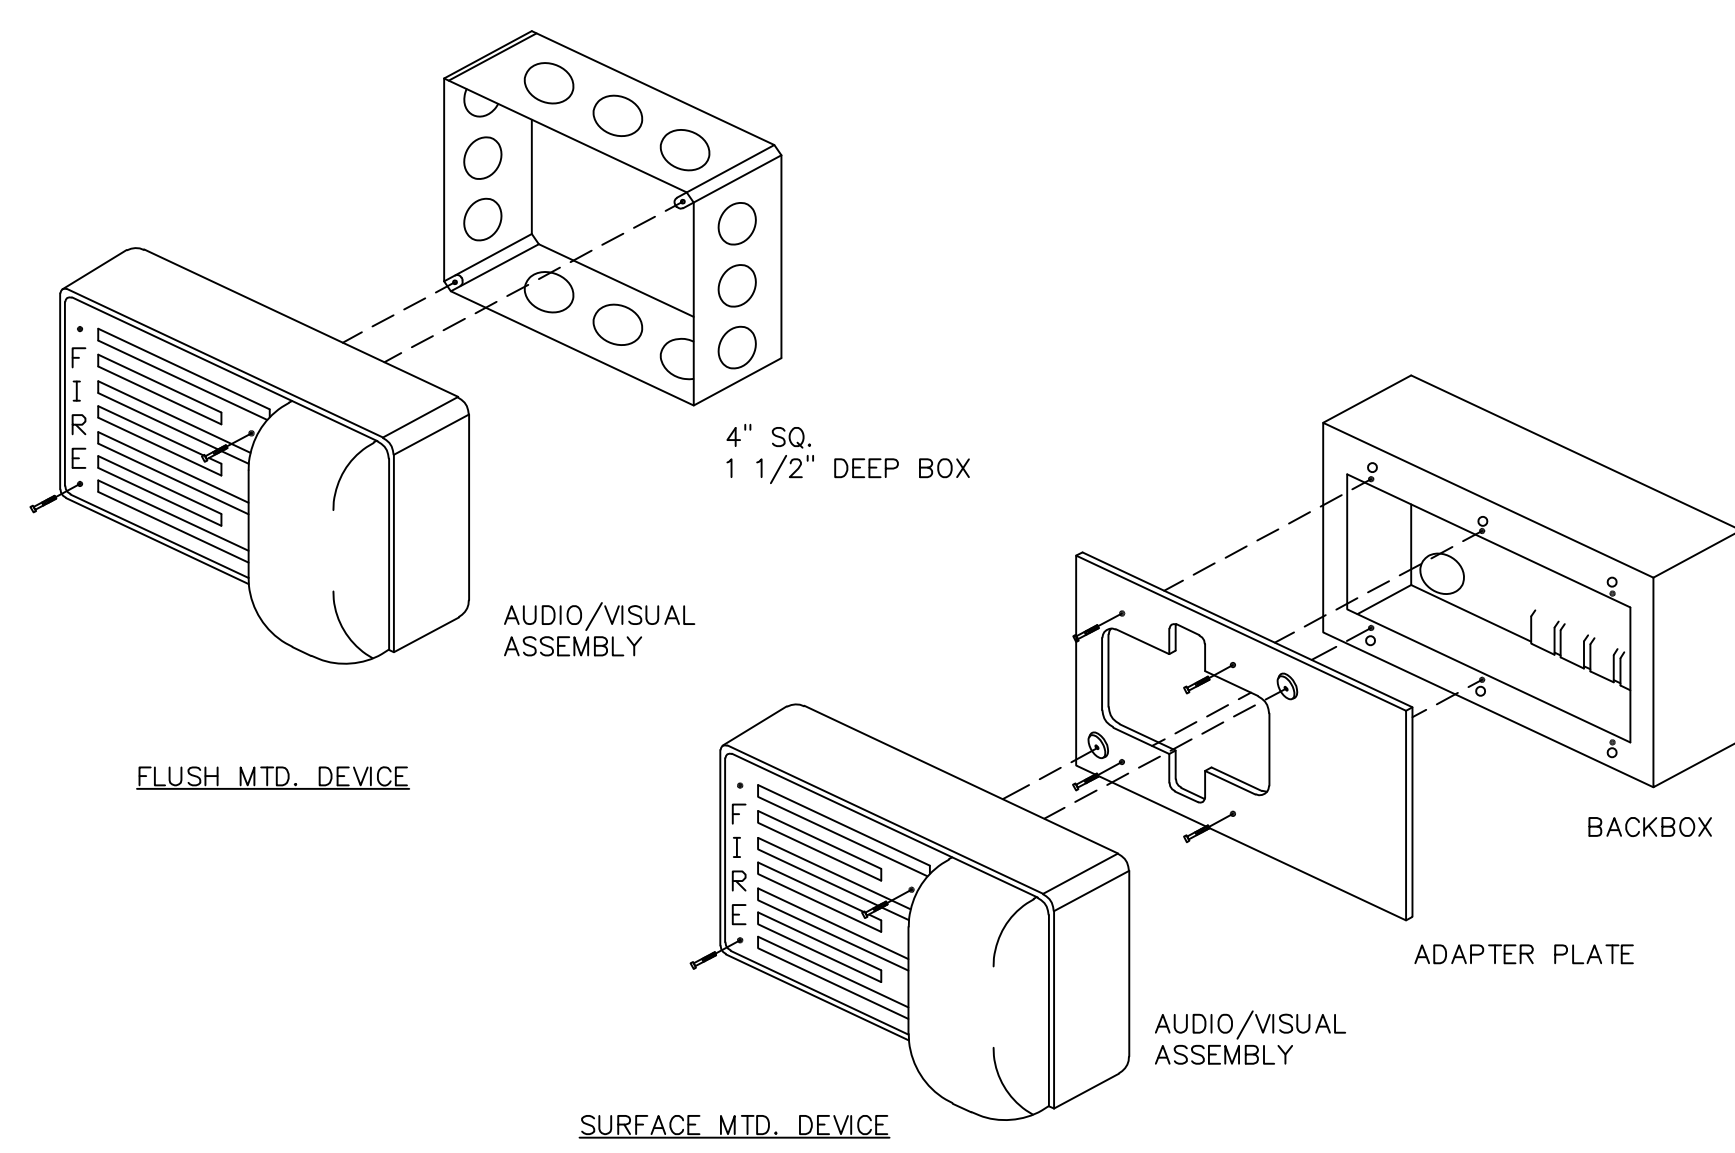

A/V MOUNTING DETAIL
SCALE: N.T.S. **6**

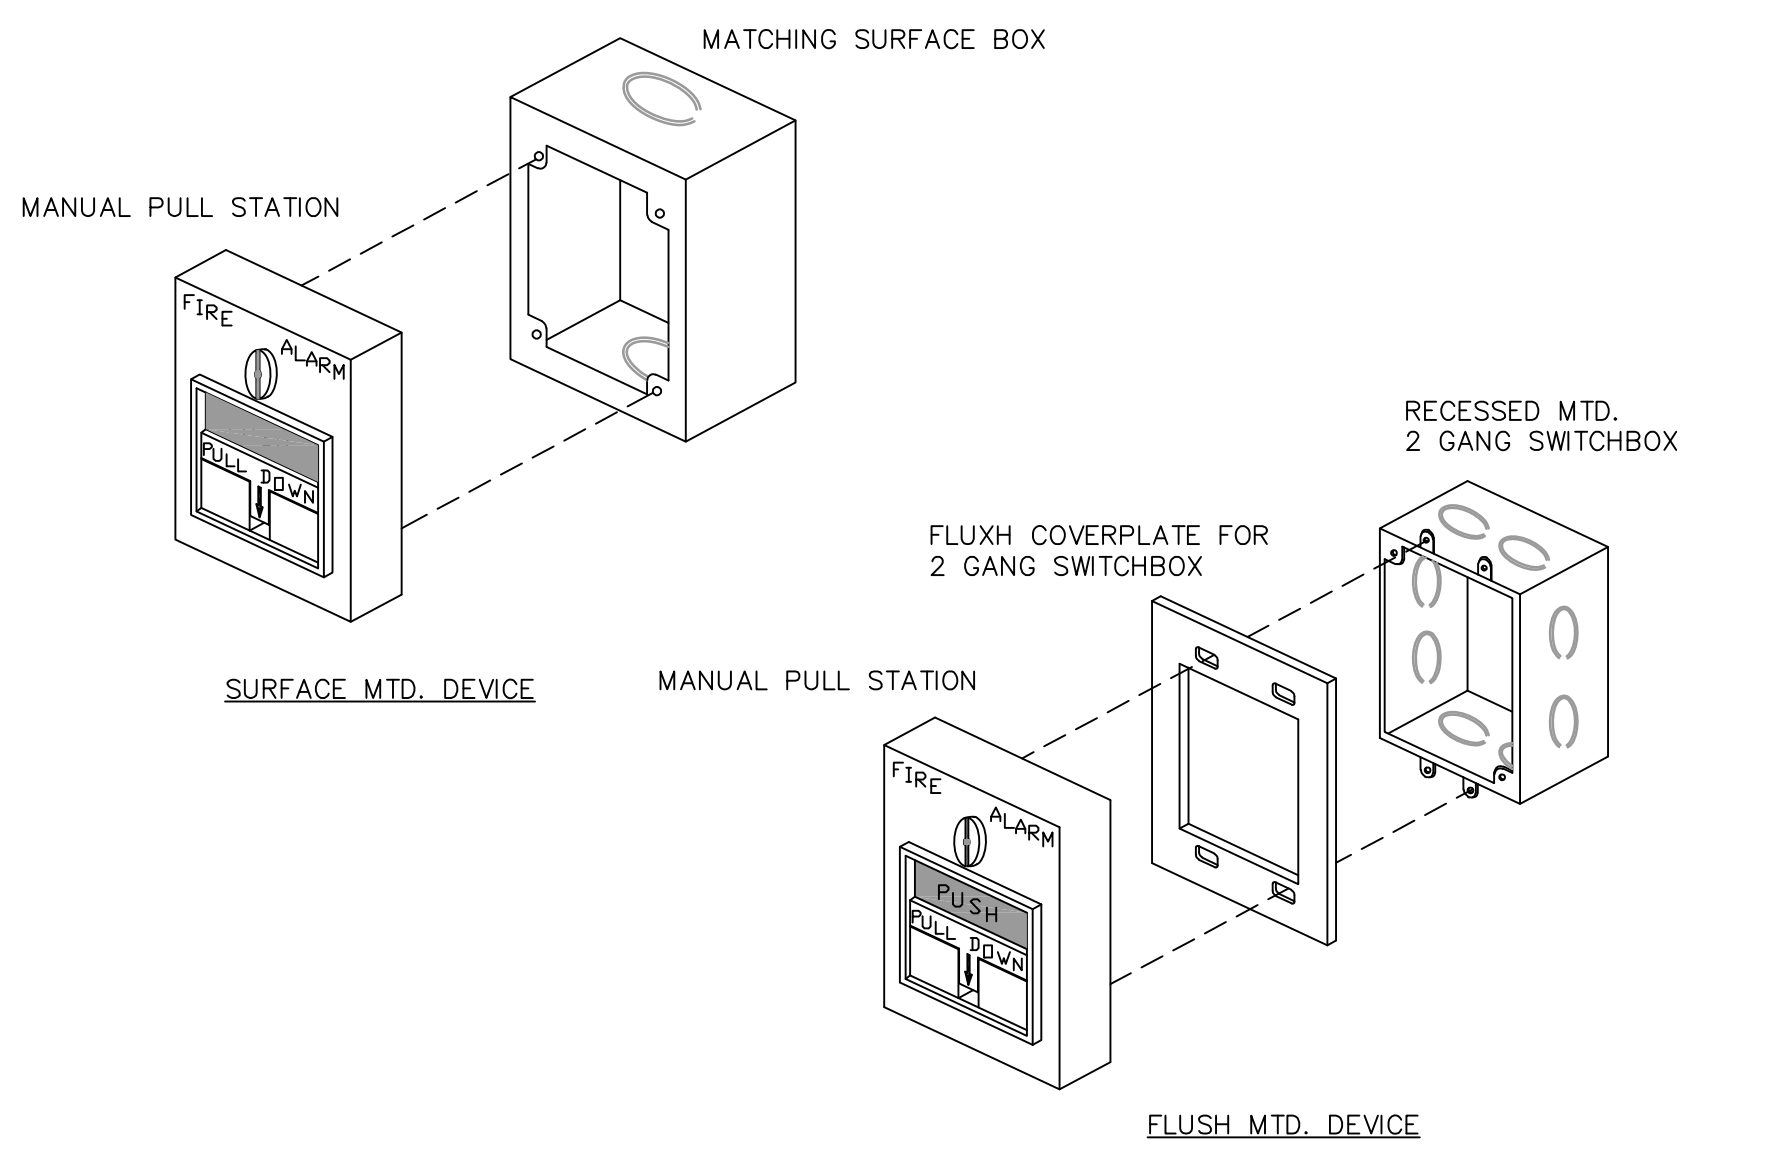

PULL STATION MOUNTING DETAIL
SCALE: N.T.S. **5**

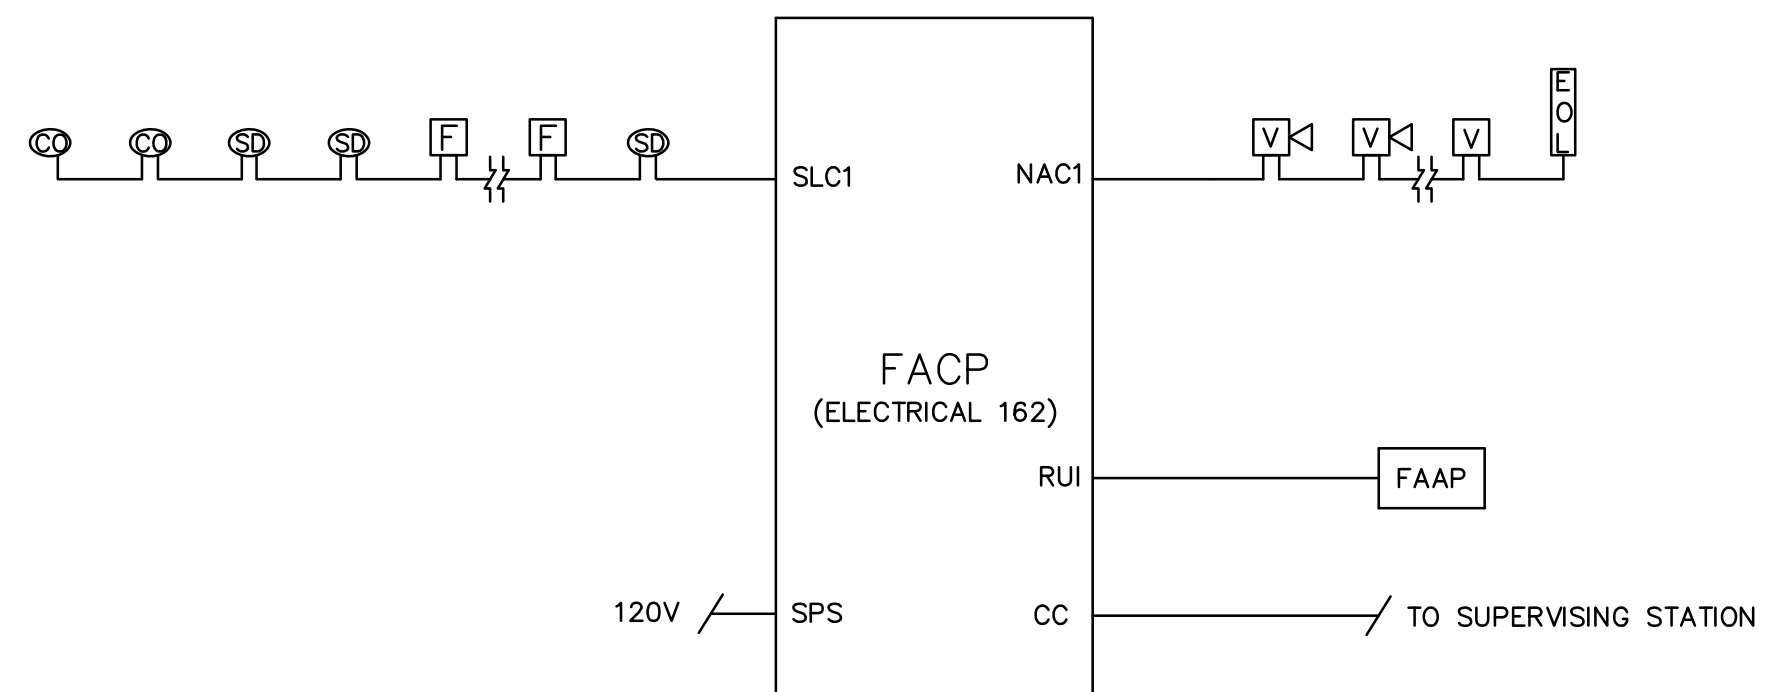

NOTE:

- INDICATED QUANTITIES ARE NOT EXACT AND ARE NOT TO BE USED FOR ESTIMATING PURPOSES. DEVICE QUANTITIES AND LOCATIONS ARE INDICATED ON THE FLOOR PLAN DRAWINGS. WHERE A CONFLICT EXISTS BETWEEN THESE QUANTITIES AND THE FLOOR PLAN QUANTITIES, THE HIGHER QUANTITY SHALL BE REQUIRED.
- ROUTE ALL CABLING TO DESIGNATED ELECTRICAL CLOSETS. NEATLY TRAIN AND MAKE CABLE TERMINATIONS AT ELECTRICAL CLOSETS. HOMERUN ALL CABLES FROM DESIGNATED ELECTRICAL CLOSETS. LOCATE ALL FIELD EQUIPMENT IN DESIGNATED ELECTRICAL CLOSETS.
- NAC PANELS SERVING SIMILAR AREAS SHALL HAVE ALL VISUALS SYNCHRONIZED.

FIRE ALARM RISER DIAGRAM
SCALE: N.T.S. **3**

PANEL : C (EXISTING) 60 AMP MAIN LUG ONLY

CKT. NO.	BRKR	DESCRIPTION	PHASE		DESCRIPTION	BRKR	CKT. NO.
			A	B			
1	1P30	PAVILION LIGHTS & OUTLETS			PAVILION LIGHTS & OUTLETS	1P30	2
3	-	-			-	-	4
5	-	-			-	-	6

NOTES: MOUNTING: SURFACE VOLTAGE (LN): 120 RATING: 10000 AIC VOLTAGE (LL): 240 ENCLOSURE: NEMA 1 PHASE: 1 FED FROM: PANEL A-6/8 WIRE: 3 FEEDER SIZE: EXISTING LOCATION: WEST BASEMENT EXISTING PANELBOARD TO REMAIN

PANEL : C (EXISTING) 60 AMP MAIN LUG ONLY

CKT. NO.	BRKR	DESCRIPTION	PHASE		DESCRIPTION	BRKR	CKT. NO.
			A	B			
1	1P30	PAVILION LIGHTS & OUTLETS			PAVILION LIGHTS & OUTLETS	1P30	2
3	1P20	SITE BOLLARD LIGHTS, HARDSCAPE LIGHTS		360	RECEPTACLE - LANDSCAPE WEST	1P20	4
5	1P20	CANOPY LIGHTING		406.6	-	-	6

NOTES: MOUNTING: SURFACE VOLTAGE (LN): 120 RATING: 10000 AIC VOLTAGE (LL): 240 ENCLOSURE: NEMA 1 PHASE: 1 FED FROM: PANEL A-6/8 WIRE: 3 FEEDER SIZE: EXISTING LOCATION: WEST BASEMENT EXISTING PANELBOARD TO REMAIN

PANEL : MDP 600 AMP MAIN BREAKER

CKT. NO.	BRKR	DESCRIPTION	PHASE		DESCRIPTION	BRKR	CKT. NO.
			A	B			
1	2P225	PANEL 1			PANEL A	2P200	2
3	/	/			/	/	4
5	2P200	DISCONNECT D1		2423.9	PANEL 2	2P100	6
7	/	/		3194	/	/	8
9	2P150	RTU-1		14718	RTU-2	2P150	10
11	/	/		14718	/	/	12
13	2P30	EW4-1		2500	EW4-2	2P30	14
15	/	/		2500	/	/	16
17	2P40	DISCONNECT D2		E	DISCONNECT D3 - WELL PUMP	2P30	18
19	/	/		E	/	/	20
21	2P200	PANEL 2A		E	-	-	22
23	/	/		E	-	-	24
25	-	-		0	-	-	26
27	-	-		0	-	-	28
29	-	-		0	-	-	30
31	-	-		0	-	-	32
33	-	-		0	-	-	34
35	-	-		0	-	-	36
37	-	-		0	-	-	38
39	-	-		0	-	-	40

NOTES: MOUNTING: SURFACE VOLTAGE (LN): 120 RATING: 22000 VOLTAGE (LL): 240 ENCLOSURE: NEMA 1 PHASE: 1 FED FROM: MAIN DISCONNECT WIRE: 3 FEEDER SIZE: 3 SETS 350CMIL 300.2 1/2" C LOCATION: EAST BASEMENT NEW PANELBOARD SERVICE ENTRANCE RATED

PANEL : 2 100 AMP MAIN LUG ONLY

CKT. NO.	BRKR	DESCRIPTION	PHASE		DESCRIPTION	BRKR	CKT. NO.
			A	B			
1	1P20	RESTROOM - LIGHTING EXHAUST FANS, RECEPTACLE		1021	RECEPTACLE - LANDSCAPE EAST	1P20	2
3	1P20	ELECTRIC WATER COOLER		1080	RECEPTACLE - CANOPY	1P20	4
5	1P20	HWRP-1		717.6	LIGHTING - CANOPY	1P20	6
7	1P20	RECEPTACLE - PANEL		28	LIGHTING - CANOPY	1P20	8
9	1P20	LIGHTING - VESTIBULE		180	LIGHTING - CANOPY	1P20	10
11	1P20	RECEPTACLE - ROOFTOP		87	-	-	12
13	1P20	SPARE		180	SPARE	1P20	14
15	1P20	SPARE		-	SPARE	1P20	16
17	-	-		-	-	-	18
19	-	-		-	-	-	20
21	-	-		-	-	-	22
23	1P20	EXIT SIGNS		250	FACP	1P20	24

NOTES: MOUNTING: SURFACE VOLTAGE (LN): 120 RATING: 10000 AIC VOLTAGE (LL): 240 ENCLOSURE: NEMA 1 PHASE: 1 FED FROM: MDP WIRE: 3 FEEDER SIZE: 3/8" BGC 1" C LOCATION: EAST BASEMENT NEW PANELBOARD

SCOPE OF WORK: DIRECT REPLACEMENT OF ROOFTOP UNIT EQUIPMENT WITH ELECTRIC HEAT, ELECTRIC WATER HEATERS, WORKCAST REMODEL WITH ADDITION OF TWO TOILET ROOMS, DIRECT LIGHTING REPLACEMENT THROUGHOUT FIRST FLOOR, ADDITION OF FIRE ALARM SYSTEM WITH FULL SMOKE DETECTION.

ALTERNATE NO. 1: NEW EXTERIOR CANOPY WITH NEW LED LIGHTING, RECEPTACLES AND PROVISIONS FOR FUTURE SOLAR PV.

NOTE: THIS RENOVATION RESULTS IN MINIMAL ADDITIONAL NEW LOAD, NOMINALLY 20 AMPERES.

PANEL : 1 (EXISTING) 225 AMP MAIN BREAKER

CKT. NO.	BRKR	DESCRIPTION	PHASE		DESCRIPTION	BRKR	CKT. NO.
			A	B			
1	2P30	WATER HEATER			SPARE	2P30	2
3	/	/			/	/	4
5	2PXX	DRYER			ELECTRIC HEAT	2P20	6
7	/	/			/	/	8
9	2P40	HEAT PUMP			EXISTING	1P20	10
11	/	/			EXISTING	1P20	12
13	2P60	EXISTING			EXISTING	1P20	14
15	/	/			EXISTING	1P15	16
17	2P100	ELECTRIC HEAT/FURNACE			EXISTING	1P20	18
19	/	/			OUTSIDE RECEPTACLE BASEMENT REC	1P20	20

NOTES: MOUNTING: SURFACE VOLTAGE (LN): 120 RATING: 10000 AIC VOLTAGE (LL): 240 ENCLOSURE: NEMA 1 PHASE: 1 FED FROM: MAIN DISCONNECT WIRE: 3 FEEDER SIZE: EXISTING LOCATION: WEST BASEMENT EXISTING PANELBOARD TO REMAIN

PANEL : 1 (EXISTING) 225 AMP MAIN BREAKER

CKT. NO.	BRKR	DESCRIPTION	PHASE		DESCRIPTION	BRKR	CKT. NO.
			A	B			
1	2P30	SPARE			SPARE	2P30	2
3	/	/			/	/	4
5	2PXX	DRYER			ELECTRIC HEAT	2P20	6
7	/	/			/	/	8
9	2P40	HEAT PUMP			EXISTING	1P20	10
11	/	/			EXISTING	1P20	12
13	2P60	EXISTING			EXISTING	1P20	14
15	/	/			EXISTING	1P15	16
17	2P100	ELECTRIC HEAT/FURNACE			EXISTING	1P20	18
19	/	/			OUTSIDE RECEPTACLE BASEMENT REC	1P20	20

NOTES: MOUNTING: SURFACE VOLTAGE (LN): 120 RATING: 10000 AIC VOLTAGE (LL): 240 ENCLOSURE: NEMA 1 PHASE: 1 FED FROM: MAIN DISCONNECT WIRE: 3 FEEDER SIZE: EXISTING LOCATION: WEST BASEMENT EXISTING PANELBOARD TO REMAIN

EXTERIOR LUMINAIRE SCHEDULE - BASIS OF DESIGN

TYPE	DESCRIPTION	MFR.	CATALOG NUMBER	VOLTAGE	SHIELDING	FINISH	MOUNTING	NOTE
OA1	LED WALL SCENCE UP/DOWN	TECH LIGHTING	700OWTEG 830 18 NN C Z UD UNV PC	120	N/A	DARK BRONZE	SURFACE (WALL)	
OA2	LED WALL SCENCE DOWNLIGHT	TECH LIGHTING	700OWTEG 830 18 W C Z DO UNV PC	120	N/A	DARK BRONZE	SURFACE (WALL)	
OB	LED BOLLARD	FC LIGHTING	FCBT690 UNV 42 3K 14L BZ LD	120	N/A	DARK BRONZE	BOLLARD 42"	
OC	LED RECESSED CAN W/ SLOPED CEILING ADAPTER	INDY LIGHTING	LB 75LM 30K 120 G4 90CRI ZT W' INSA8/15 SLOPED CEILING ADAPTER	120	N/A	WHITE	RECESSED (SLOPED CEILING)	
OD	LED HARDSCAPE LIGHT	VISTA OUTDOOR LIGHTING	SL 4263 DZ W LB2ND W/ vPRO2 TRANSFORMER	SEE NOTE 1	N/A	DARK BRONZE	RECESSED (WALL)	1
OE	LED SPOT LIGHT	VISTA OUTDOOR LIGHTING	1057-DZ-MF-30-D-MV-010-BD	120	BARN DOOR ACCESSORY	DARK BRONZE	STEM	

Notes: 1. PROVIDE LOW VOLTAGE TRANSFORMER (PRIMARY VOLTAGE: 120V, SECONDARY VOLTAGE: 15V, 75WATT) BY LIGHTING MANUFACTURER.

INTERIOR LUMINAIRE SCHEDULE - BASIS OF DESIGN

TYPE	DESCRIPTION	MFR.	CATALOG NUMBER	VOLTAGE	SHIELDING	FINISH	MOUNTING	NOTE
A1	LED LINEAR CLUSTER PENDANT	SPI LIGHTING	SIP12200 L19WPT11 120-277V 3000K (5) 14W-45 DF_MAO1 PSS OAH-6'	UNV (120V)	N/A	BLACK	SUSPENDED	
A2	LED LINEAR CLUSTER PENDANT	SPI LIGHTING	SIP12200 L19WPT11 120-277V 3000K No DL DF_MAO1 PSS OAH-6'	UNV (120V)	N/A	BLACK	SUSPENDED	
B	LED SURFACE MOUNT DRUM	SPI LIGHTING	AIC11866 L100WPT11 120-277V 3000K H07.5 FB00	UNV (120V)	N/A	BLACK	SUSPENDED	
C	LED RECESSED CAN	PRESCOLITE	LTR-6RD-ML-30L-DM1-LTR-6RD-T-ML30K8WD-SSWCWT	UNV (120V)	N/A	WHITE	RECESSED (CEILING)	
D	LED PENDANT	SPI LIGHTING	SIP12125 L23W PT11 120-277V 3000K 14W-45 DF_MAO01 PSS	UNV (120V)	N/A	BLACK	SUSPENDED	
E	LED TRACK LIGHTING	PROGRESS LIGHTING	P9202-31 W/ 250 PAR 38 LED LAMP	UNV (120V)	N/A	BLACK	SURFACE (TRACK)	
F	LED LINEAR WALL MOUNT	SPI LIGHTING	SIW12169 4FT-L14WPT32 120-277V 3000K DF_MAO1 REC	UNV (120V)	N/A	BLACK	SURFACE (WALL)	
EM	SELF-CONTAINED LED BATTERY LIGHT	DUAL LITE	EV SERIES	120V	N/A	BLACK	WALL	
EM-C	SELF-CONTAINED LED BATTERY LIGHT	DUAL LITE	EV4R SERIES	120V	N/A	WHITE	CEILING	
EX	SELF-CONTAINED LED EXIT SIGN, NICAD BATTERY	DUAL LITE	EVE SERIES	120V	N/A	BLACK	AS INDICATED ON	
EXEM	SELF-CONTAINED LED EXIT SIGN, NICAD BATTERY	DUAL LITE	EVC SERIES	120V	N/A	BLACK	AS INDICATED ON	

Notes:

LUMINAIRE SCHEDULES
SCALE: N.T.S. **2**

HVAC/PLUMBING EQUIPMENT SCHEDULE

NO.	DESCRIPTION	FLA	KW	HP	VOL	PH	DISC. FURN BY	STARTER		CIRCUIT WIRING	NOTE
								TYPE	BY		
RTU-1	ROOFTOP UNIT	124	-	-	240	1	EC	UNIT	MFR	EXISTING TO REMAIN	
RTU-2	ROOFTOP UNIT	133	-	-	240	1	EC	UNIT	MFR	EXISTING TO REMAIN	
EF-1	EXHAUST FAN	1.8	-	-	120	1	PLUG	-	UNIT	2#12.#12G.1/2"C	
EW4-1	ELECTRIC WATER HEATER	-	5	-	240	1	EC	N/A	N/A	2#12.#12G.1/2"C	
EW4-2	ELECTRIC WATER HEATER	-	4.5	-	240	1	EC	N/A	N/A	2#12.#12G.1/2"C	
HWRP-1	HOT WATER RECIRCULATION PUMP	-	-	F	120	1	PLUG	-	UNIT	2#12.#12G.1/2"C	

NOTES:

HVAC/PLUMBING EQUIPMENT SCHEDULE
SCALE: N.T.S. **1**

PANEL SCHEDULES
SCALE: N.T.S. **4**

PANEL SCHEDULES
SCALE: N.T.S. **4**

REVISIONS

NO.	DESCRIPTION	DATE

JOB NO. 19-429-1250
DRAWN ATR
CHECKED MTK
APPROVED MTK

SHEET TITLE
ELECTRICAL SCHEDULES & DETAILS

SHEET NUMBER
E620