



# Kendall County Agenda Briefing

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**Meeting Type:** Other Committee  
**Meeting Date:** 6/18/2024  
**Subject:** Approval of Petition 24-15, Stormwater Ordinance Variance for Subat Forest Preserve  
**Prepared by:** Matthew H. Asselmeier, AICP, CFM  
**Department:** Planning, Building and Zoning

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**Action Requested:**

Approval of Petition 24-15, A Request from the Kendall County Forest Preserve District for a Variance to Section 203 of the Kendall County Stormwater Management Ordinance Regarding Applicability of Site Runoff Storage Requirements at the Subat Forest Preserve Located at 4845 Eldamain Road, Plano (PINs: 01-25-400-009, 01-36-200-022, and 01-36-200-025) in Little Rock Township

**Previous Board/Committee Review:**

N/A

**Fiscal impact:**

N/A

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**Background and Discussion:**

The Petitioner requests a variance that allows exclusion of the impervious trail sections of the Subat Forest Preserve Nature Center Project in the calculation of total impervious improvements resulting in no stormwater detention requirement for the project. The Petitioner requests a variance from site runoff storage requirements to avoid unnecessary disturbance of restored prairie habitats and native trees that reside within Subat Forest Preserve.

Per the application, “the project has an impervious area of 36,850 sf. Under current project conditions, the Ordinance requires detention for developments resulting in an impervious area of greater than 32,000 sf. The trail section of the project constitutes 19,930 sf of impervious area or approximately 54% of the total impervious area of the project.”

Greg Chismark, from WBK Engineering, reviewed the proposal and recommended approval. As of the date this memo, the four (4) outstanding items noted in Greg Chismark’s letter that needed to be resolved in order to issue the stormwater permit remained unresolved.

The property previously obtained stormwater permits in 2003 for the installation of the parking lot, picnic shelter, and overlook platform and in 2005 for wetland restoration.

Based on the information provided by the Petitioner and WBK, Staff believes that the following findings of fact as required by Section 904.1 of the Kendall County Stormwater Management Ordinance have been met:

1. The variance will not increase the probability of flood damage or create an additional threat to the public health, safety or welfare.
2. The variance requested is the minimum relief necessary to accomplish the objectives of the development without compromising the objectives of Section 102 of the Kendall Stormwater Management Ordinance.
3. The variance will not result in a reduction of water quality benefits as compared to compliance with ordinance requirements.
4. The variance is not requested solely for the purpose of reducing site runoff storage requirements.
5. The variance shall not cause conveyance of stormwater from the project to increase peak discharges beyond design capacity of existing offsite conveyance facilities for any storm event from the 2-year to the 100-year recurrence frequency.
6. The variance shall seek to preserve valuable environmental and biological resources including but not limited to stands of native trees, existing wetlands and natural floodplain storage.

**Staff Recommendation:**

Approval with Conditions

**Attachments:**

Application Materials

WBK Comment Letter Dated May 30, 2024

Draft Ordinance

May 7, 2024

Kendall County Department of Planning, Building, & Zoning  
111 West Fox Street  
Yorkville, Illinois, 60560

**SUBJECT: Subat Nature Center  
Kendall County Forest Preserve District  
ERA Project #W23229.00**

ERA is pleased to submit this stormwater permit application submittal for the renovation of Subat Nature Center. Enclosed you will find plans, exhibits, and a narrative describing the proposed work for this project.

All work has been completed by me or someone directly under my supervision, and this sheet signed and sealed will encompass all documents pertaining to the report.

I appreciate the opportunity for your review of this project.

Sincerely,

[Redacted Signature]

John Mayer, P.E., CFM  
Project Manager



Expires: November 30, 2025

### Existing Site Description

The project area is a nature preserve on three parcels owned by the Kendall County Forest Preserve District: 01-25-400-009, 01-36-200-022, and 01-36-200-025. Kendall County GIS indicates that the total property acreage is 67.27 acres. It is noted that disturbance of the property will be limited to approximately 1.63 acres.

The existing site includes a gravel parking lot, shelter, restroom building, and associated aggregate paths. Stormwater drainage directions vary across the property, with some areas draining south and west toward Rob Roy Creek, some areas draining toward on-site wetlands, and some areas draining south toward River Road.

There are no regulatory floodplain areas on the project site, as shown in Exhibit 5. ERA completed a wetland delineation of the project area on September 22, 2023 which identified on-site wetlands, as depicted in Exhibit 7. ERA is coordinating with the US Army Corps of Engineers to obtain a permit for minimal wetland impacts associated with installation of a boardwalk as part of this project. Additional exhibits are provided to include depictions of the site location, aerial imagery, soils, and USGS topography. It is noted that surveyed topography is provided in the plan set in areas where development is proposed, and that the project study area shown in these exhibits broadly depicts the location of the project and does not represent the disturbance area depicted in the provided plan set.

Existing site conditions are shown in Sheet L100 of the provided plan set.

### Proposed Site Description

The proposed project includes expansion and upgrade of the existing parking lot with an additional entrance along Eldamain Road, installation of new asphalt and crushed limestone walking paths, installation of a boardwalk, and installation of a nature center facility on a concrete pad. Proposed site conditions are shown in the provided plan set.

### Proposed Drainage Features

Proposed drainage features include stormwater culverts installed under the new parking lot entrance at the northeast corner of the project area and under the portion of trail that crosses the roadside ditch at the northwest corner of Eldamain Road and River Road. ERA obtained Kendall County LIDAR data to delineate the tributary areas of the proposed culverts. A depiction of the delineated tributary areas is provided as Exhibit 8 of this submittal. The existing tributary area of the culvert location at the new parking lot entrance was determined to be 0.145 acre. ERA determined that a 12-inch RCP culvert would provide adequate flow capacity for this small area. It is noted that geometry and grading of the existing parking lot entrance will remain the same, and there is no existing or proposed stormwater conveyance proposed below this entrance. The existing tributary area of the culvert at the corner of River Road and Eldamain Road was determined to be 1.067 acres. ERA conservatively recommended a 21-inch RCP culvert to ensure that adequate flow capacity would be provided in the roadside ditch.

Although not required by the Kendall County Stormwater Management Ordinance, the proposed nature center facility is designed with rain gardens equipped with 4" mitered drain outlets to facilitate stormwater drainage. Rain garden locations are shown in C302 and associated design details are shown in L500 of the provided plan set.

The Kendall County Forest Preserve District will be responsible for maintenance responsibilities associated with all proposed drainage features, including regular inspection of the proposed RCP culverts and any associated repairs.

### Development Areas and Detention Variance Request

The total development area of the project is approximately 71,125 sf (1.63-ac). The cumulative impervious improvement area of the project is approximately 36,850 sf (0.85-ac). In accordance with the Kendall County Stormwater Management Ordinance, since the development area is less than 5 acres, the % Impervious to Unit Area Detention nomograph depicted in Table 203 of the Ordinance may be used to determine the runoff storage volume requirement. Approximately 52% of the development area is impervious, therefore, 0.3 acre-ft of storage per acre of detention basin tributary area would be required. Assuming that the entire development area (1.63-ac) would be managed by the detention basin, approximately 0.49 ac-ft of storage volume would be required.

The Kendall County Forest Preserve District is requesting a variance from the detention requirement of the Kendall County Stormwater Management Ordinance for this project. Linear improvements such as impervious trails and walkways do not significantly impact site runoff rates, and providing detention for linear improvements is difficult and costly. For these reasons, the surrounding collar counties have specified exceptions to the detention requirements of their stormwater ordinances for impervious paths and trails developed in open space. In this particular case, asphalt and crushed limestone paths account for more than half of the proposed impervious development area. Other proposed impervious facilities, including the parking lot, entrances, and nature center account for approximately 16,920 sf of impervious area, which is less than the 32,000-sf impervious area threshold for site runoff storage requirements in the Kendall County Stormwater Management Ordinance. Additionally, the intent of this project is to improve and provide community access to the Subat Forest Preserve without resulting in unnecessary disturbance of on-site prairie and wetland areas. Due to the location of on-site wetlands, it is likely that at least two detention basins would be necessary to manage stormwater runoff from northern and southern project areas, resulting in additional on-site disturbance.

Soil Erosion and Sediment Control

The stormwater pollution prevention plan provided as L101 of the plan set describes the erosion control measure that will be implemented prior to the start of construction. Silt fencing is provided at downstream edges of the project. A temporary concrete washout location is proposed southwest of the facility parking lot. Excavated soils that are not repurposed as backfill material will be kept on-site and graded to maintain the existing site drainage direction, with silt fencing installed at the downstream edge of the stockpile area. All disturbed areas will be stabilized with topsoil, seed, and erosion control blanket in accordance with the IEPA General NPDES Permit for Construction Activities.

Conclusion

ERA looks forward to the County's review of this stormwater management permit application submittal for the renovation of Subat Nature Center. Please contact me with any questions or concerns at 630 393-3060 or [jmayer@eraconsultants.com](mailto:jmayer@eraconsultants.com).

Respectfully submitted,  
Engineering Resource Associates, Inc.



John F. Mayer, PE, CFM  
Project Manager

- Attachment 1 – Stormwater Management Permit Application Form
- Attachment 2 – Exhibits
- Attachment 3 – Plan Set

# STORMWATER MANAGEMENT PERMIT

PERMIT APPLICATION # \_\_\_\_\_

Conformance with all Federal, State, and County Regulations is required. Applicants are encouraged to the Countywide Stormwater Management Ordinance and consider a pre-application meeting with Department staff prior to submittal. See attached highlights of regulations.

Property: Name Kendall County Forest Preserve District

Owner Address 110 W. Madison Street, Yorkville, IL 60560

Phone 630-553-4025

Agent: Name Engineering Resource Associates, Inc.

Address 3s701 W Avenue, Suite 150, Warrenville, IL 60555

Phone 630-393-3060

Site: Address or Location Intersection of Eldamain Road and River Road, Plano, IL 60545

Tax Parcel # 01-25-400-009, 01-36-200-022, and 01-36-200-025

Zoning/Land Use/Acres A1 Agricultural / Forest Preserve / 67.27 acres (1.63-ac disturbance)

### Proposed Development:

The proposed development will upgrade facilities and walking paths at Subat Forest Preserve. Please see the description of the proposed development in the attached permit application memo.

Attachments: Plat \_\_\_\_\_ Construction Plans X

Soils \_\_\_\_\_ Landscaping \_\_\_\_\_

Grading X Phasing \_\_\_\_\_

Other \_\_\_\_\_

Fees \$ \_\_\_\_\_ Processing Fee (\$50.00)

\$ \_\_\_\_\_ Engineering Review Deposit (\$2,500.00 or 2% of estimated cost of the proposed improvements, whichever is greater. A \$3,500.00 Construction Inspection Services Fee and General Consultation Fee Might Be Required as the Project Progresses)

TOTAL \$ \_\_\_\_\_ One check is acceptable made out to the Kendall County Treasurer

Staff will contact Applicant regarding schedule and reviews.

I hereby certify that the information on this application, on the documents attached, and on other submittals made during the review process is true and correct; that I am authorized to file this application; and that I agree to conform to all requirements set forth by the County and all conditions of the County Stormwater Management Ordinance. I understand that by signing this form, that the property in question may be visited by County Staff and County Engineers throughout the permit and construction process. I also understand that I am responsible for all costs associated with this application. The applicant attests that they are free of debt or current on all debts owed to Kendall County as of the application date.

Owner's Signature (Including Middle Initial) [Redacted] Date 05/07/2024

*Elec. Advisor - KcFPD*

Agent's Signature (Including Middle Initial) \_\_\_\_\_ Date \_\_\_\_\_

Kendall County Planning, Building, & Zoning Department  
111 West Fox Street, Room 203  
Yorkville, Illinois 60560  
Phone: (630) 553-4139, Fax (630) 553-4179  
[www.kendallcountvil.gov](http://www.kendallcountvil.gov)



**DEPARTMENT OF PLANNING, BUILDING & ZONING**

111 West Fox Street • Yorkville, IL • 60560  
(630) 553-4141 Fax (630) 553-4179

**ENGINEERING CONSULTANT FEES**

I, \_\_\_\_\_ understand that Kendall County uses the services of a  
Applicant Name  
consultant for engineering reviews and inspections and that I will be responsible for  
payment of services on \_\_\_\_\_ project. I authorize the consulting  
Project Name  
services to proceed.

IF THIS IS **NOT** PART OF A BUILDING PERMIT APPLICATION, PLEASE CHECK THE BOX  
AND COMPLETE THIS SECTION:

I hereby submit a deposit of \_\_\_\_\_ payable to the **Kendall County Treasurer**  
\$ Amount

to be used by Kendall County to reimburse consultant for charges invoiced for work  
done in the review, approval and inspection of the proposed improvements.


I understand that if the deposit is depleted that I may be required to replenish the  
deposit to have work proceed.

I further understand that Kendall County will not issue a Building Permit or a Certificate  
of Occupancy as the case may be until I provide payment or proof of payment for the  
engineering services.


Signature of Applicant: \_\_\_\_\_

Date: 05/07/2024

Exec. Advisor. KCFPD

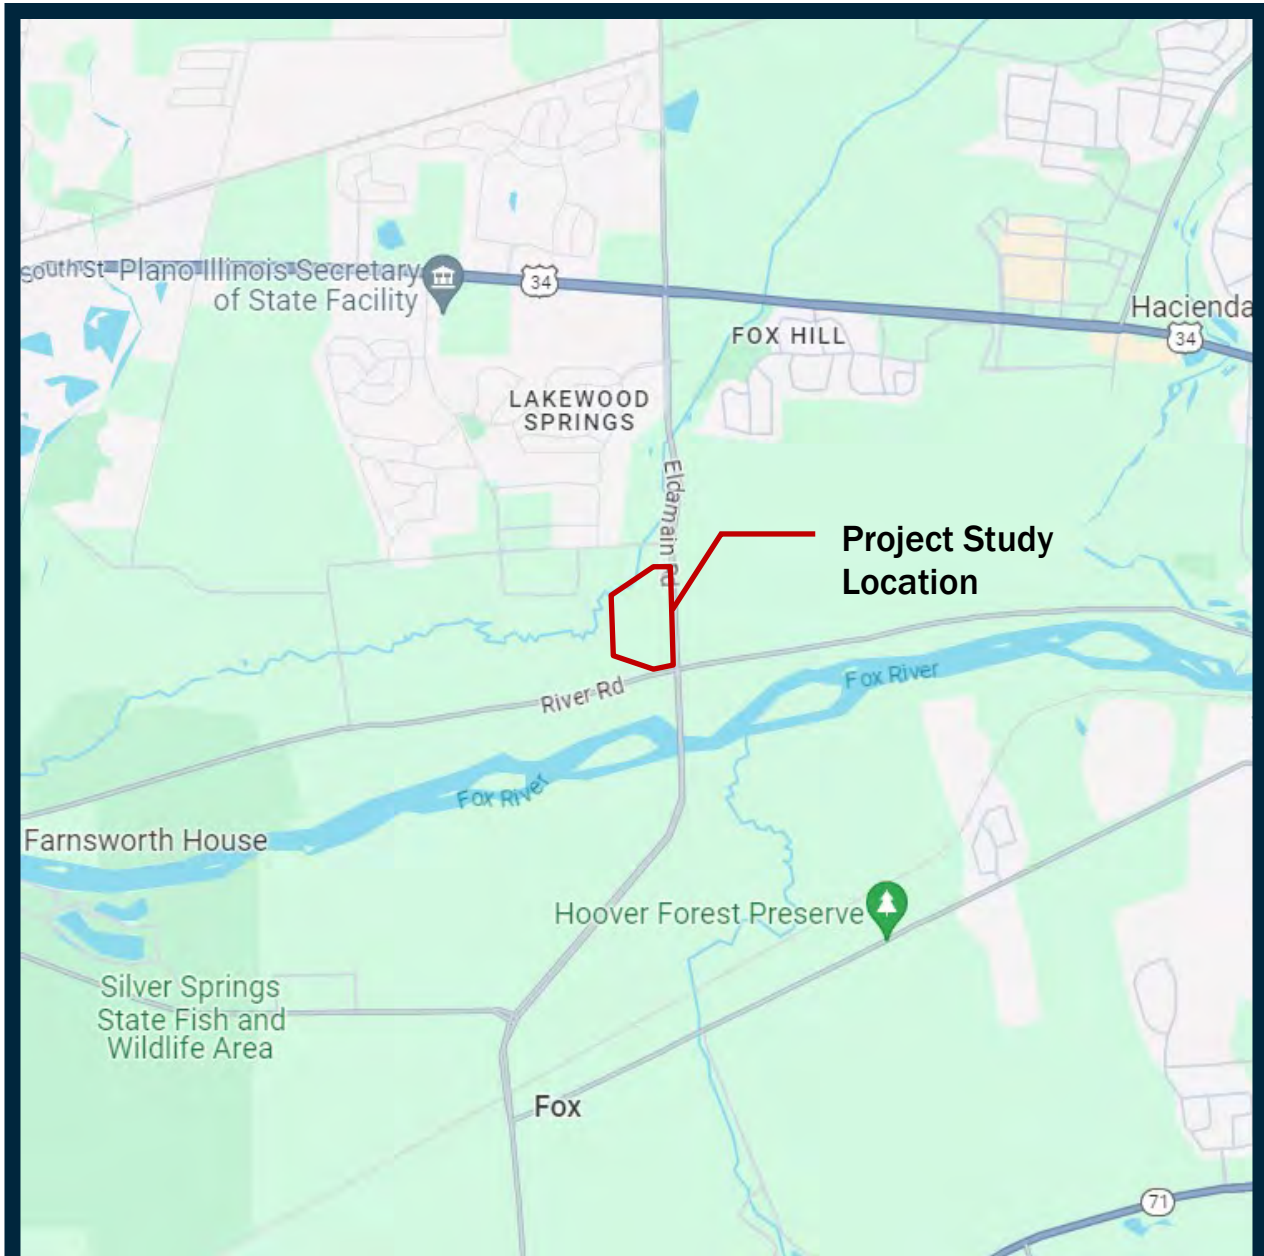

**Exhibit 1**  
**Location Map**  
 Lat/Long: 41.646062°, -88.489773°  
 — Project Study Location

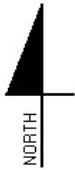

Client: Upland Design  
 Project Name: Subat Nature Preserve  
 ERA Project #: W23229.00  
 Source: Google Maps

**Not to Scale**



**Engineering Resource Associates, Inc.**  
 3S701 West Avenue, Suite 150  
 Warrenville, IL 60555  
 Phone: (630) 393-3060 FAX: (630) 393-2152


**Warrenville | Chicago | Champaign**  
[www.eraconsultants.com](http://www.eraconsultants.com)





**Exhibit 2**  
**National Wetland Inventory Map**  
 Lat/Long: 41.646062°, -88.489773°

— Project Study Location

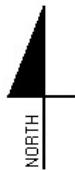


Client: Upland Design  
 Project Name: Subat Nature Preserve  
 ERA Project #: W23229.00  
 Source: USFWS NWI Mapper

Not to Scale




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**Exhibit 3**  
**Aerial Photograph**  
Lat/Long: 41.646062°, -88.489773°  
— Project Study Location

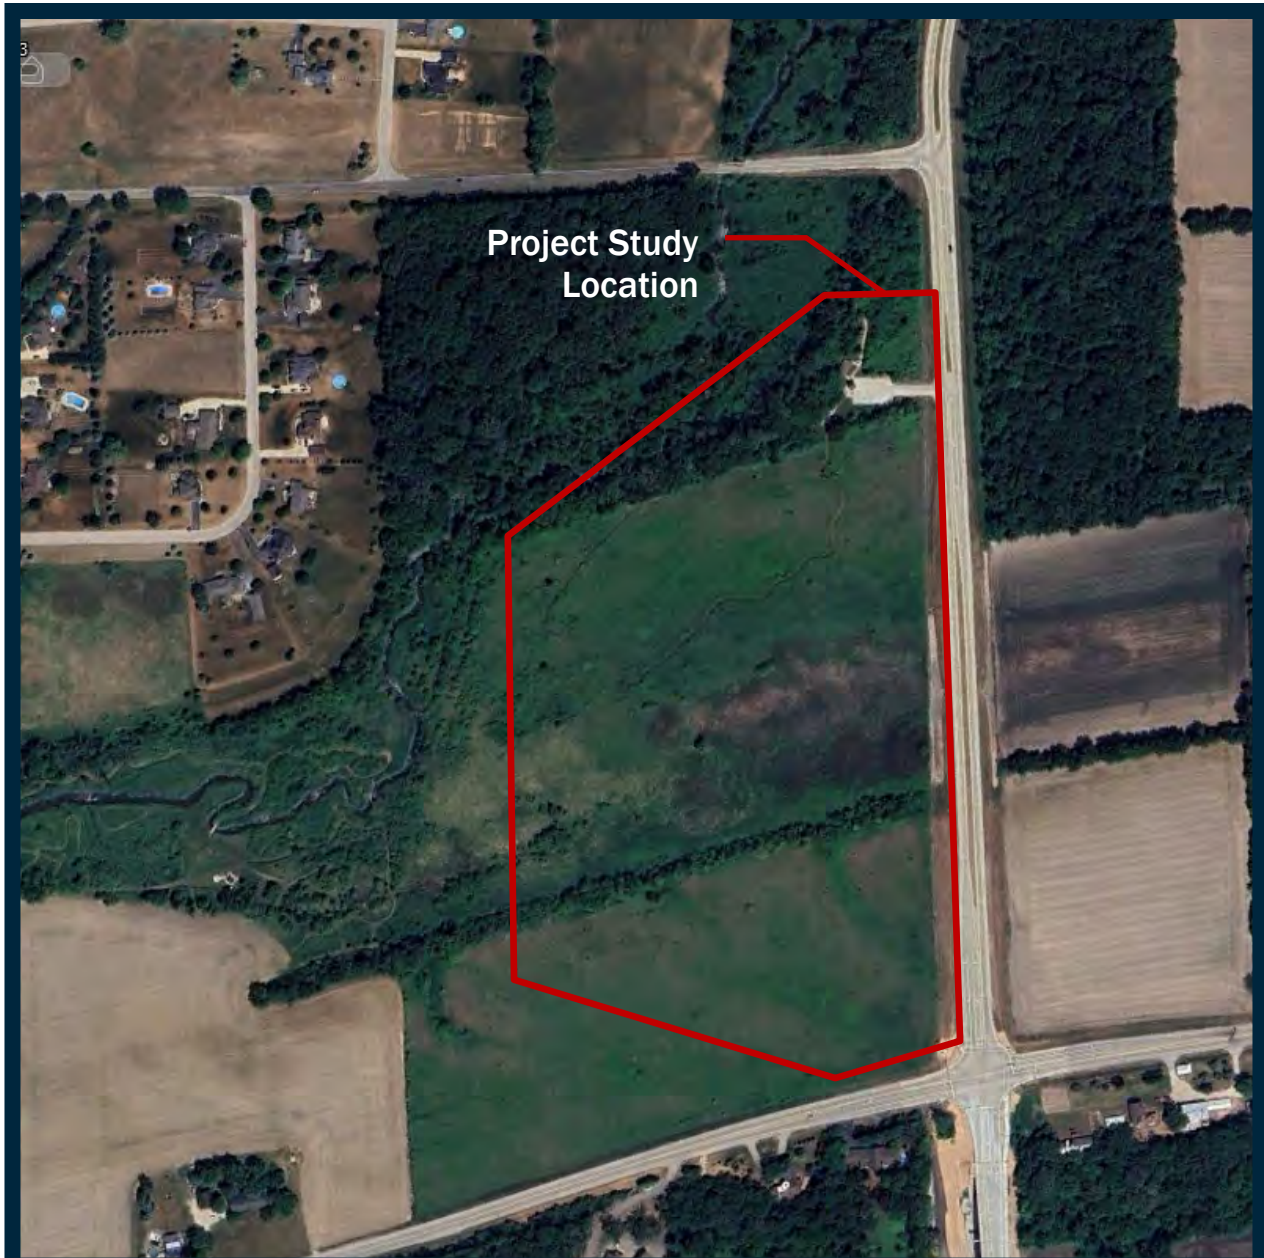


Client: Upland Design  
Project Name: Subat Nature Preserve  
ERA Project #: W23229.00  
Source: Google Earth

Not to Scale

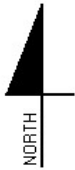


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**Exhibit 4.1**  
**NRCS Soils Map**  
 Lat/Long: 41.646062°, -88.489773°  
 — Project Study Location

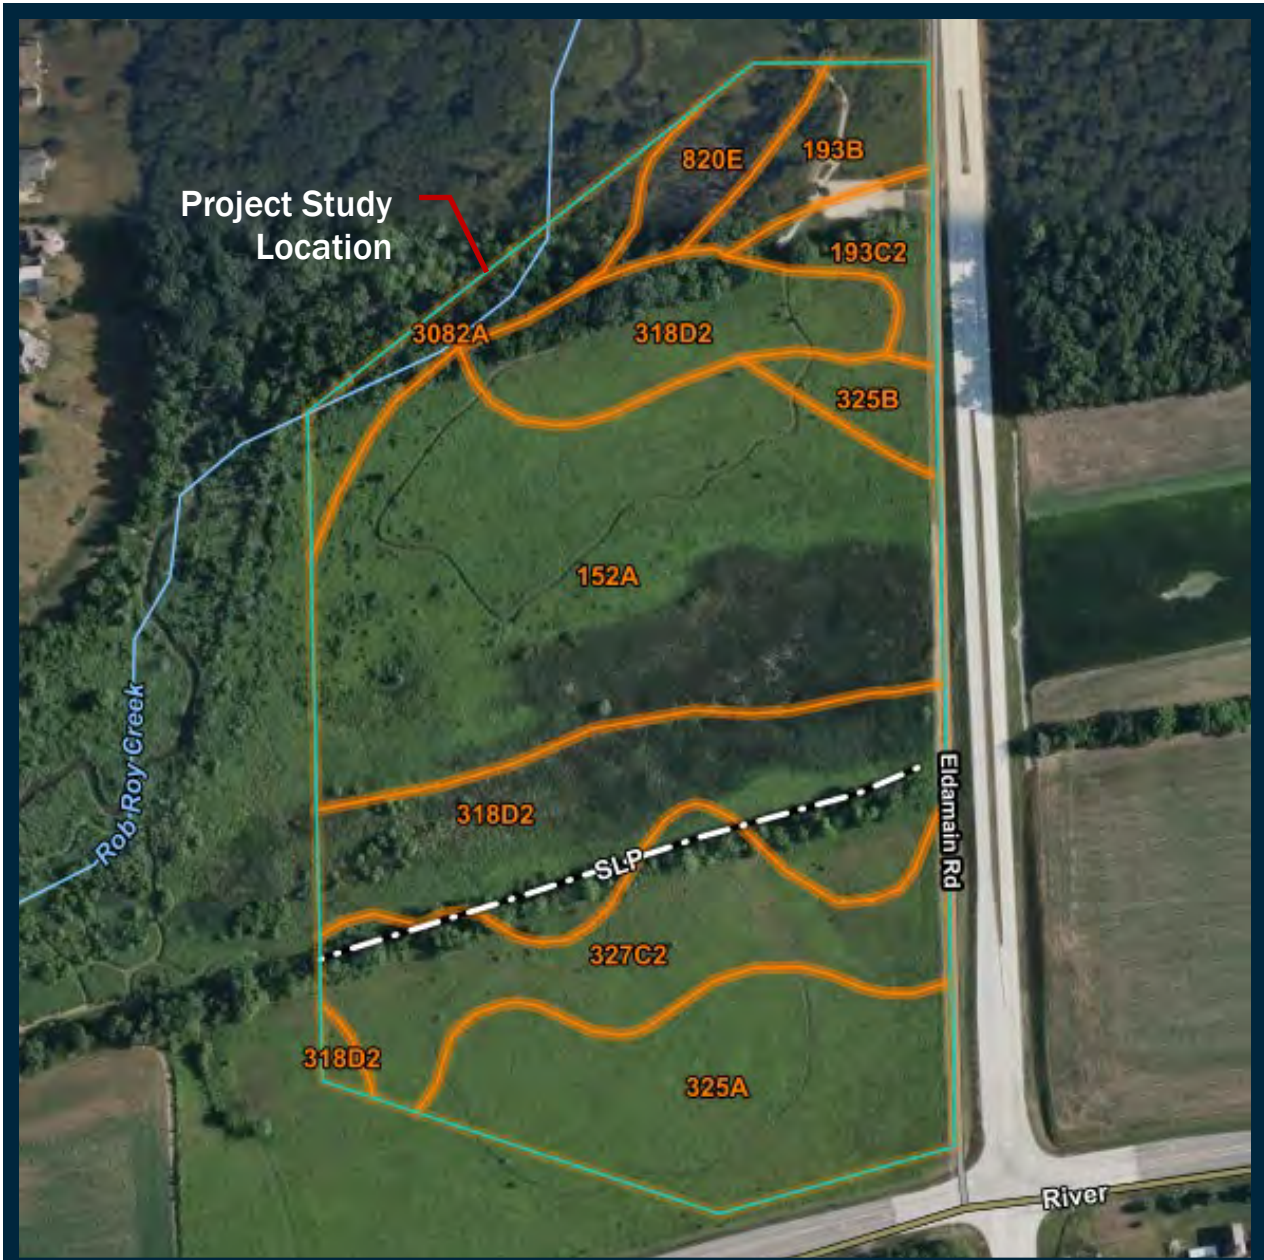

Client: Upland Design  
 Project Name: Subat Nature Preserve  
 ERA Project #: W23229.00  
 Source: USDA Web Soil Survey

Not to Scale

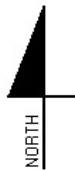

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## Map Unit Legend


Map Unit Symbol	Map Unit Name	Acres in AOI	Percent of AOI
152A	Drummer silty clay loam, 0 to 2 percent slopes	12.5	33.4%
193B	Mayville silt loam, 2 to 5 percent slopes	1.4	3.7%
193C2	Mayville silt loam, 5 to 10 percent slopes, eroded	1.0	2.8%
318D2	Lorenzo loam, 6 to 12 percent slopes, eroded	8.6	23.1%
325A	Dresden silt loam, 0 to 2 percent slopes	5.5	14.7%
325B	Dresden silt loam, 2 to 4 percent slopes	0.8	2.1%
327C2	Fox silt loam, 4 to 6 percent slopes, eroded	4.8	12.9%
820E	Hennepin-Casco complex, 12 to 30 percent slopes	1.1	3.0%
3082A	Millington silt loam, 0 to 2 percent slopes, frequently flooded	1.6	4.3%
<b>Totals for Area of Interest</b>		<b>37.3</b>	<b>100.0%</b>

### Exhibit 4.2

#### NRCS Soils Map

Lat/Long: 41.646062°, -88.489773°

 Project Study Location

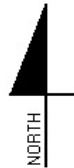

Client: Upland Design  
 Project Name: Subat Nature Preserve  
 ERA Project #: W23229.00  
 Source: USDA Web Soil Survey

Not to Scale




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**Exhibit 5**  
**FEMA Flood Insurance Rate Map**  
 Lat/Long: 41.646062°, -88.489773°  
 — Project Study Location




Client: Upland Design  
 Project Name: Subat Nature Preserve  
 ERA Project #: W23229.00  
 Source: FEMA FIRM Viewer


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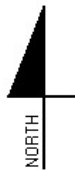

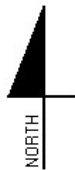
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**Exhibit 6**  
**USGS Topographic Map**  
Lat/Long: 41.646062°, -88.489773°  
 Project Study Location



Client: Upland Design  
Project Name: Subat Nature Preserve  
ERA Project #: W23229.00  
Source: USGS National Map

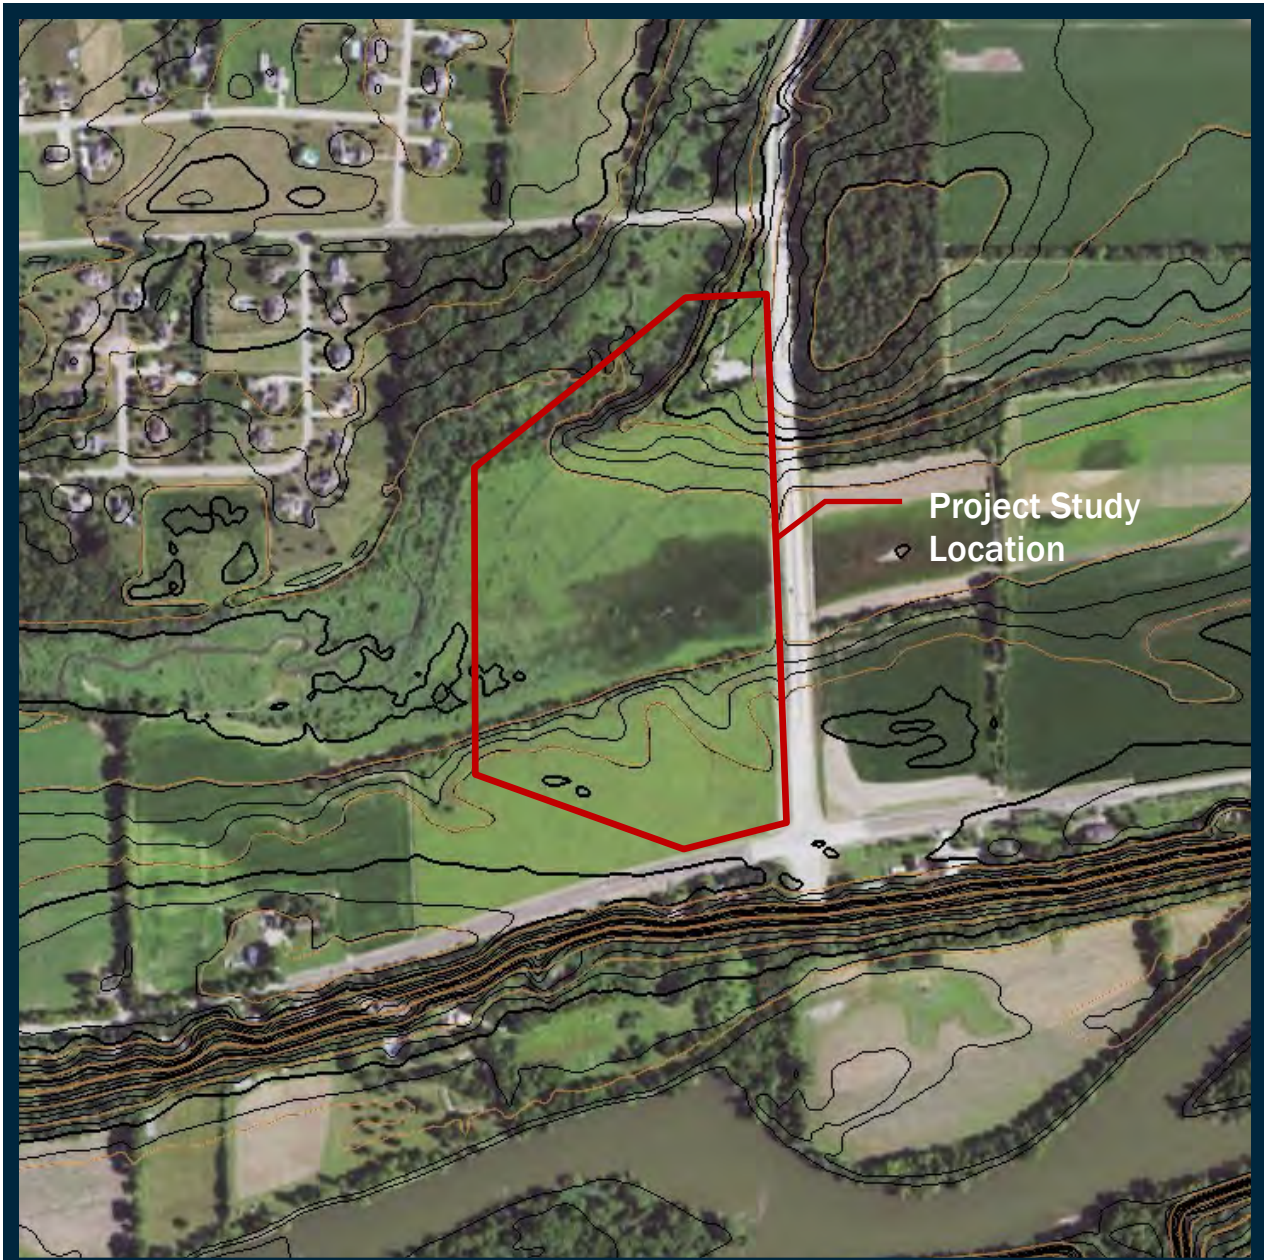**Not to Scale**



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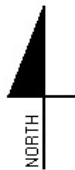
**Project Study Location**

**UPL**

**WL**

**Exhibit 7**  
**Approximate Wetland Boundary**  
 Lat/Long: 41.646062°, -88.489773°

- Approximate Wetland Boundary
- - - Approximate Offsite Wetlands Boundary
- Project Study Location
- Data Point



Client: Upland Design  
 Project Name: Subat Nature Preserve  
 ERA Project #: W23229.00  
 Source: ESRI

**Not to Scale**





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**BASIN 2 (0.145 ACRES)**



**BASIN 1 (1.067 ACRES)**



**Legend**

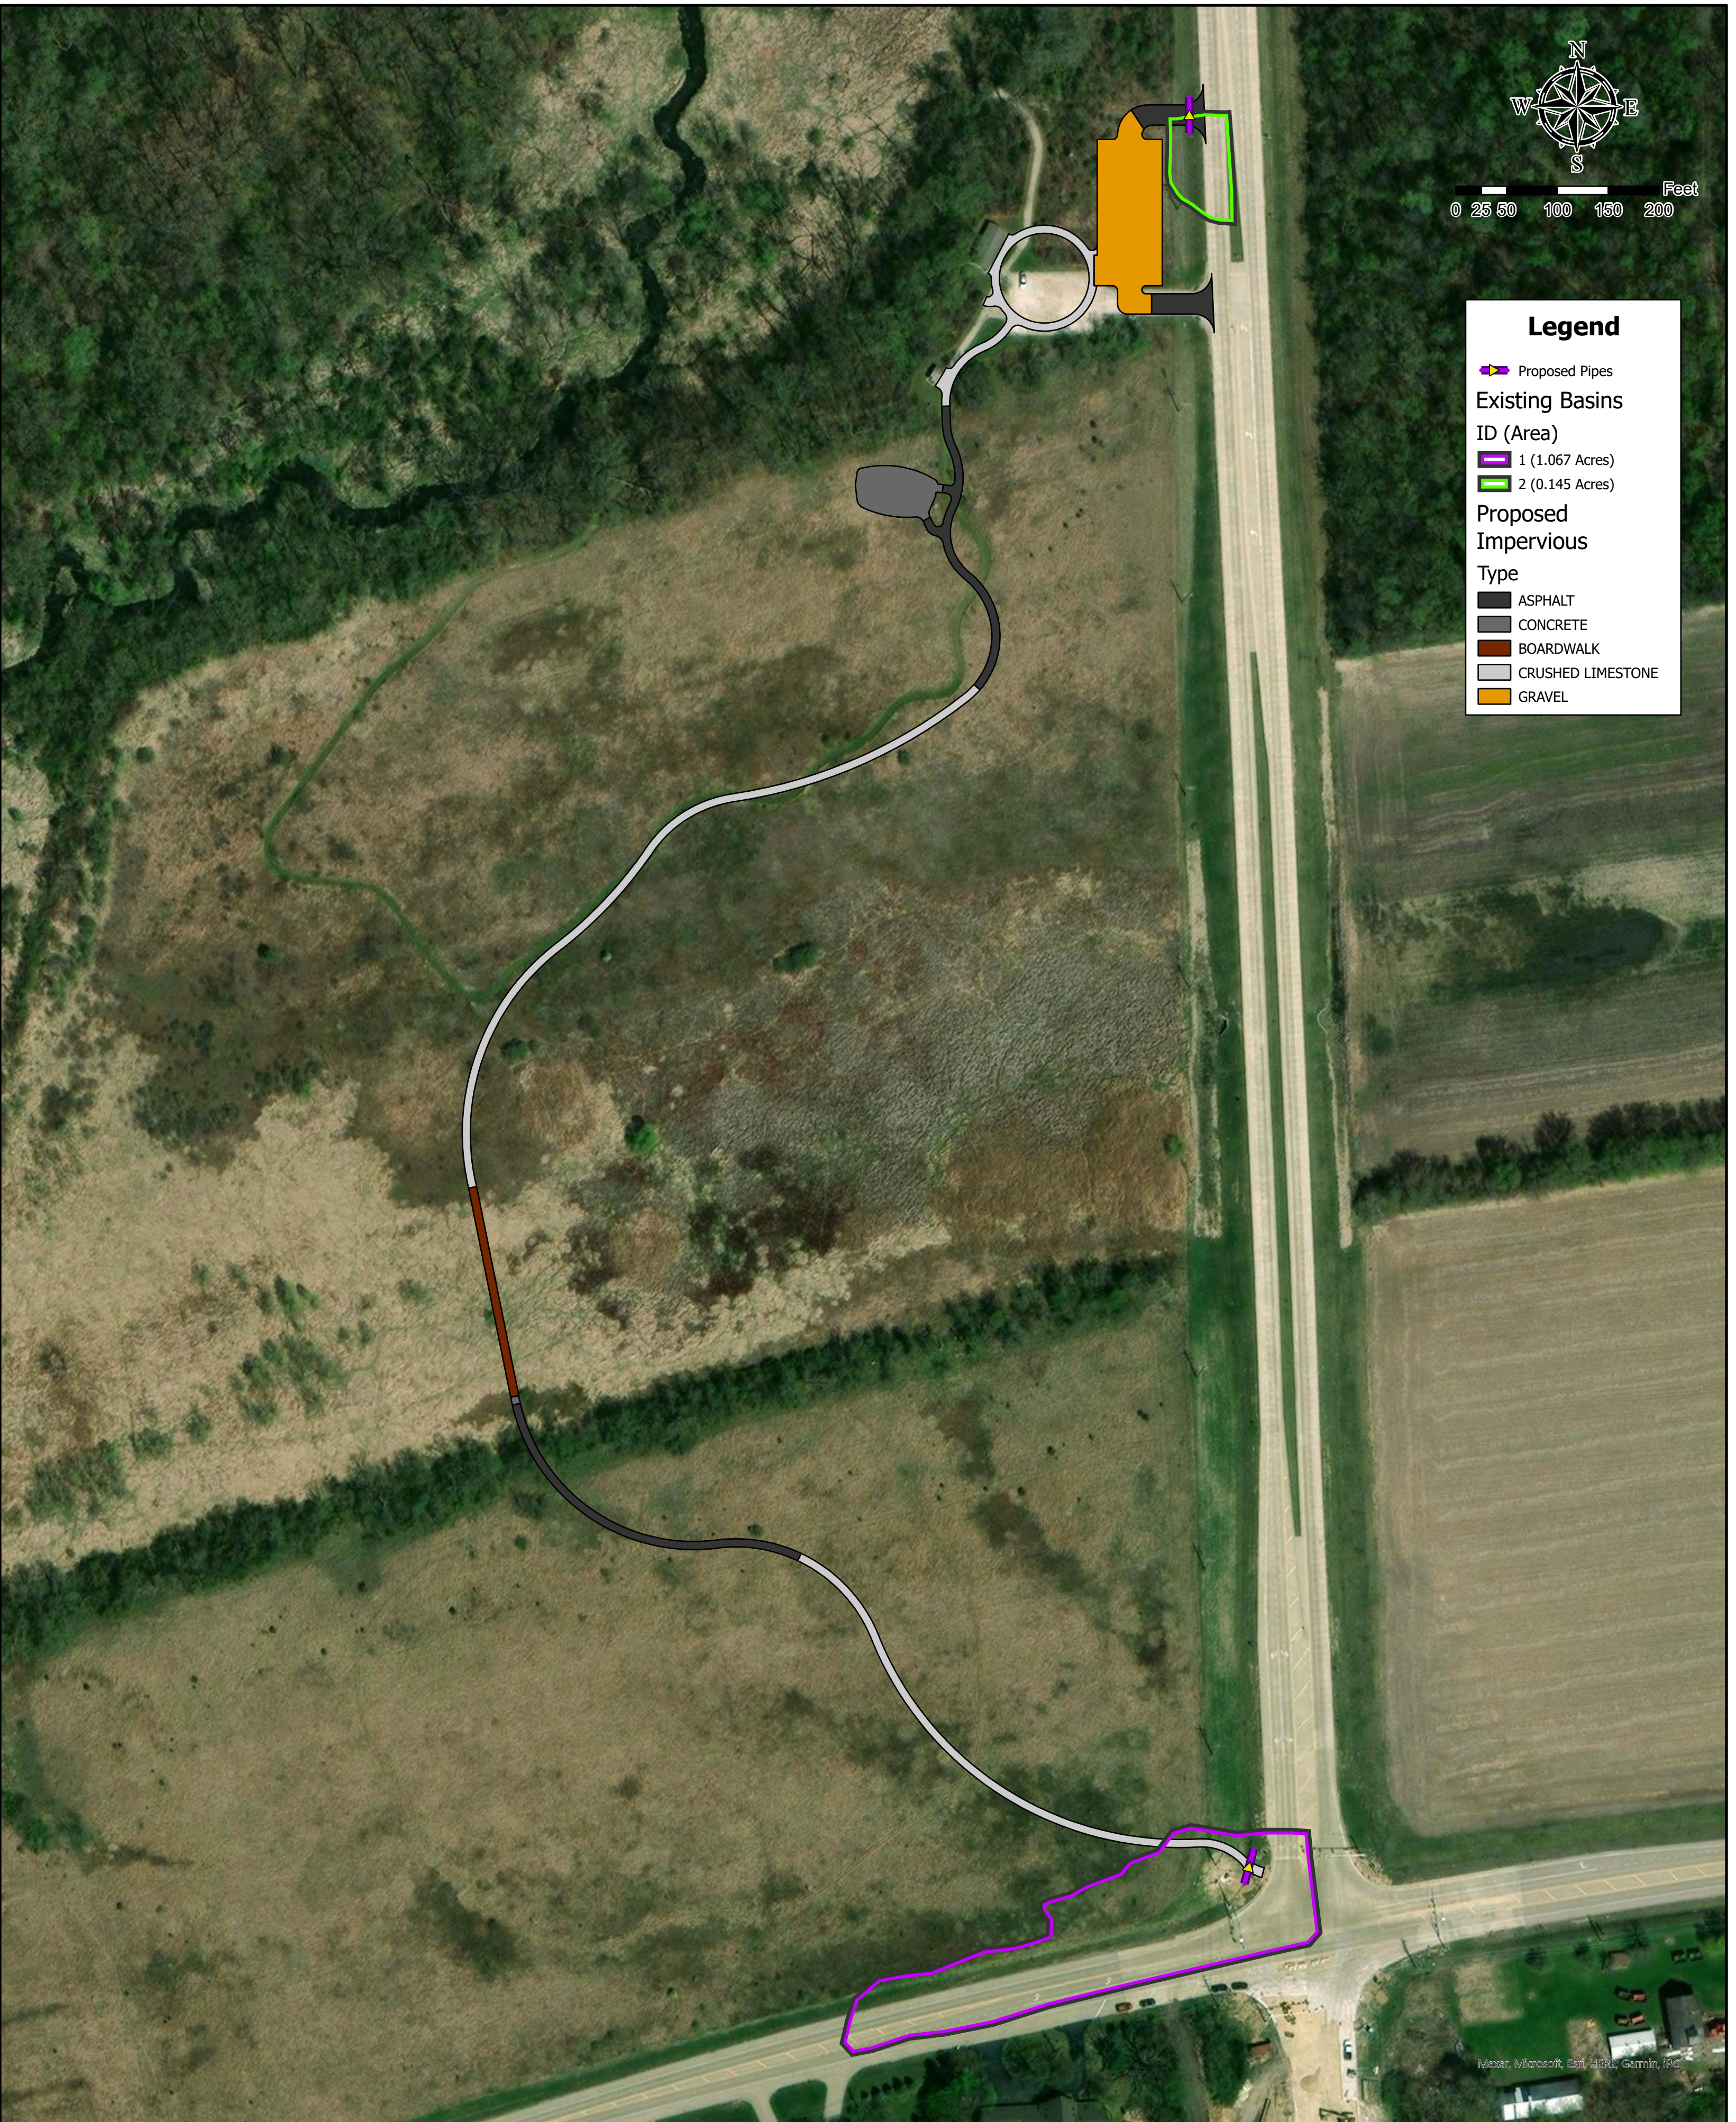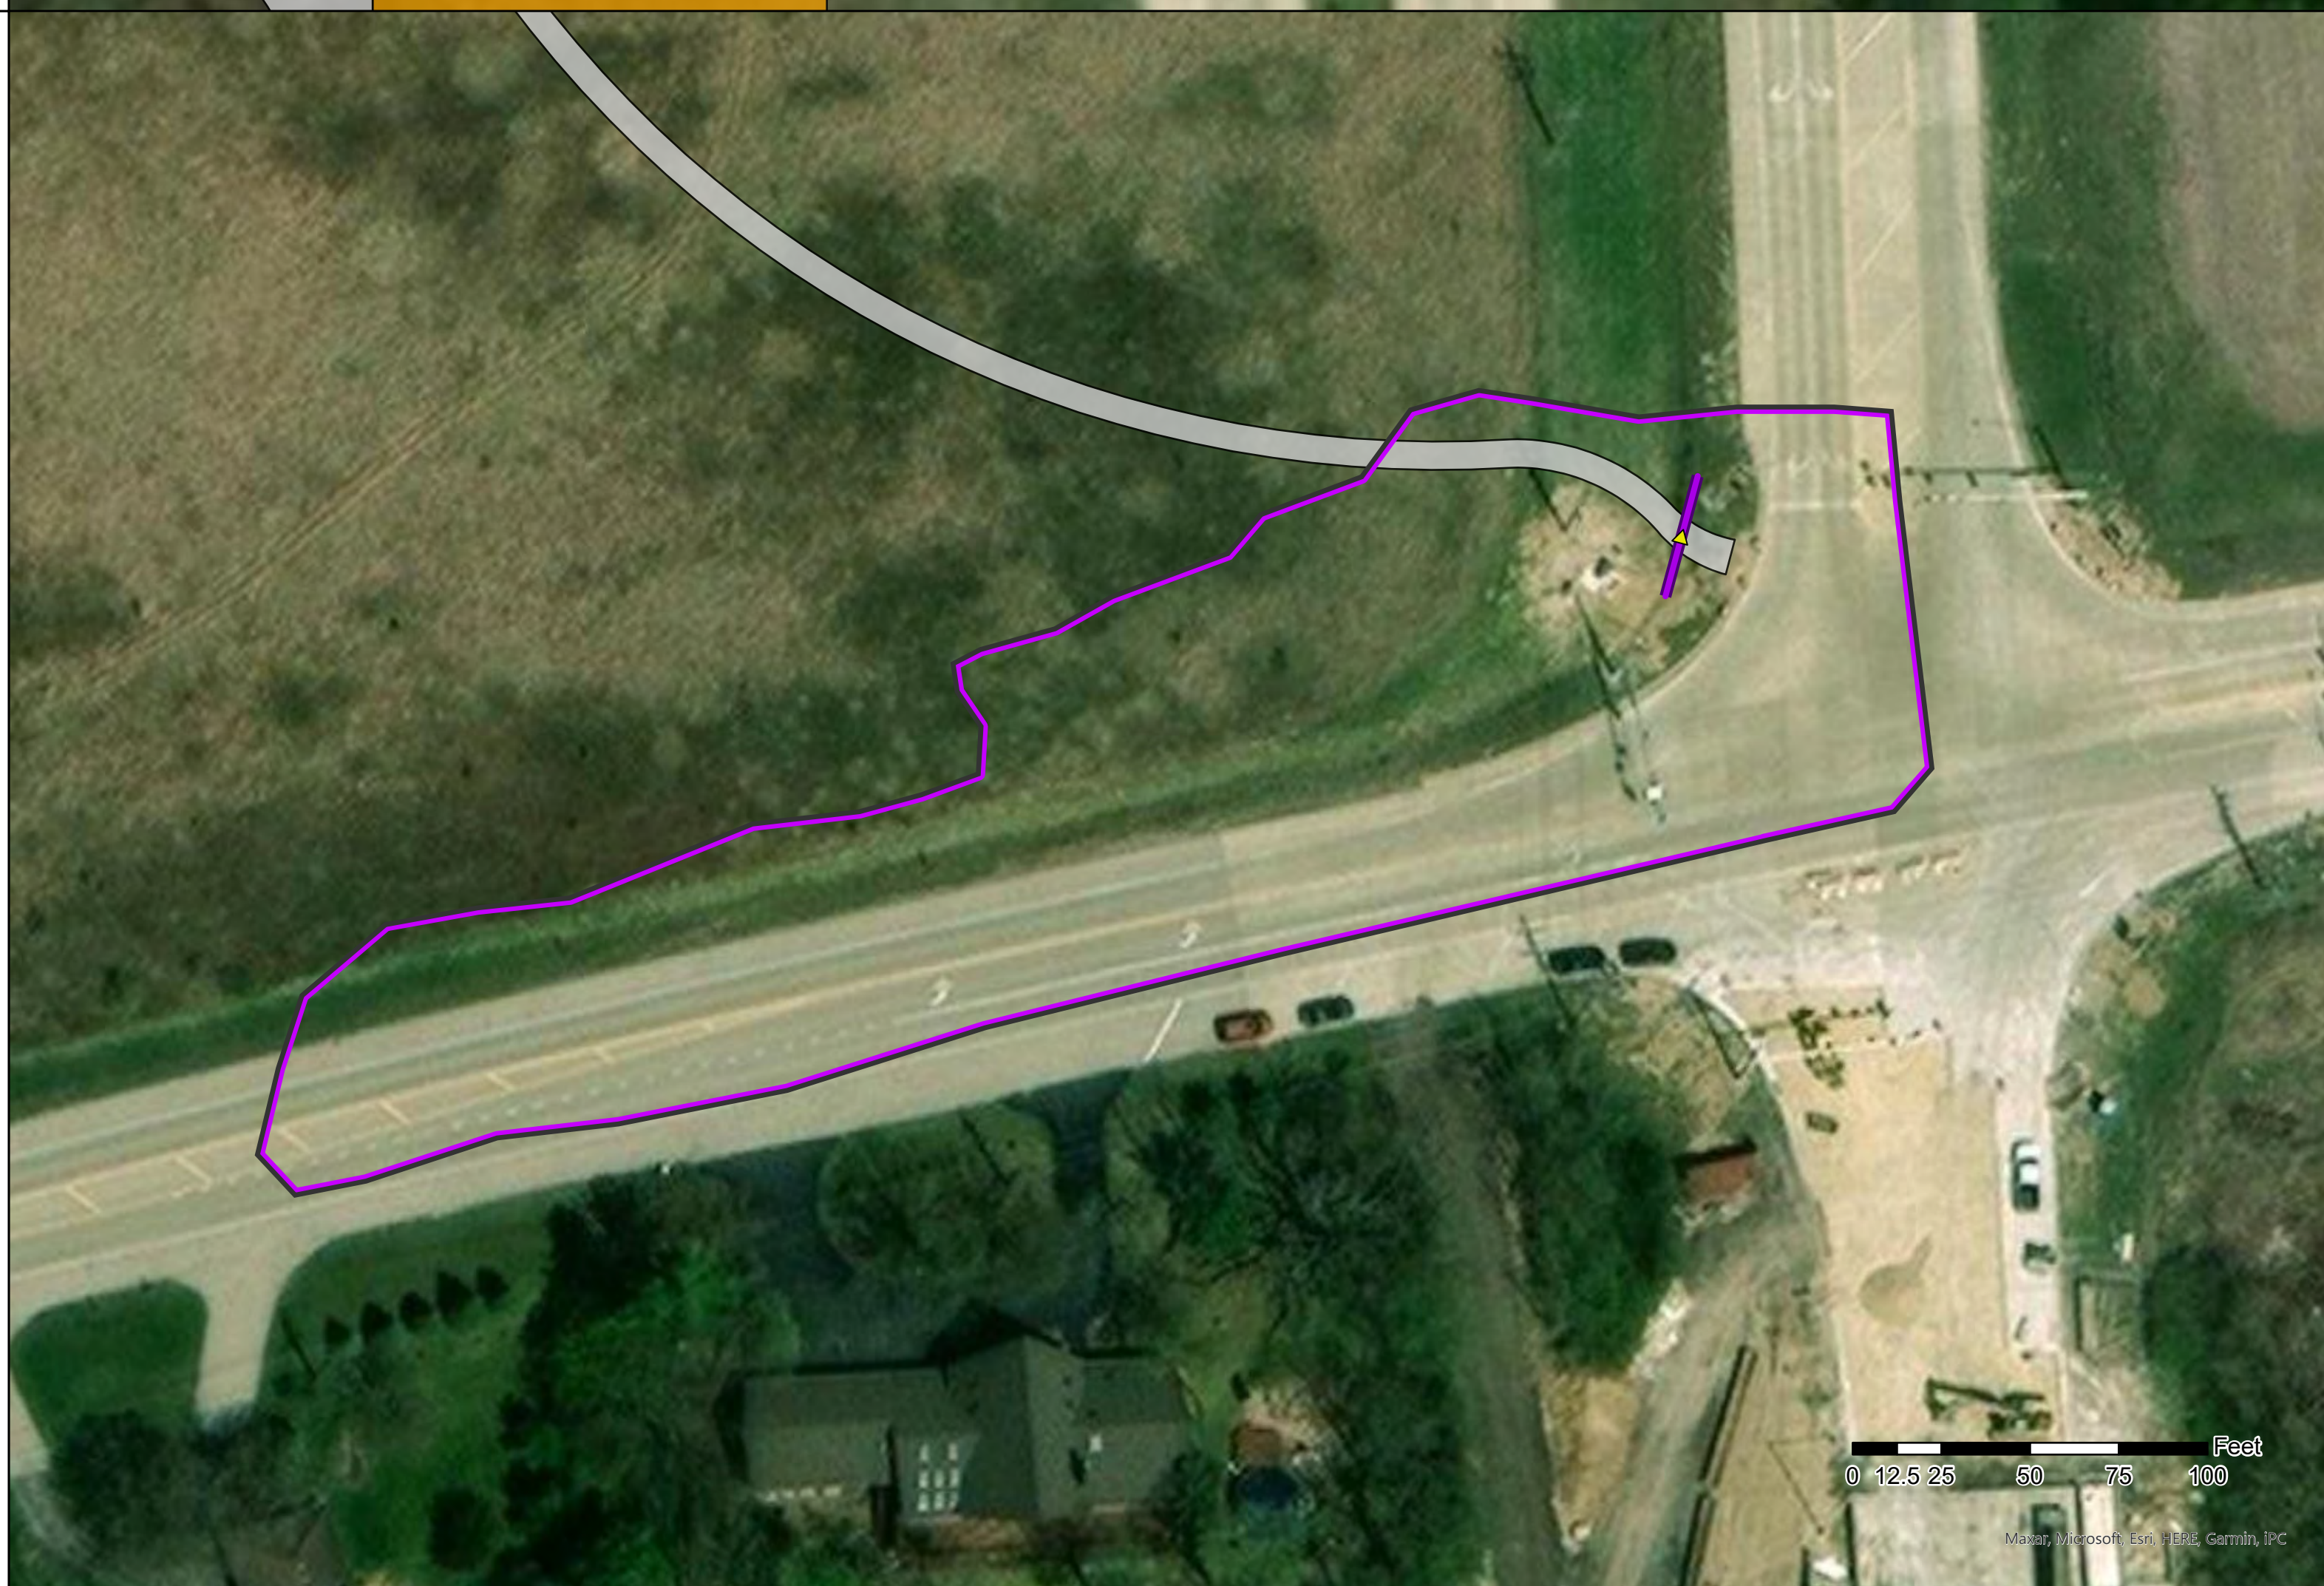- Proposed Pipes
- Existing Basins ID (Area)
  - 1 (1.067 Acres)
  - 2 (0.145 Acres)
- Proposed Impervious Type
  - ASPHALT
  - CONCRETE
  - BOARDWALK
  - CRUSHED LIMESTONE
  - GRAVEL

REVISIONS:					
DATE	BY	DESCRIPTION	DATE	BY	DESCRIPTION

DRAWING BY: CF  
 CHECKED BY: TF  
 APPROVED BY: SG



35701 WEST AVENUE, SUITE 150  
 WARRENVILLE, ILLINOIS 60555  
 PHONE (630) 393-3060  
 FAX (630) 393-2152

10 S. RIVERSIDE PLAZA, SUITE 875  
 CHICAGO, ILLINOIS 60606  
 PHONE (312) 474-7841  
 FAX (312) 474-6099

2416 GALEN DRIVE  
 CHAMPAIGN, ILLINOIS 61821  
 PHONE (217) 351-6268  
 FAX (217) 355-1902

CLIENT:

UPLAND DESIGN

TITLE:

EXISTING BASINS  
 SUBAT NATURE PRESERVE

SCALE: 1 IN = 100 FT  
 DATE: 5/2/2024  
 PROJECT: W23229.00  
 SHEET: 1 OF 1



May 14, 2024

Kendall County Department of Planning, Building, & Zoning  
111 West Fox Street  
Yorkville, Illinois, 60560

**SUBJECT: Subat Nature Center  
Kendall County Forest Preserve District  
ERA Project #W23229.00  
Comments Received May 8, 2024**

ERA submits the following responses to the stormwater management permit application comments received via email on May 8, 2024.

1. **Comment:** Pursuant to Section 901.4 of the Kendall County Stormwater Management Ordinance, please submit the following materials:
  - a. The common address (if one exists) and legal description(s) of the property.
  - b. The names and addresses of all property owners within 250 feet (PBZ can provide these, but please confirm that the 3 parcel numbers listed are correct).
  - c. The specific provision from which a variance is sought (i.e. the section of the Stormwater Management Ordinance that would be varied).
  - d. A statement that the variance requested is the minimum necessary to permit development.
  - e. Please submit statements explaining how the variance satisfies the standards contained in Section 904.1 of the Kendall County Stormwater Management Ordinance.

**Response:**

- a. The common address of the forest preserve entrance and parking lot is 4845 Eldamain Road, Plano, IL 60545. A land title survey of the three parcels encompassing the project area is provided as an attachment to this response. Legal descriptions are included in the land title survey document.
- b. A list of names and addresses of all property owners within 250 feet is provided as Attachment 2 (3 pages) to this response.
- c. The applicant seeks a variance from the site runoff storage requirements of Section 203 of the Kendall County Stormwater Management Ordinance.
- d. The variance requested is the minimum necessary to permit the proposed development, as described further in the response to Comment 1.e., below.
- e. The following statements are submitted to address the standards contained in Section 904.1 of the Kendall County Stormwater Management Ordinance (Ordinance):

The project has an impervious area of 36,850 sf. Under current project conditions, the Ordinance requires detention for developments resulting in an impervious area of greater than 32,000 sf. The trail section of the project constitutes 19,930 sf of impervious area or approximately 54% of the total impervious area of the project. The Kendall County Forest Preserve District requests a variance that allows exclusion of the impervious trail sections of the project in the calculation of total impervious improvements, as described below, resulting in no stormwater detention requirement for the project. The Kendall County Forest Preserve District requests a variance from site runoff storage requirements to avoid unnecessary disturbance of restored prairie habitats and native trees that reside within Subat Forest Preserve, as described below.

The variance is not requested solely for the purpose of reducing site runoff storage requirements [904.1(d)]. The variance would preserve valuable environmental and biological resources, including restored prairie habitat, native trees, and existing wetlands [904.1(f)]. The intent of this project is to improve and provide community access to the Subat Forest Preserve without resulting in unnecessary disturbance of valuable on-site natural resources.

ERA looks forward to the County's review of these comment responses. Please contact me with any questions or concerns at 630 393-3060 or [jmayer@eraconsultants.com](mailto:jmayer@eraconsultants.com).

Respectfully submitted,  
Engineering Resource Associates, Inc.



John F. Mayer, PE, CFM  
Project Manager

Attachment 1 - ALTA/NSPS Land Title Survey  
Attachment 2 - Properties Within 250' of the Project Area (3 pages)

# ALTA/NSPS LAND TITLE SURVEY

**SOUTHERLY PARCEL**  
 THAT PART OF THE NORTHEAST QUARTER OF SECTION 36, TOWNSHIP 37 NORTH, RANGE 6 EAST OF THE THIRD PRINCIPAL MERIDIAN, BEING DESCRIBED AS FOLLOWS: COMMENCING AT THE NORTHEAST CORNER OF SAID SECTION 36; THENCE SOUTH 00 DEGREES 00 MINUTES 19 SECONDS WEST ALONG THE EAST LINE OF SAID QUARTER SECTION, 699.00 FEET TO THE POINT OF BEGINNING; THENCE NORTH 89 DEGREES 49 MINUTES 17 SECONDS WEST, 1279.78 FEET; THENCE SOUTH 00 DEGREES 37 MINUTES 43 SECONDS EAST, 610.73 FEET TO THE CENTERLINE OF RIVER ROAD; THENCE NORTH 75 DEGREES 28 MINUTES 49 SECONDS EAST ALONG SAID CENTERLINE, 1315.05 FEET TO SAID EAST LINE OF SECTION 36; THENCE NORTH 00 DEGREES 00 MINUTES 19 SECONDS EAST ALONG SAID EAST LINE, 277.00 FEET TO THE POINT OF BEGINNING ALL IN THE TOWNSHIP OF LITTLE ROCK, KENDALL COUNTY, ILLINOIS.




**NORTHERLY PARCEL**  
 THAT PART OF THE SOUTHEAST QUARTER OF SECTION 25 AND PART OF THE NORTHEAST QUARTER OF SECTION 36, TOWNSHIP 37 NORTH, RANGE 6 EAST OF THE THIRD PRINCIPAL MERIDIAN BY BEING DESCRIBED BY BEGINNING AT THE SOUTHEAST CORNER OF SAID SECTION 25; THENCE NORTH 00 DEGREES 00 MINUTES 39.5 SECONDS WEST ALONG THE EAST LINE OF SAID QUARTER SECTION, 1212.83 FEET TO THE CENTERLINE OF SCHAEFER ROAD; THENCE SOUTH 88 DEGREES 03 MINUTES 05 SECONDS WEST ALONG SAID CENTERLINE, 1285.48 FEET TO THE WEST LINE OF SUB LOT 13 OF SAID SECTION 25 AS SHOWN ON PAGE 36 OF PLAT BOOK 4; THENCE SOUTH 00 DEGREES 02 MINUTES 47 SECONDS WEST ALONG SAID WEST LINE, 1301.73 FEET MORE OR LESS TO A POINT LYING 136.62 FEET SOUTH OF THE NORTH LINE OF SAID SECTION 36, SAID POINT BEING THE SOUTHEAST CORNER OF SUB LOT 2 OF SAID SECTION 36 AS SHOWN ON PAGE 36 OF PLAT BOOK 4; THENCE SOUTH 00 DEGREES 37 MINUTES 43 SECONDS EAST PARALLEL WITH THE EAST LINE OF SAID SUB LOT 3 OF SAID SECTION 36, 562.50 FEET; THENCE SOUTH 89 DEGREES 49 MINUTES 17 SECONDS EAST, 1279.78 FEET TO A POINT ON THE EAST LINE OF SAID SECTION 36; THENCE NORTH 00 DEGREES 00 MINUTES 19 SECONDS EAST ALONG SAID EAST LINE, 699.00 FEET TO THE POINT OF BEGINNING IN THE TOWNSHIP OF LITTLE ROCK, KENDALL COUNTY, ILLINOIS.

**SCHAEFER ROAD DEDICATION:**  
 THAT PART OF THE SOUTHEAST QUARTER OF SECTION 25, TOWNSHIP 37 NORTH, RANGE 6 EAST OF THE THIRD PRINCIPAL MERIDIAN IN KENDALL COUNTY, ILLINOIS, DESCRIBED AS FOLLOWS: COMMENCING AT A FOUND IRON ROD AT THE SOUTHEAST CORNER OF SAID SECTION 25 PER MONUMENT RECORD 200900016871; THENCE ON AN ASSUMED BEARING OF NORTH 01 DEGREES 15 MINUTES 34 SECONDS WEST, 35.21 FEET ALONG THE EAST LINE OF SAID SOUTHEAST QUARTER TO THE SOUTHWEST CORNER OF SECTION 30, TOWNSHIP 37 NORTH, RANGE 7 EAST OF THE THIRD PRINCIPAL MERIDIAN; THENCE NORTH 00 DEGREES 51 MINUTES 12 SECONDS WEST, 1,177.55 FEET ALONG SAID EAST LINE TO THE CENTERLINE OF SCHAEFER ROAD AND THE POINT OF BEGINNING; THENCE SOUTH 86 DEGREES 57 MINUTES 58 SECONDS WEST, 395.52 FEET ALONG SAID CENTERLINE AS MONUMENTED; THENCE SOUTH 03 DEGREES 02 MINUTES 02 SECONDS EAST, 30.39 FEET; THENCE SOUTH 89 DEGREES 22 MINUTES 58 SECONDS EAST, 296.17 FEET; THENCE SOUTH 41 DEGREES 00 MINUTES 22 SECONDS EAST, 105.46 FEET TO THE WESTERLY LINE OF ELDMAN ROAD; THENCE NORTH 87 DEGREES 25 MINUTES 23 SECONDS WEST, 30.01 FEET TO SAID EAST LINE OF THE SOUTHEAST QUARTER; THENCE NORTH 00 DEGREES 51 MINUTES 12 SECONDS WEST, 132.72 FEET ALONG SAID EAST LINE TO THE POINT OF BEGINNING.

**RIVER ROAD DEDICATION:**  
 THAT PART OF THE NORTHEAST QUARTER OF SECTION 36, TOWNSHIP 37 NORTH, RANGE 6 EAST OF THE THIRD PRINCIPAL MERIDIAN IN KENDALL COUNTY, ILLINOIS, DESCRIBED AS FOLLOWS: COMMENCING AT A FOUND IRON ROD AT THE NORTHEAST CORNER OF SAID SECTION 36 PER MONUMENT RECORD 200900016871; THENCE ON AN ASSUMED BEARING OF SOUTH 01 DEGREES 04 MINUTES 12 SECONDS EAST, 976.63 FEET ALONG THE EAST LINE OF SAID NORTHEAST QUARTER TO THE CENTERLINE OF RIVER ROAD AND TO THE POINT OF BEGINNING; THENCE SOUTH 74 DEGREES 24 MINUTES 30 SECONDS WEST, 1314.98 FEET (1,315.05 FEET) ALONG SAID CENTERLINE AS MONUMENTED; THENCE NORTH 01 DEGREES 45 MINUTES 49 SECONDS WEST, 51.33 FEET ALONG THE GRANTOR'S WESTERLY PROPERTY LINE; THENCE NORTH 73 DEGREES 14 MINUTES 27 SECONDS EAST, 105.84 FEET; THENCE NORTH 65 DEGREES 32 MINUTES 27 SECONDS EAST, 105.24 FEET; THENCE NORTH 72 DEGREES 15 MINUTES 44 SECONDS EAST, 295.68 FEET; THENCE NORTH 73 DEGREES 52 MINUTES 48 SECONDS EAST, 302.06 FEET; THENCE NORTH 75 DEGREES 43 MINUTES 45 SECONDS EAST, 242.54 FEET; THENCE NORTH 77 DEGREES 32 MINUTES 47 SECONDS EAST, 203.53 FEET; THENCE NORTH 38 DEGREES 43 MINUTES 34 SECONDS EAST, 57.87 FEET TO THE WESTERLY LINE OF ELDMAN ROAD; THENCE NORTH 88 DEGREES 55 MINUTES 48 SECONDS EAST, 27.45 FEET TO SAID EAST LINE OF THE NORTHEAST QUARTER; THENCE SOUTH 01 DEGREES 04 MINUTES 12 SECONDS EAST, 95.29 FEET ALONG SAID EAST LINE TO THE POINT OF BEGINNING.

**GENERAL NOTES:**

- GENERAL NOTES REFERRING PROPERTY SURVEYED:
- 1) THE SURVEYOR HAS NOT RECEIVED A COPY OF TITLE INSURANCE COMPANY COMMITMENT.
  - 2) DURING THE PROCESS OF COMPLETING THE SURVEY, WE HAVE NOT FOUND ANY EVIDENCE OF RECENT EARTH WORK OR BUILDING CONSTRUCTION OTHER THAN THE RECENT CONSTRUCTION OF ELDMAN ROAD.
  - 3) DURING THE PROCESS OF COMPLETING THE SURVEY AND THE PLATTING, I BELIEVE WE HAVE SHOWN ALL EASEMENTS FOR INGRESS AND EGRESS ON AND OFF THE SURVEYED TRACT OF LAND. THE ONLY ALLOWING ACCESS TO THIS PROPERTY IS LOCATED AT THE ENTRANCE OF THE PARKING LOT FOR THE REST AREA AND TRAILS JUST SOUTH OF SCHAEFER ROAD. THE PAVED ACCESS LOCATION HAS BEEN LOCATED AND SHOWN ON THE ATTACHED DRAWING.
  - 4) THE LEGAL DESCRIPTIONS HEREON SHOWN ARE THE SAME LEGAL DESCRIPTIONS PROVIDED BY THE KENDALL COUNTY FOREST PRESERVE BASED ON DEEDS OF RECORD.
  - 5) THERE IS NO RECORD OF FLOOD ZONES ON THE DESCRIBED PROPERTY ACCORDING TO THE FLOOD INSURANCE RATE MAP AVAILABLE AND DESIGNATED AS 17093C0040G, EFFECTIVE DATE OF 02/04/2009.

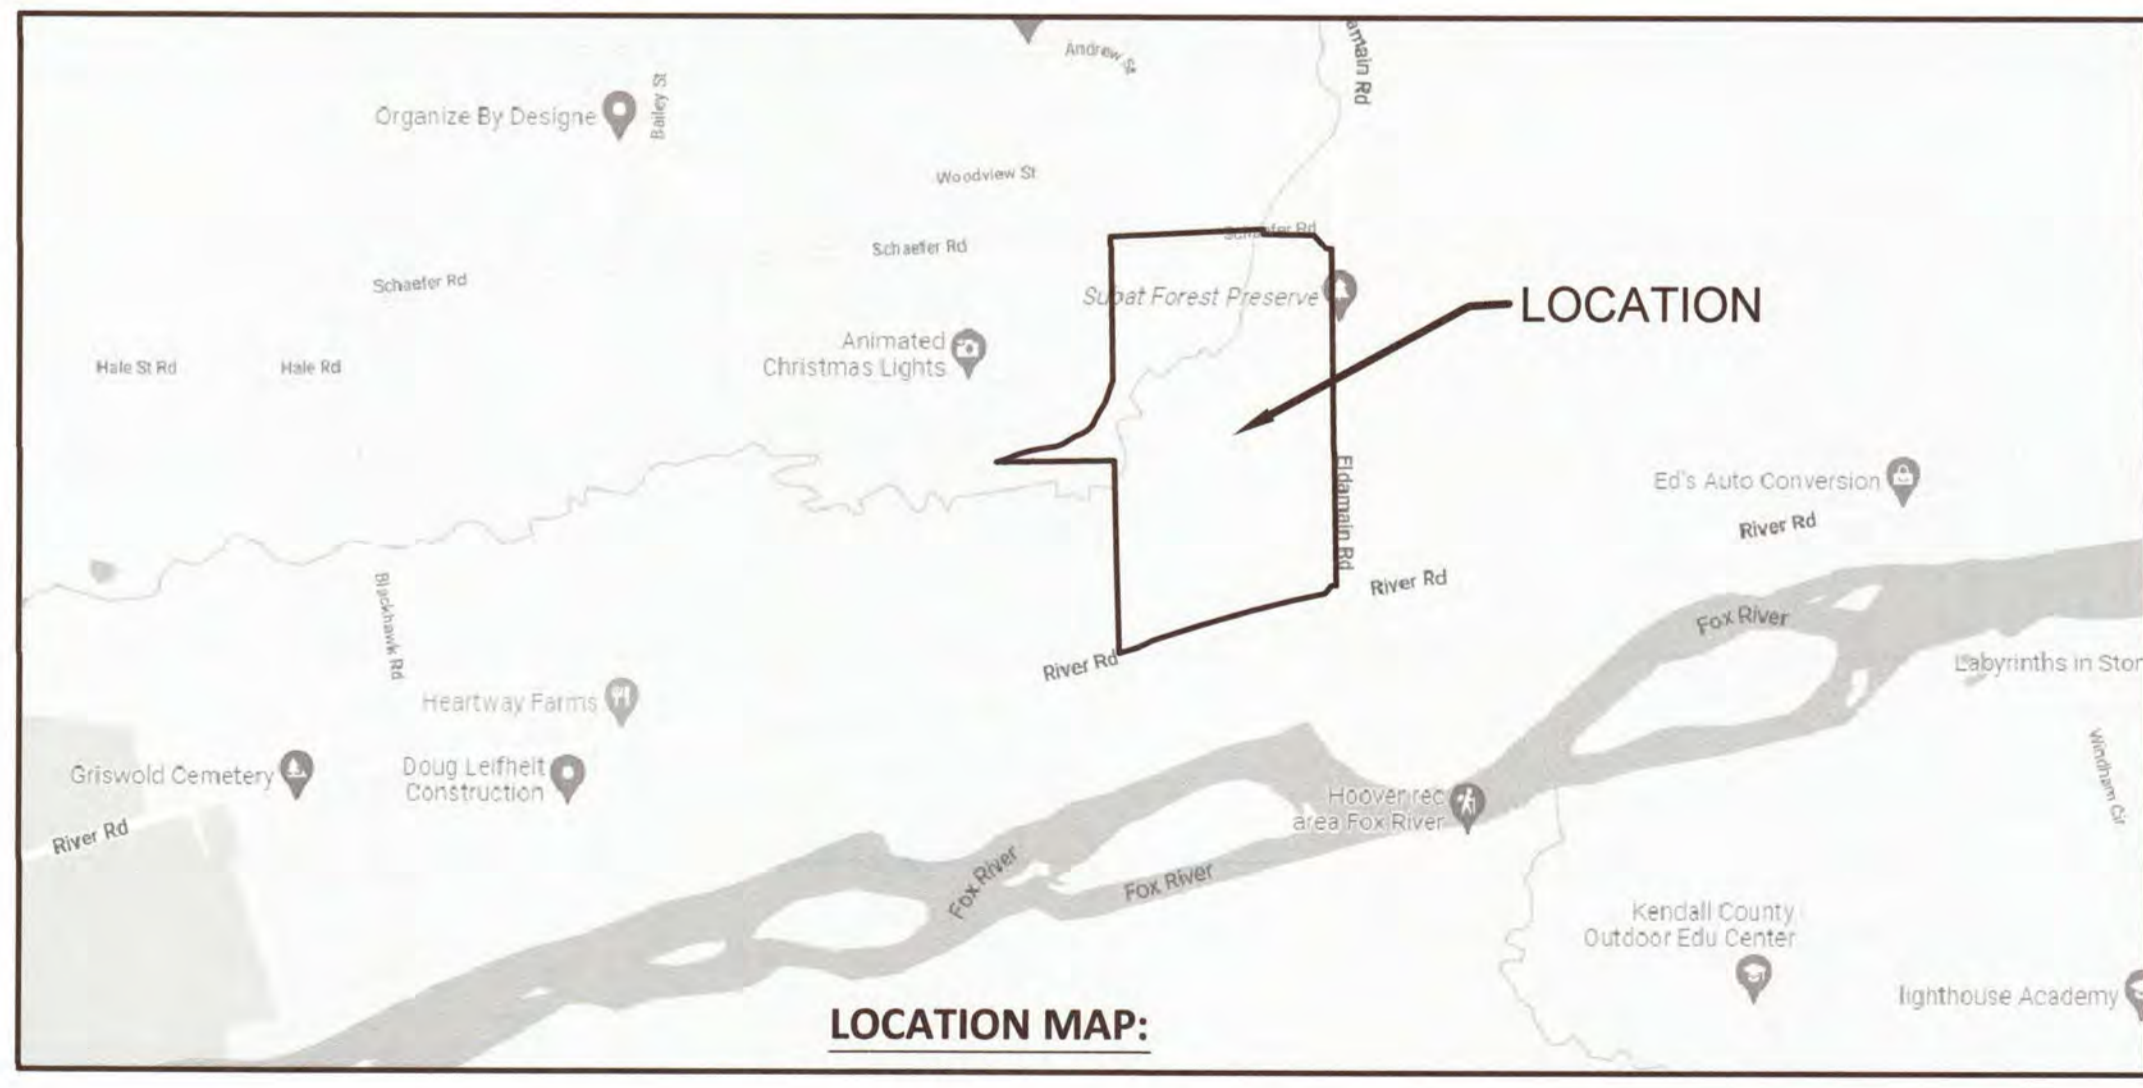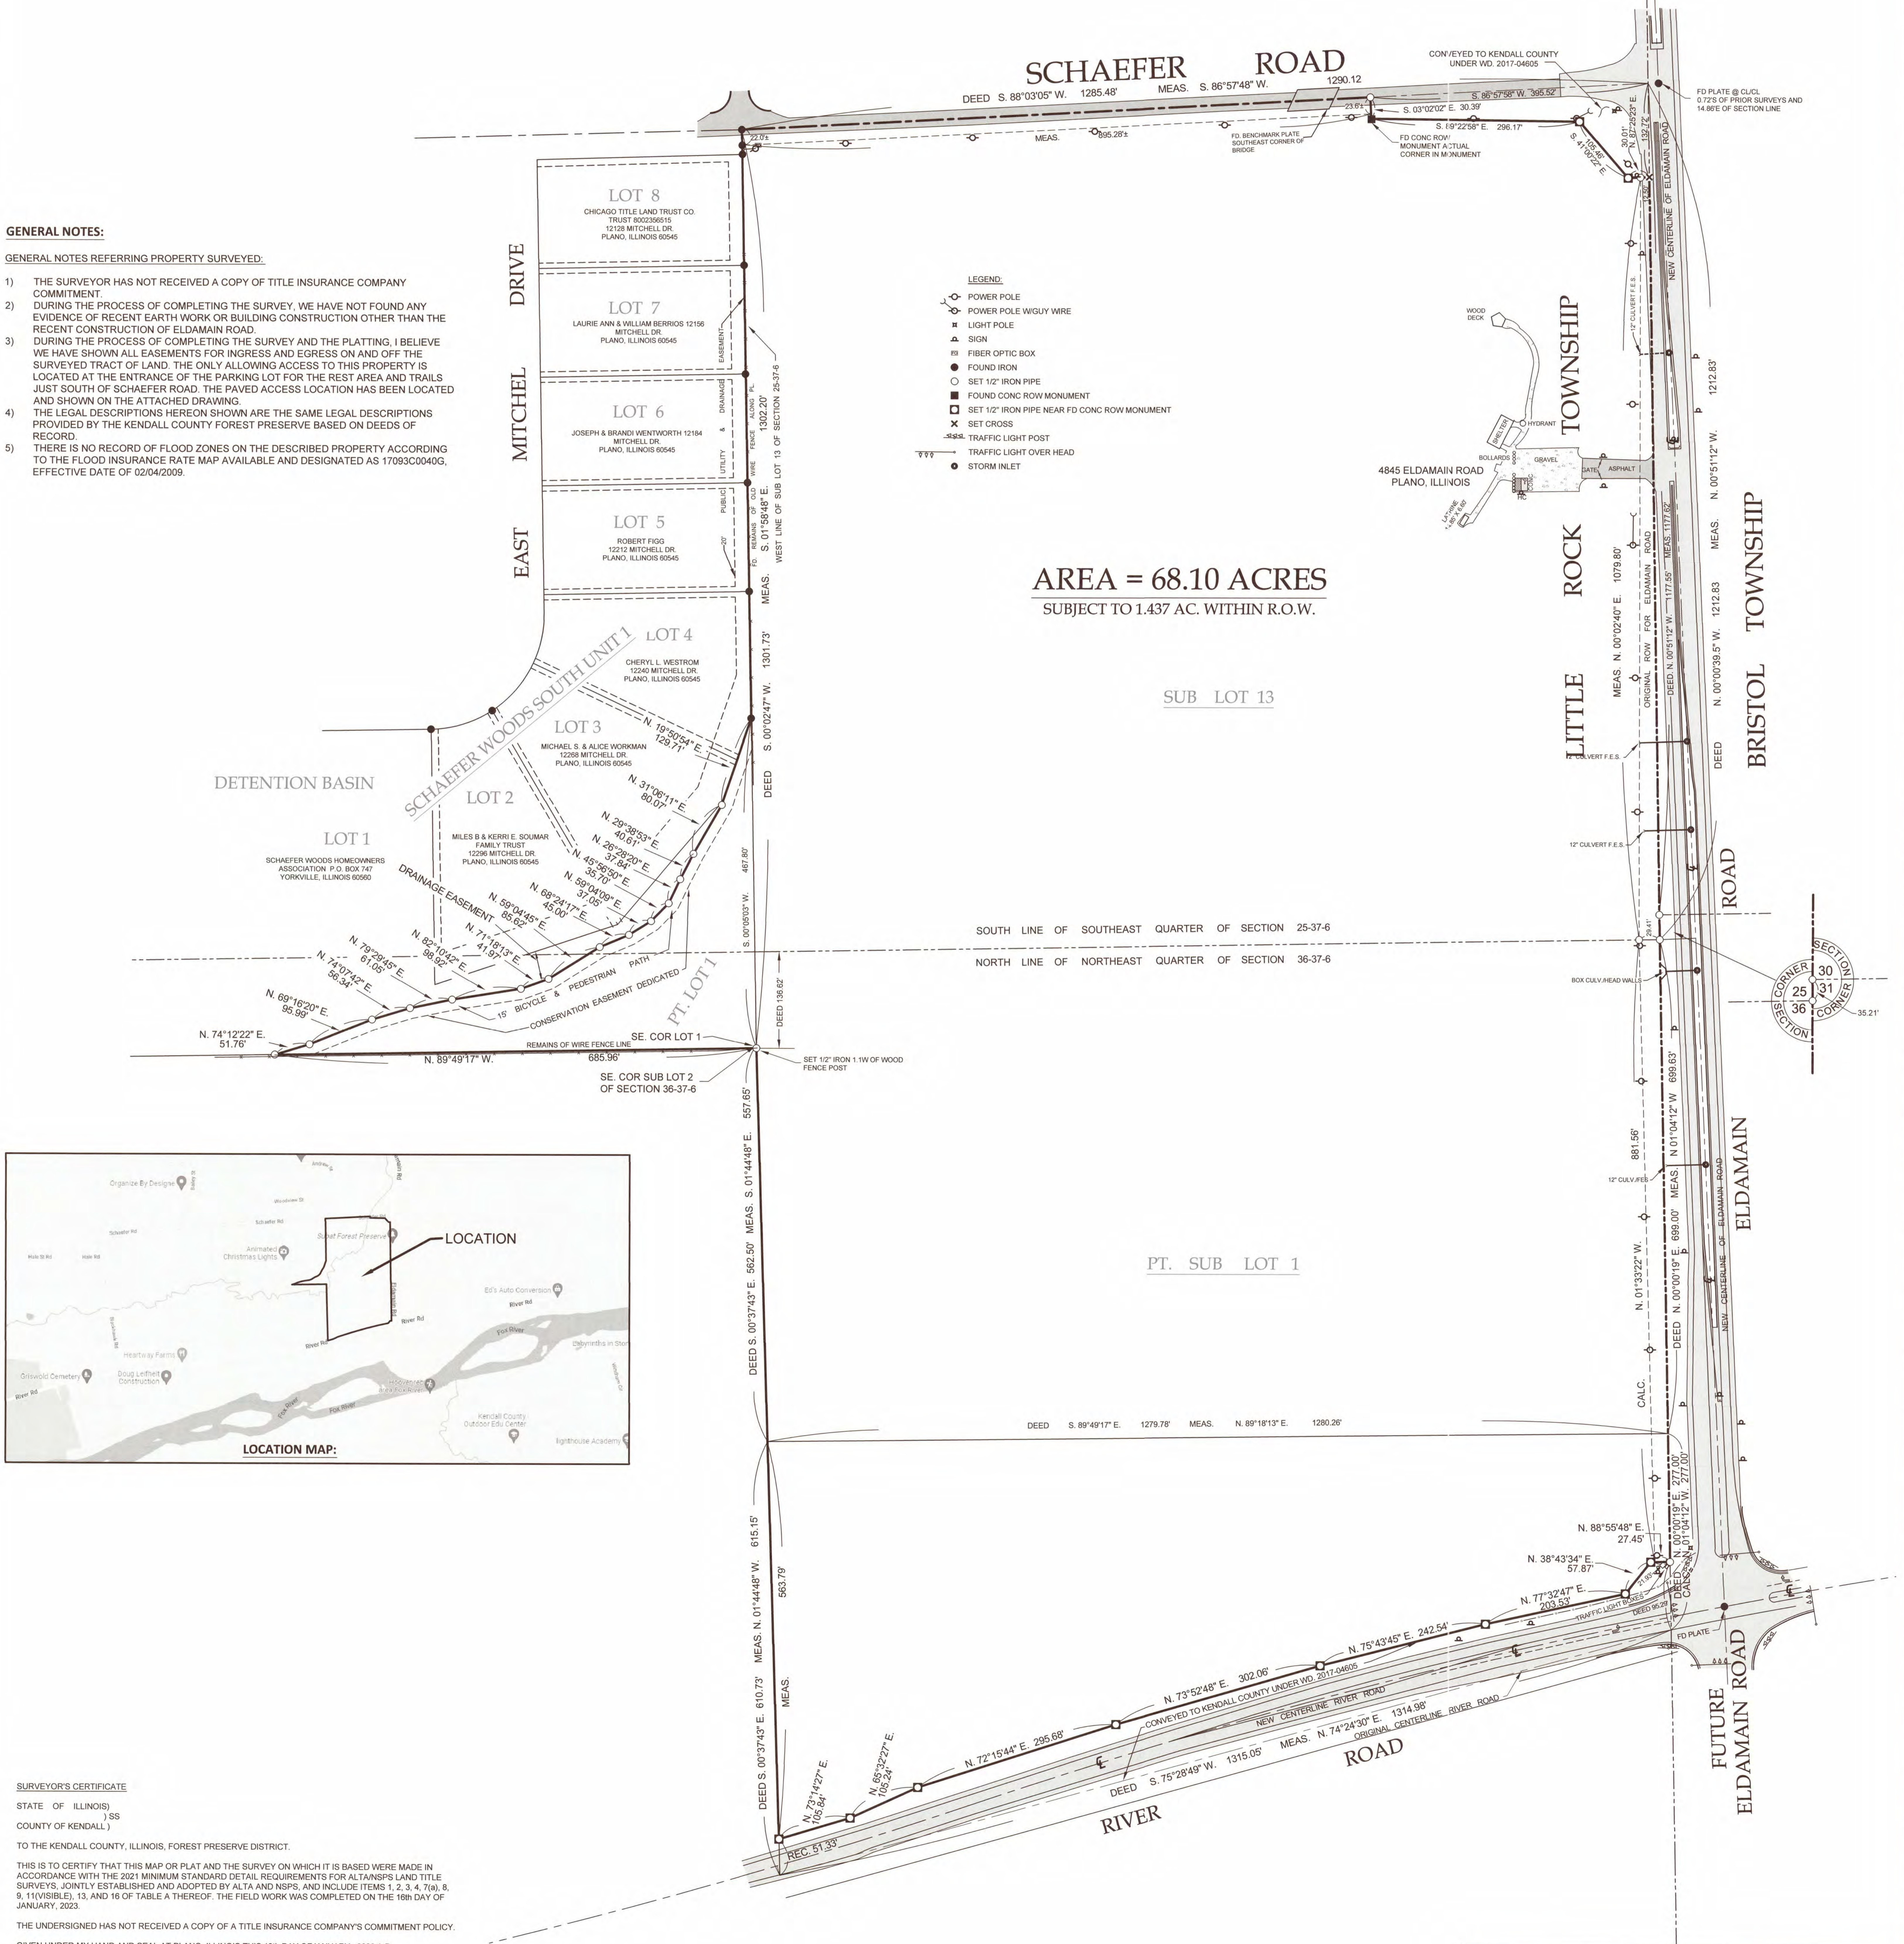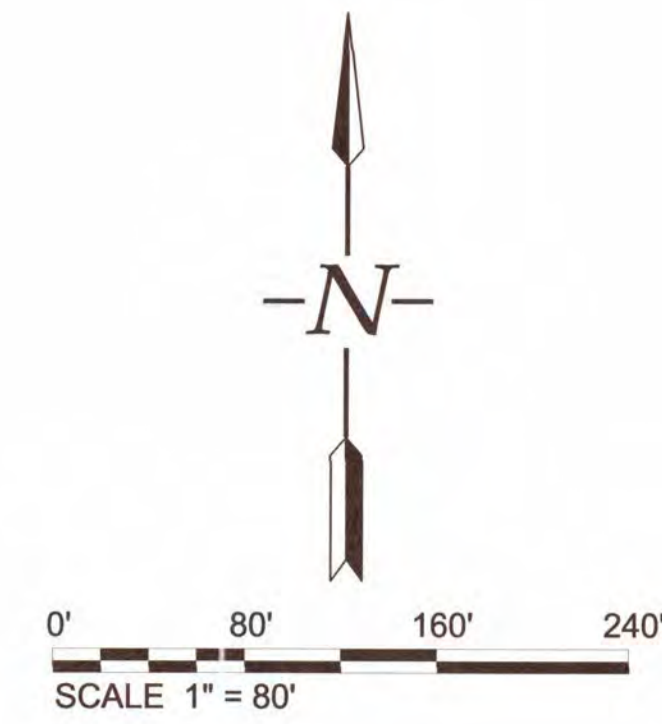

**SURVEYOR'S CERTIFICATE**  
 STATE OF ILLINOIS )  
 COUNTY OF KENDALL )  
 TO THE KENDALL COUNTY, ILLINOIS, FOREST PRESERVE DISTRICT.  
 THIS IS TO CERTIFY THAT THIS MAP OR PLAT AND THE SURVEY ON WHICH IT IS BASED WERE MADE IN ACCORDANCE WITH THE 2021 MINIMUM STANDARD DETAIL REQUIREMENTS FOR ALTA/NSPS LAND TITLE SURVEYS, JOINTLY ESTABLISHED AND ADOPTED BY ALTA AND NSPS, AND INCLUDE ITEMS 1, 2, 3, 4, 7(b), 8, 9, 11(VISIBILE), 13, AND 16 OF TABLE A THEREOF. THE FIELD WORK WAS COMPLETED ON THE 19th DAY OF JANUARY, 2023.  
 THE UNDERSIGNED HAS NOT RECEIVED A COPY OF A TITLE INSURANCE COMPANY'S COMMITMENT POLICY.  
 GIVEN UNDER MY HAND AND SEAL AT PLANO, ILLINOIS THIS 19th DAY OF JANUARY, 2023 A.D.

RONALD D. BAUER  
 ILLINOIS PROFESSIONAL LAND SURVEYOR #2352  
 REGISTRATION EXPIRES 11-30-2024

**rbac** RB & ASSOCIATES CONSULTING, INC  
 4 W MAIN STREET PLANO, IL 60545 (630) 552-7452  
 DESIGN FIRM # 184-004475 www.rb-associates.net



May 30, 2024

Mr. Matt Asselmeier  
Kendall County Planning, Building, & Zoning  
111 West Fox Street  
Yorkville, IL 60560-1498

Subject: Subat Nature Center- WBK Project 19-102.CB

Dear Mr. Asselmeier:

We have received and reviewed the following information for the subject project:

- Subat Nature Center Construction Documents prepared by Kluber, Upland and ERA dated April 11, 2024 and received May 15, 2024.
- Kendall County Comment Response Letter prepared by ERA dated May 14, 2024 and received May 15, 2024.
- Drainage Exhibits prepared by ERA not dated and received May 15, 2024.
- Stormwater Permit Cover Letter, Stormwater Permit and variance support documentation prepared by ERA dated May 7, 2024 and received May 15, 2024.


We have no objection to the issuance of a stormwater variance for this project based on the information submitted. We find the conditions to approve the variance have been met and the project has unique conditions warranting approval of the variance.

Furthermore, we find the stormwater report construction documents submitted to be in general conformance with the County stormwater ordinance. The stormwater permit and construction documents are approved conditioned on resolution of the following comments.

1. Stormwater report – The boardwalk spans a significant drainageway with an upstream area that appears to exceed one square mile. While this is not floodplain please verify the boardwalk will not have an adverse impact on Eldamain Road. (See attached Streamstats Rreport)
2. We have no objections to access to Eldamain Road. Please verify Kendall County Highway Department concurrence.
3. L401 – Verify adequate cover over the 12 “RCP at the northernmost access to Eldamain, Revise as necessary.
4. L501 – The Boardwalk detail depicts the 100 year flood elevation. We concur with the concept presented in the detail. Provide the 100 flow elevation as well as the basis for determining that elevation at the boardwalk.

The applicant's design professionals are responsible for performing and checking all design computations, dimensions, details, and specifications in accordance with all applicable codes and regulations, and obtaining all permits necessary to complete this work. In no way does this review relieve applicant's design professionals of their duties to comply with the law and any applicable codes and regulations, nor does it relieve the Contractors in any way from their sole responsibility for the quality and workmanship of the work and for strict compliance with the permitted plans and specifications. If you have any questions or comments, please contact us at (630) 443-7755.


Sincerely,



Greg Chismark PE  
WBK Engineering, LLC

# StreamStats Report

Region ID: IL  
Workspace ID: IL20240530210850045000  
Clicked Point (Latitude, Longitude): 41.64580, -88.48983  
Time: 2024-05-30 16:09:13 -0500

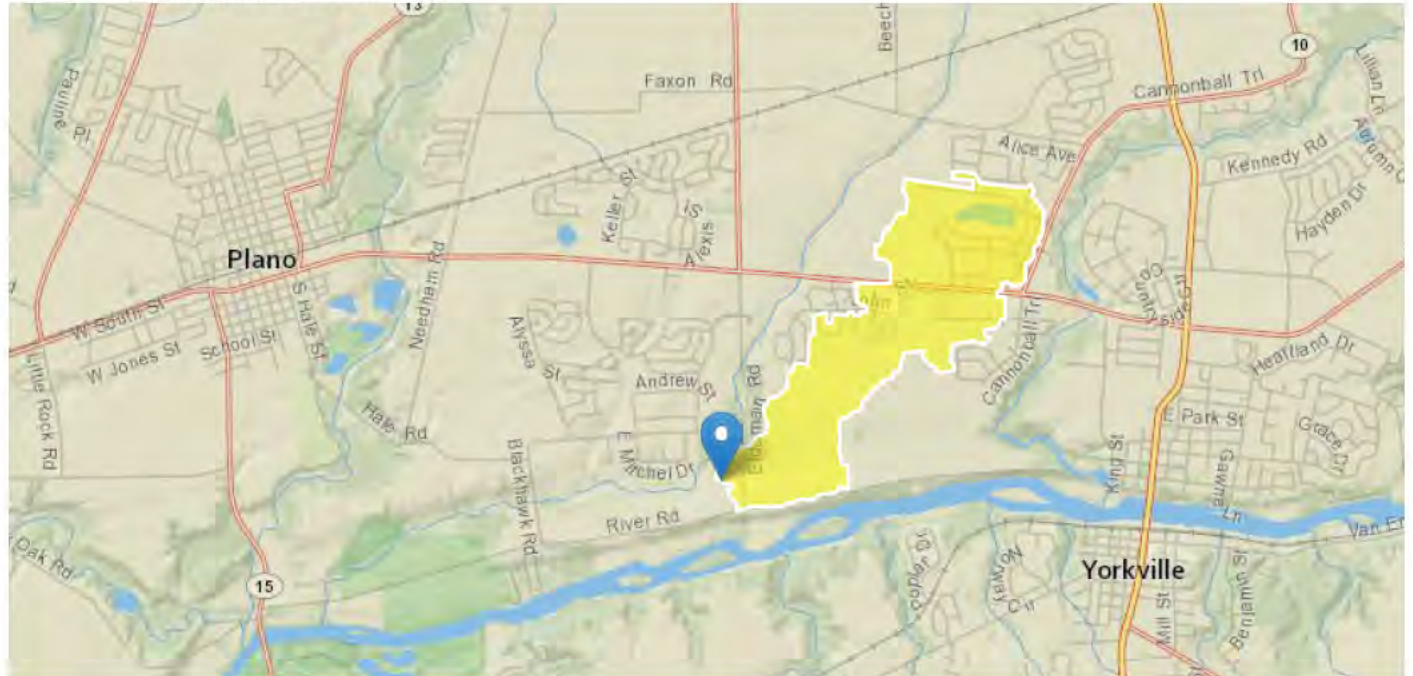

[+ Collapse All](#)

## ➤ Basin Characteristics

Parameter Code	Parameter Description	Value	Unit
DRNAREA	Area that drains to a point on a stream	1.129	square miles
FLC16DVLHM	Fraction of drainage area that is in low to high developed land use classes 22-24 from NLCD 2016	0.3	decimal fraction
FSSURGDC78	Fraction of land area that is in very poorly drained and unknown likely water drainage classes 7 and 8 from SSURGO	0.003	decimal fraction
RELRELF	Basin relief divided by basin perimeter	5.54	feet per mi

## ➤ Peak-Flow Statistics

### Peak-Flow Statistics Parameters [IL Peakflow Region 2 ICT-23-014]

Parameter Code	Parameter Name	Value	Units	Min Limit	Max Limit
DRNAREA	Drainage Area	1.129	square miles	0.07031	1352
FLC16DVLHM	Frac_Lo_Med_Hi_Developed_from_NLCD2016	0.3	decimal fraction	0.002045	0.9692
FSSURGDC78	Fraction_SSURGO_Drainage_Classes_7_and_8	0.003	decimal fraction	0	0.2506
RELRELF	Relative Relief	5.54	feet per mi	0.8122	35.97

### Peak-Flow Statistics Flow Report [IL Peakflow Region 2 ICT-23-014]

PIL: Lower 90% Prediction Interval, PIU: Upper 90% Prediction Interval, ASEp: Average Standard Error of Prediction, SE: Standard Error (other -- see report)

Statistic	Value	Unit	PIL	PIU	ASEp
50-percent AEP flood	77.4	ft <sup>3</sup> /s	36.3	165	46.9
20-percent AEP flood	127	ft <sup>3</sup> /s	58.7	275	47.9
10-percent AEP flood	164	ft <sup>3</sup> /s	73.6	365	49.9
4-percent AEP flood	214	ft <sup>3</sup> /s	92.1	497	52.8
2-percent AEP flood	253	ft <sup>3</sup> /s	105	611	55.6
1-percent AEP flood	294	ft <sup>3</sup> /s	118	734	58
0.5-percent AEP flood	335	ft <sup>3</sup> /s	129	867	60.5
0.2-percent AEP flood	392	ft <sup>3</sup> /s	146	1050	63.4

#### *Peak-Flow Statistics Citations*

**Over, T.M., Marti, M.K., O'Shea, P.S., Sharpe, J.B. 2023, Estimating peak-flow quantiles for selected annual exceedance probabilities in Illinois (Report No. FHWA-ICT-23-014). Illinois Center for Transportation. ( <https://doi.org/10.36501/0197-9191/23-019> )**

USGS Data Disclaimer: Unless otherwise stated, all data, metadata and related materials are considered to satisfy the quality standards relative to the purpose for which the data were collected. Although these data and associated metadata have been reviewed for accuracy and completeness and approved for release by the U.S. Geological Survey (USGS), no warranty expressed or implied is made regarding the display or utility of the data for other purposes, nor on all computer systems, nor shall the act of distribution constitute any such warranty.

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USGS Product Names Disclaimer: Any use of trade, firm, or product names is for descriptive purposes only and does not imply endorsement by the U.S. Government.

Application Version: 4.20.1

StreamStats Services Version: 1.2.22

NSS Services Version: 2.2.1



**ORDINANCE NUMBER 2024 - \_\_\_\_\_**

**GRANTING A VARIANCE TO THE KEDALL COUNTY  
STORMWATER MANAGEMENT ORDINANCE FOR THE PROPERTY IDENTIFIED BY  
PARCEL IDENTIFICATION NUMBERS 01-25-400-009, 01-36-200-022, AND 01-36-200-025,  
LOCATED AT 4845 ELDAMAIN ROAD IN LITTLE ROCK TOWNSHIP AND OWNED BY  
THE KENDALL COUNTY FOREST PRESERVE DISTRICT AND ALSO KNOWN AS THE  
SUBAT FOREST PRESERVE**

WHEREAS, Section 900 of the Kendall County Stormwater Management Ordinance allows the County to grant variances from strict compliance with specific provisions of said Ordinance when such compliance is impossible or impracticable; and

WHEREAS, Section 906 of the Kendall County Stormwater Management Ordinance allows the County to impose conditions or limitations on the granting of a variance; and

WHEREAS, on or about May 17, 2024, the Kendall County Forest Preserve District submitted an application for a variance to Section 203 of the Kendall County Stormwater Management Ordinance regarding applicability of site runoff storage requirements; and

WHEREAS, the property impacted by the variance, hereinafter referred to as “the subject property” is identified by parcel identification numbers 01-25-400-009, 01-36-200-022, and 01-36-200-025 and is located at 4845 Eldamain Road in Little Rock Township, and is also known as the Subat Forest Preserve; the legal description of the property is attached hereto as Exhibit A; and

WHEREAS, the property is owned by the Kendall County Forest Preserve District and shall hereinafter be referred to as “the Petitioner”; and

WHEREAS, the Petitioner desires to create trail that will create new impervious surface totaling 19,930 square feet which they would like not included in the total development area of 36,850 square feet at the subject property; and

WHEREAS, the proposed development is for public use and the development of the forest preserve is planned, funded and facilitated as a public forest preserve by the Petitioner; and

WHEREAS, the Petitioner desires to protect avoid unnecessary disturbance of restored prairie habitats and native trees that reside within the subject property; and

WHEREAS, following due and proper notice by publication in the Kendall County Record on May 23, 2024, due and proper notification of the United City of Yorkville on May 20, 2024, due and proper notification to the City of Plano on May 20, 2024, due and proper notification to the Village of Sugar Grove on May 20, 2024, and due and proper notification to all of the property owners of record owning property within two hundred fifty feet of the subject property on May 20, 2024, the Kendall County Stormwater Management Oversight Committee conducted a public hearing on June 18, 2024, at 9:00 a.m., in the County Office Building at 111 W. Fox Street in Yorkville, at which the Petitioner’s representatives presented evidence, testimony, and exhibits in support of the requested variance and **zero**

member of the public testified in favor of the request and **zero** members of the public testified in opposition to the request; and

WHEREAS, based on the evidence, testimony, and exhibits, the Kendall County Stormwater Management Oversight Committee has made their Findings of Fact and recommended **approval** of the variance with **conditions** as set forth in the Findings of Fact and Recommendation of the Kendall County Stormwater Management Oversight Committee, dated June 18, 2024, a true and correct copy of which is attached hereto as Exhibit B; and

WHEREAS, this variance shall be treated as a covenant running with the land and is binding on the successors, heirs, and assigns as to the same special use conducted on the property; and

WHEREAS, the Kendall County Board has considered the standards and finds that said petition is in conformance with the provisions and intent of the Kendall County Stormwater Management Ordinance.

NOW, THEREFORE, BE IT ORDAINED, BY THE COUNTY BOARD OF KENDALL COUNTY, ILLINOIS, as follows:

1. The Findings of Fact and Recommendation of the Kendall County Stormwater Management Oversight Committee attached hereto as Exhibit B is hereby accepted and the Findings of Fact set forth therein are hereby adopted as the Findings of Fact and Conclusions of this Kendall County Board.
2. The Kendall County Board hereby grants approval of the Petitioner's petition for a variance to Section 203 of the Kendall County Stormwater Management Ordinance regarding applicability of site runoff storage requirements subject to the following conditions:
  - A. The site shall be developed substantially in accordance with the attached site plan, attached hereto as Exhibit C.
  - B. The property owner shall follow all applicable Federal, State, and Local laws related to the development of this property as a forest preserve.
  - C. Failure to comply with one or more of the above conditions or restrictions could result in the amendment or revocation of this variance
  - D. If one or more of the above conditions is declared invalid by a court of competent jurisdiction, the remaining conditions shall remain valid.

IN WITNESS OF, this Ordinance has been enacted by majority vote of the Kendall County Board this 18<sup>th</sup> day of June, 2024.

Attest:

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Debbie Gillette  
Kendall County Clerk

---

Matt Kellogg  
Kendall County Board Chairman

EXHIBIT A:  
SUBAT FOREST PRESERVE LEGAL DESCRIPTION  
KENDALL COUNTY FOREST PRESERVE DISTRICT, KENDALL COUNTY, ILLINOIS

SOUTHERLY PARCEL

THAT PART OF THE NORTHEAST QUARTER OF SECTION 36, TOWNSHIP 37 NORTH, RANGE 6 EAST OF THE THIRD PRINCIPAL MERIDIAN, BEING DESCRIBED AS FOLLOWS: COMMENCING AT THE NORTHEAST CORNER OF SAID SECTION 36; THENCE SOUTH 00 DEGREES 00 MINUTES 19 SECONDS WEST ALONG THE EAST LINE OF SAID QUARTER SECTION, 699.00 FEET FOR THE POINT OF BEGINNING; THENCE NORTH 89 DEGREES 49 MINUTES 17 SECONDS WEST, 1279.78 FEET; THENCE SOUTH 00 DEGREES 37 MINUTES 43 SECONDS EAST, 610.73 FEET TO THE CENTERLINE OF RIVER ROAD; THENCE NORTH 75 DEGREES 28 MINUTES 49 SECONDS EAST ALONG SAID CENTERLINE, 1315.05 FEET TO SAID EAST LINE OF SECTION 36; THENCE NORTH 00 DEGREES 00 MINUTES 19 SECONDS EAST ALONG SAID EAST LINE, 277.00 FEET TO THE POINT OF BEGINNING ALL IN THE TOWNSHIP OF LITTLE ROCK, KENDALL COUNTY, ILLINOIS.

NORTHERLY PARCEL

THAT PART OF THE SOUTHEAST QUARTER OF SECTION 25 AND PART OF THE NORTHEAST QUARTER OF SECTION 36, TOWNSHIP 37 NORTH, RANGE 6 EAST OF THE THIRD PRINCIPAL MERIDIAN BY BEING DESCRIBED BY BEGINNING AT THE SOUTHEAST CORNER OF SAID SECTION 25; THENCE NORTH 00 DEGREES 00 MINUTES 39.5 SECONDS WEST ALONG THE EAST LINE OF SAID QUARTER SECTION, 1212.83 FEET TO THE CENTERLINE OF SCHAEFER ROAD; THENCE SOUTH 88 DEGREES 03 MINUTES 05 SECONDS WEST ALONG SAID CENTERLINE, 1285.48 FEET TO THE WEST LINE OF SUB LOT 13 OF SAID SECTION 25 AS SHOWN ON PAGE 36 OF PLAT BOOK 4; THENCE SOUTH 00 DEGREES 02 MINUTES 47 SECONDS WEST ALONG SAID WEST LINE, 1301.73 FEET MORE OR LESS TO A POINT LYING 136.62 FEET SOUTH OF THE NORTH LINE OF SAID SECTION 36, SAID POINT BEING THE SOUTHEAST CORNER OF SUB LOT 2 OF SAID SECTION 36 AS SHOWN ON PAGE 36 OF PLAT BOOK 4; THENCE SOUTH 00 DEGREES 37 MINUTES 43 SECONDS EAST PARALLEL WITH THE EAST LINE OF SAID SUB LOT 3 OF SAID SECTION 36, 562.50 FEET; THENCE SOUTH 89 DEGREES 49 MINUTES 17 SECONDS EAST, 1279.78 FEET TO A POINT ON THE EAST LINE OF SAID SECTION 36; THENCE NORTH 00 DEGREES 00 MINUTES 19 SECONDS EAST ALONG SAID EAST LINE, 699.00 FEET TO THE POINT OF BEGINNING IN THE TOWNSHIP OF LITTLE ROCK, KENDALL COUNTY, ILLINOIS.

Exhibit B

The Kendall Stormwater Management Planning Committee approved the following Findings of Fact and Recommendation at their meeting on June 18, 2024, by a vote of ten (10) in favor and zero (0) in opposition.

**FINDINGS OF FACT**

The variance will not increase the probability of flood damage or create an additional threat to the public health, safety or welfare.

The variance requested is the minimum relief necessary to accomplish the objectives of the development without compromising the objectives of Section 102 of the Kendall Stormwater Management Ordinance.

The variance will not result in a reduction of water quality benefits as compared to compliance with ordinance requirements.

The variance is not requested solely for the purpose of reducing site runoff storage requirements.

The variance shall not cause conveyance of stormwater from the project to increase peak discharges beyond design capacity of existing offsite conveyance facilities for any storm event from the 2-year to the 100-year recurrence frequency.

**RECOMMENDATION**

Approval with the following conditions and restrictions:

1. The site shall be developed substantially in accordance with the submitted site plan.
2. The property owner shall follow all applicable Federal, State, and Local laws related to the development of this property as a forest preserve.
3. Failure to comply with one or more of the above conditions or restrictions could result in the amendment or revocation of this variance.
4. If one or more of the above conditions is declared invalid by a court of competent jurisdiction, the remaining conditions shall remain valid.

GENERAL NOTES

ALL CONSTRUCTION SHALL BE IN ACCORDANCE WITH THE REQUIREMENTS SET FORTH BY IBC 2018 EDITION AND SHALL CONFORM TO ALL OTHER APPLICABLE MUNICIPAL, STATE, AND FEDERAL REGULATIONS INCLUDING THE ILLINOIS ACCESSIBILITY CODE (2018) AND THE AMERICANS WITH DISABILITIES ACT.

A. GENERAL NOTES

- 1. ALL CONTRACTORS ARE REQUIRED TO VISIT THE SITE AND BE KNOWLEDGEABLE REGARDING EXISTING CONDITIONS AND THEIR EFFECT ON THE PROPOSED WORK. CONTRACTORS SHALL VERIFY AND BE RESPONSIBLE FOR ANY CONDITIONS REQUIRING MODIFICATION BEFORE PROCEEDING WITH THE PROJECT.
2. NOTIFY THE OWNER'S REPRESENTATIVE A MINIMUM OF 72 HOURS PRIOR TO THE INTERRUPTION OF ANY UTILITY.
3. PROTECT AND KEEP IN SERVICE ACTIVE UNDERGROUND UTILITIES, PIPES, OR CONDUITS, WHETHER INDICATED ON THE DRAWINGS OR NOT, UNLESS SPECIFICALLY CALLED FOR TO BE REMOVED, RELOCATED, OR DISCONNECTED AND ABANDONED.
4. CONTRACTORS AND SUBCONTRACTORS SHALL COORDINATE THEIR WORK WITH THAT OF OTHER TRADES.
5. NO WORK WILL BE PERMITTED TO BE INSTALLED WITHOUT RECEIPT AND SUBSEQUENT REVIEW OF FULL AND COMPLETE SUBMITTALS BY THE ARCHITECT/ENGINEER.
6. DO NOT SCALE DRAWINGS, DIMENSIONS INDICATED TAKE PRECEDENCE OVER SCALE.
7. VERIFY ALL DIMENSIONS AND ELEVATIONS IN THE FIELD, WHERE DISCREPANCIES ARE FOUND BETWEEN DIMENSIONS OR ELEVATIONS SHOWN AND ACTUAL FIELD CONDITIONS, NOTIFY ARCHITECT/ENGINEER.
8. WHERE CONFLICTS MAY EXIST BETWEEN THE REQUIREMENTS OF PORTIONS OF THE CONTRACT DOCUMENTS, THE GREATER QUANTITY, HIGHER QUALITY OR MORE STRINGENT REQUIREMENT SHALL GOVERN. THEREFORE, BY EXECUTING A CONTRACT FOR CONSTRUCTION, THE CONTRACTOR AGREES THAT, IF IT RAISED NO QUESTIONS REGARDING SUCH CONFLICTS DURING THE BIDDING PROCESS, AND IN THE ABSENCE OF A CLARIFYING ADDENDUM ISSUED DURING THE BIDDING PROCESS, IT HAS VOLUNTEERED TO COMPLY WITH THE MORE EXPENSIVE REQUIREMENT AS PART OF ITS BASE BID AND IS NOT ENTITLED TO ANY ADDITIONAL COMPENSATION TO RESOLVE THE CONFLICT.
9. THE CONTRACT DOCUMENTS REQUIRE THE CONTRACTOR TO FURNISH AND INSTALL COMPLETE PRODUCTS, SYSTEMS AND SERVICES. BY EXECUTING A CONTRACT FOR CONSTRUCTION, THE CONTRACTOR AGREES THAT THE DRAWINGS SET FORTH THE DESIGN INTENT AND, THEREFORE, MAY NOT EXPRESSLY DEPICT EVERY LENGTH, SEGMENT, PIECE, PART, COMPONENT OR UNIT OF A PRODUCT, SYSTEM OR SERVICE. THE CONTRACTOR FURTHER AGREES THAT, AS PART OF ITS BID, IT MUST FURNISH AND INSTALL EVERY LENGTH, SEGMENT, PIECE, PART, COMPONENT OR UNIT OF A PRODUCT, SYSTEM OR SERVICE AND, CONSEQUENTLY, THE CONTRACTOR IS NOT ENTITLED TO ANY ADDITIONAL COMPENSATION FOR ANY LENGTH, SEGMENT, PIECE, PART COMPONENT OR UNIT OF A PRODUCT, SYSTEM OR SERVICE BECAUSE IT IS NOT EXPRESSLY DEPICTED HEREIN.
10. THE CONTRACT DOCUMENTS REQUIRE THE CONTRACTOR TO INSTALL A CONTINUOUS AIR BARRIER THROUGHOUT THE BUILDING ENVELOPE, IN COMPLIANCE WITH THE 2018 INTERNATIONAL ENERGY CONSERVATION CODE (IECC), SECTION C402.5 - AIR LEAKAGE. CONTRACTOR AND ITS SUBCONTRACTORS AGREE TO BE JOINTLY AND SEPARATELY RESPONSIBLE FOR COORDINATING AND VERIFYING THAT ALL SOURCES OF AIR LEAKAGE IN THE BUILDING THERMAL ENVELOPE ARE CAULKED, GASKETED, WEATHER STRIPPED, OR OTHERWISE APPROPRIATELY SEALED AIR-TIGHT USING CODE-COMPLIANT ALTERNATIVES AS APPROPRIATE FOR EACH MATERIAL AND CONDITION/LOCATION. PROVIDE AIR BARRIER MATERIALS HAVING AN AIR PERMEABILITY NO GREATER THAN 0.004 cfm/ft² (L/9m²) UNDER PRESSURE DIFFERENTIAL OF 0.3 INCHES WATER GAUGE (75 Pa) WHEN TESTED IN ACCORDANCE WITH ASTM E2178, AND COMPLY WITH IECC 2018 SECTION C402.5.1.2.1 - MATERIALS.

STANDARD ABBREVIATIONS

Table with 6 columns of abbreviations and their corresponding full names. Includes categories like ANCHOR BOLT, ACROUSTICAL CEILING PANEL, ELECTRIC WATER HEATER, etc.

DRAFTING SYMBOLS AND MATERIALS LEGEND. Table listing symbols for DETAIL CALLOUT, EXTERIOR ELEVATION, INTERIOR ELEVATION, SECTION REFERENCE, COLUMN NO., REFERENCE LINE NO., LOCATION ELEVATION, ROOM NUMBER, DOOR NO. NEW, DOOR NO. EXISTING, NOMINAL THICKNESS, KEYNOTE IDENTIFICATION, WINDOW TYPE IDENTIFICATION, TOILET ACCESSORY IDENTIFICATION, SPOT ELEVATION, and FIRE-RATING.

DRAFTING SYMBOLS AND MATERIALS LEGEND



PROJECT

SUBAT NATURE CENTER
ELDAMAIN RD.
PLANO, IL 60545

OWNER

KENDALL COUNTY FOREST PRESERVE
110 W MADISON ST
YORKVILLE, IL 60560

ARCHITECT/ENGINEER

KLUBER ARCHITECTS + ENGINEERS
41 W BENTON STREET
AURORA, ILLINOIS 60506
TEL (630) 406-1213
FAX (630) 406-9472
www.kluberinc.com

REQUIRED CODE COMPLIANCE INFORMATION

REQUIRED PLAN COVER SHEET INFORMATION FOR REVIEW UNDER 2018 INTERNATIONAL CODES, STATE OF ILLINOIS ACCESSIBILITY CODE, AND THE STATE OF ILLINOIS PLUMBING CODE CODE REVIEW DATA




GENERAL STATEMENT OF OVERALL PROJECT SCOPE AND INTENT: PROJECT CONSISTS OF AN OUTDOOR NATURE CENTER WITH TWO SMALL SHEDS AND NO HABITABLE INTERIOR SPACES. THE PROJECT SHALL BE CONSIDERED USE GROUP U.

- A. USE AND OCCUPANCY GROUP(S) CLASSIFICATION: U.
B. TYPE OF CONSTRUCTION: VB
C. SQUARE FOOTAGE OF BUILDING: 1,583 SF\* INCLUDING UNDER CANOPY AND SHEDS. ALLOWABLE SQUARE FOOTAGE: 5,500 SF.
D. OCCUPANT LOAD BASED ON INTERNATIONAL BUILDING CODE: 83 ASSEMBLY AND ACCESSORY STORAGE OCCUPANCY.
E. OCCUPANT LOAD BASED ON ILLINOIS PLUMBING CODE: NOT APPLICABLE.
F. DESIGNED LIVE LOADS: 20 PSF.
G. THE DESIGN PROFESSIONALS IN RESPONSIBLE CHARGE ARE IDENTIFIED IN THE SEALS AND CERTIFICATES AREA, BELOW.

SEALS & CERTIFICATIONS

I HAVE PREPARED, OR CAUSED TO BE PREPARED UNDER MY DIRECT SUPERVISION, THE ATTACHED PLANS AND SPECIFICATIONS AND STATE THAT TO THE BEST OF MY KNOWLEDGE AND BELIEF, AND TO THE EXTENT OF MY CONTRACTUAL OBLIGATION, THEY ARE IN COMPLIANCE WITH IBC 2018 EDITION, THE ENVIRONMENTAL BARRIERS ACT AND THE ILLINOIS ACCESSIBILITY CODE.

KLUBER, INC. ILLINOIS PROFESSIONAL DESIGN FIRM LICENSE #184-001284

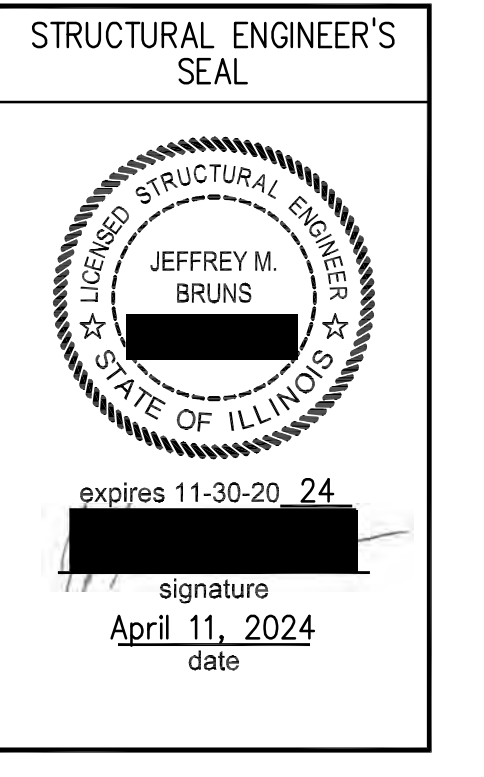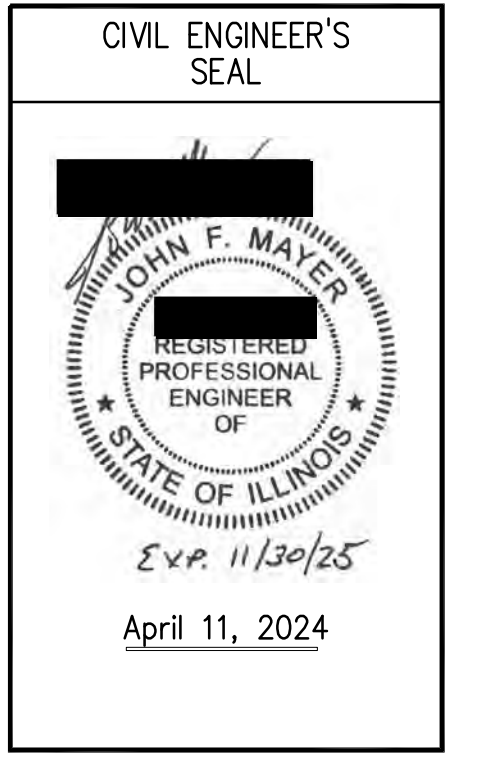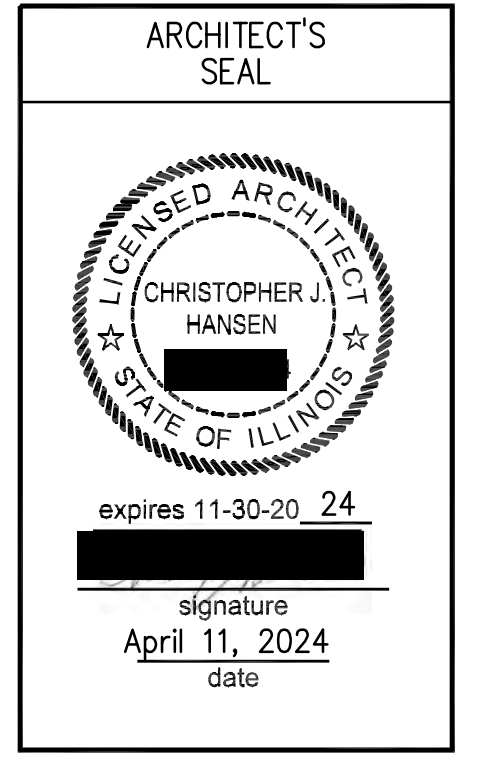

"G" SERIES, "A" SERIES

"G" SERIES, "L" SERIES

"G" SERIES, "S" SERIES

INDEX OF DRAWINGS

Table listing drawing numbers and descriptions: G100 COVER SHEET, GENERAL NOTES, SYMBOLS, & DRAWING INDEX; G201 ACCESSIBILITY REQUIREMENTS; L100 EXISTING CONDITIONS & REMOVAL PLANS; L101 STORMWATER POLLUTION PREVENTION PLAN; L200 LAYOUT PLAN - OVERALL; L201 LAYOUT, DIMENSION, & GRADING PLAN - NORTH TRAIL; L202 LAYOUT, DIMENSION, & GRADING PLAN - SOUTH TRAIL; L203 LAYOUT PLAN - PARKING LOT ENLARGEMENT; L204 LAYOUT PLAN - NATURE CENTER ENLARGEMENT; L301 DIMENSION PLAN - PARKING LOT ENLARGEMENT; L302 DIMENSION PLAN - NATURE CENTER ENLARGEMENT; L401 GRADING PLAN - PARKING LOT ENLARGEMENT; L402 GRADING PLAN - NATURE CENTER ENLARGEMENT; L500 CONSTRUCTION DETAILS; L501 CONSTRUCTION DETAILS; A010 ARCHITECTURAL SITE PLAN; A310 ARCHITECTURAL FIRST FLOOR PLAN; A330 ROOF PLAN; A600 BUILDING SECTIONS; A700 EXTERIOR BUILDING ELEVATIONS; A701 EXTERIOR BUILDING ELEVATIONS; A800 DOOR, FRAME & HARDWARE SCHEDULES; A1200 SECTION DETAILS; S010 GENERAL NOTES CODE & LOADING, TESTING & INSPECTIONS; S310 FOUNDATION & SLAB PLAN, SECTIONS AND DETAILS; S311 GEOMETRIC SLAB PLAN & FOUNDATION SECTIONS AND DETAILS; S320 ROOF FRAMING PLANS, SECTIONS AND DETAILS; S800 SCHEDULES, SECTIONS & DETAILS



Kluber, Inc.
Aurora, Illinois 60506
Tel. (630) 406-1213
Bloomington, Illinois 61704
Tel. (309) 430-6460
www.kluberinc.com

SUBAT NATURE CENTER
KENDALL COUNTY FOREST PRESERVE DISTRICT
4675 ELDAMAIN ROAD
PLANO, IL 60545

APPLICABLE CODES


- 2018 INTERNATIONAL BUILDING CODE
2018 INTERNATIONAL MECHANICAL CODE
2018 INTERNATIONAL FUEL AND GAS CODE
2006 INTERNATIONAL FIRE CODE
2017 NATIONAL ELECTRICAL CODE
LOCAL AMENDMENTS TO THE ABOVE CODES
2014 ILLINOIS PLUMBING CODE
2021 ILLINOIS ENERGY CONSERVATION CODE (2021 INTERNATIONAL ENERGY CONSERVATION CODE W/STATE AMENDMENTS)
2018 ILLINOIS ACCESSIBILITY CODE

Table with columns: ISSUED, DATE, OWNER REVIEW, INITIALS, BID DOCUMENTS.


JOB NO. 23-429-1495
DRAWN SKF
CHECKED CJH
APPROVED CJH

SHEET TITLE
COVER SHEET, GENERAL NOTES, SYMBOLS AND DRAWING INDEX


SHEET NUMBER
G100

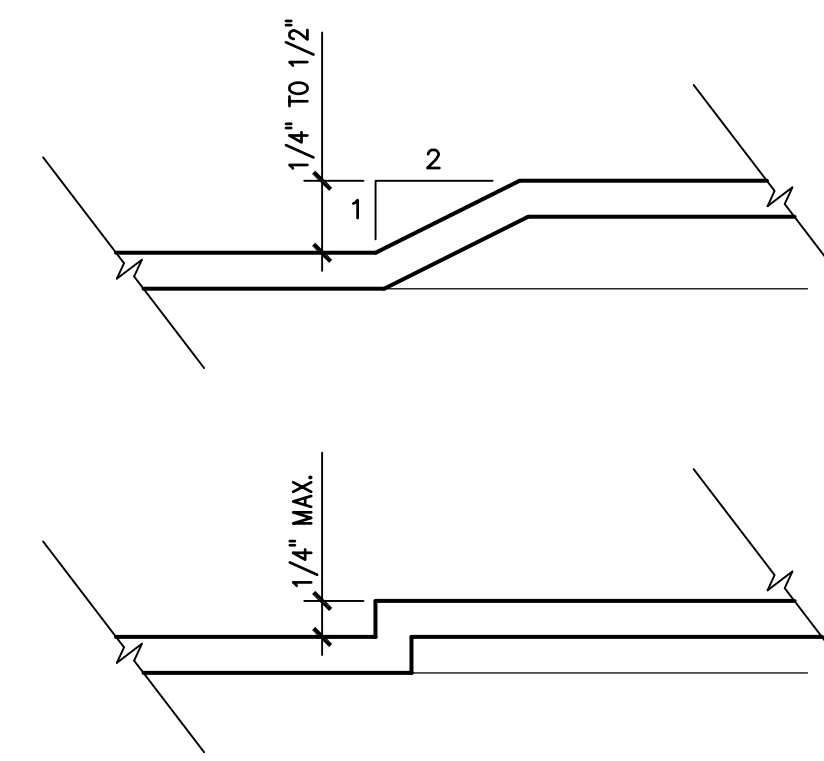


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SCALE: NONE **7**

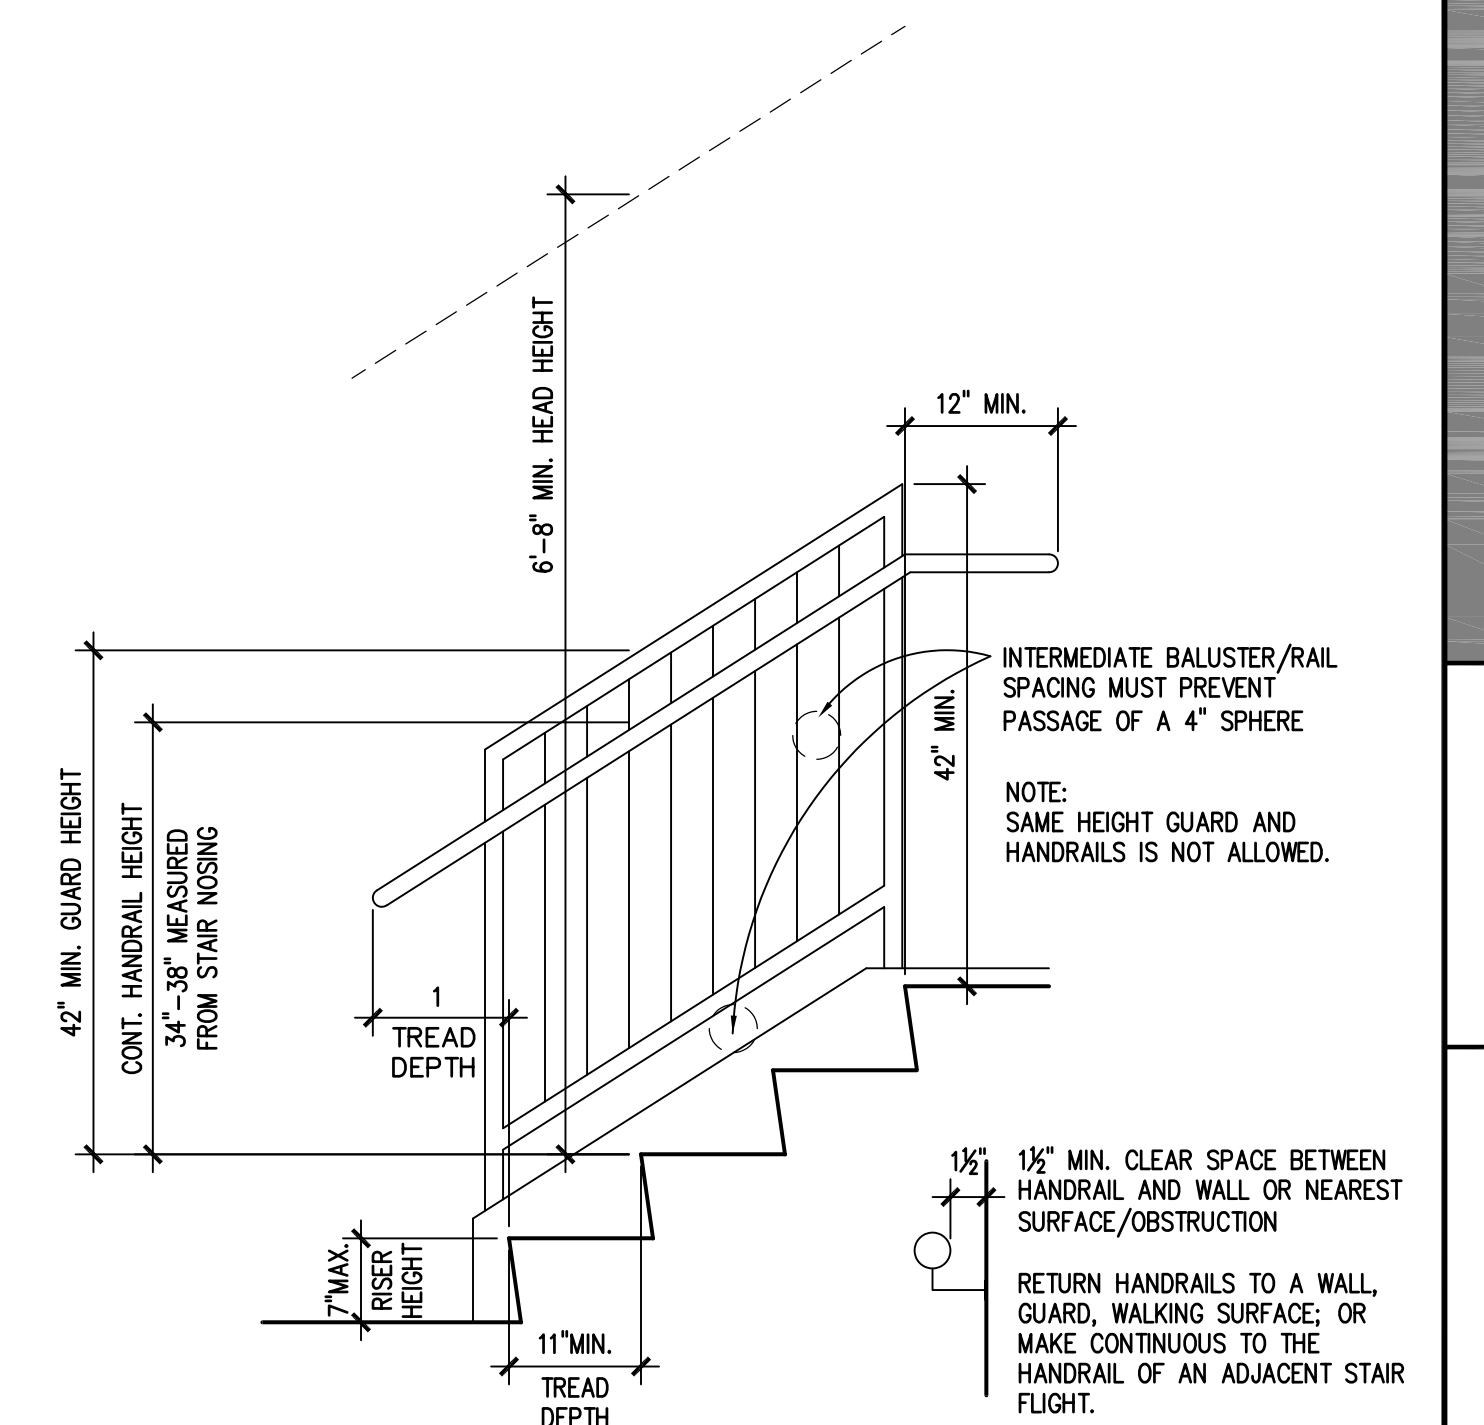

**STAIRS AND GUARDS**  
SCALE: NONE **3**

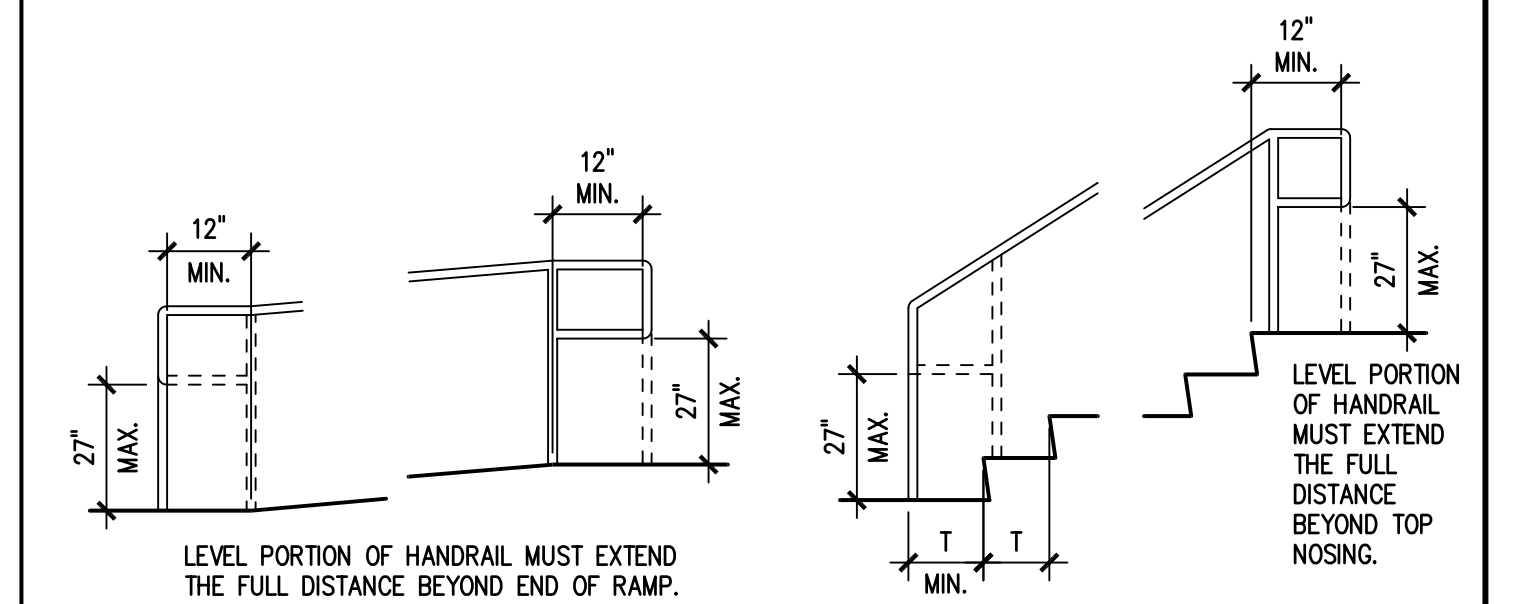


**HANDRAIL EXTENSIONS**  
SCALE: NONE **2**

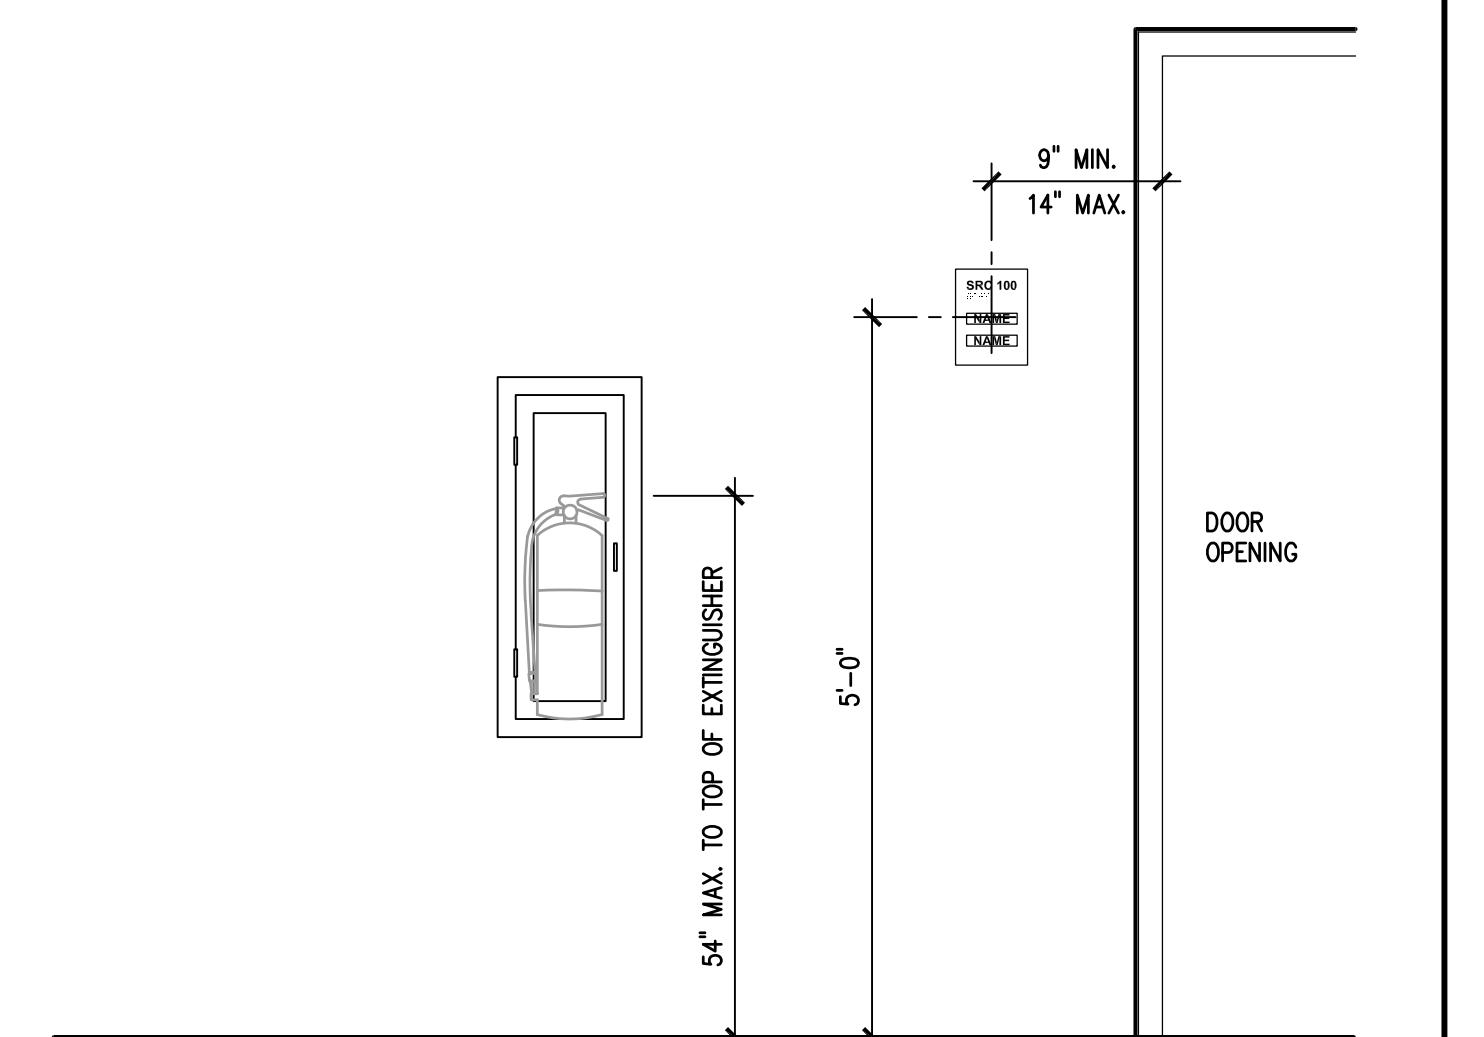

**ROOM SIGNS, FIRE EXTINGUISHERS**  
SCALE: NONE **1**

**GENERAL NOTES**

- REFER TO DRAWING G100 FOR PROJECT GENERAL NOTES.
- DETAILS ON THIS DRAWING ARE INTENDED TO DEPICT A RANGE OF DIFFERENT CONDITIONS. NOT ALL CONDITIONS DEPICTED MAY BE PRESENT IN THIS PROJECT.
- DIMENSIONAL REQUIREMENTS DEPICTED ARE MEASURED TO FACE OF SURFACE FINISHES. ABSOLUTE DIMENSIONS ARE SUBJECT TO REASONABLE CONSTRUCTION TOLERANCES AS DETERMINED BY THE ARCHITECT/ENGINEER AND THE AUTHORITY HAVING JURISDICTION. CONSTRUCTED CLEARANCES, LENGTHS, WIDTHS, DEPTHS OR AREAS EXCEEDING INDICATED MAXIMUMS, LESS THAN INDICATED MINIMUMS OR OUTSIDE OF INDICATED RANGES WILL NOT BE ACCEPTED.
- COORDINATE REQUIREMENTS DEPICTED ON THIS DRAWING WITH INFORMATION DEPICTED ON OTHER DRAWINGS. WHERE DIMENSIONS AND/OR CLEARANCES ON OTHER DRAWINGS ARE OR APPEAR TO BE LESS THAN THE MINIMUMS, GREATER THAN MAXIMUMS OR DEVIATE FROM HOLD DIMENSIONS DEPICTED ON THIS DRAWING, THE REQUIREMENTS OF THIS DRAWING SHALL TAKE PRECEDENCE.

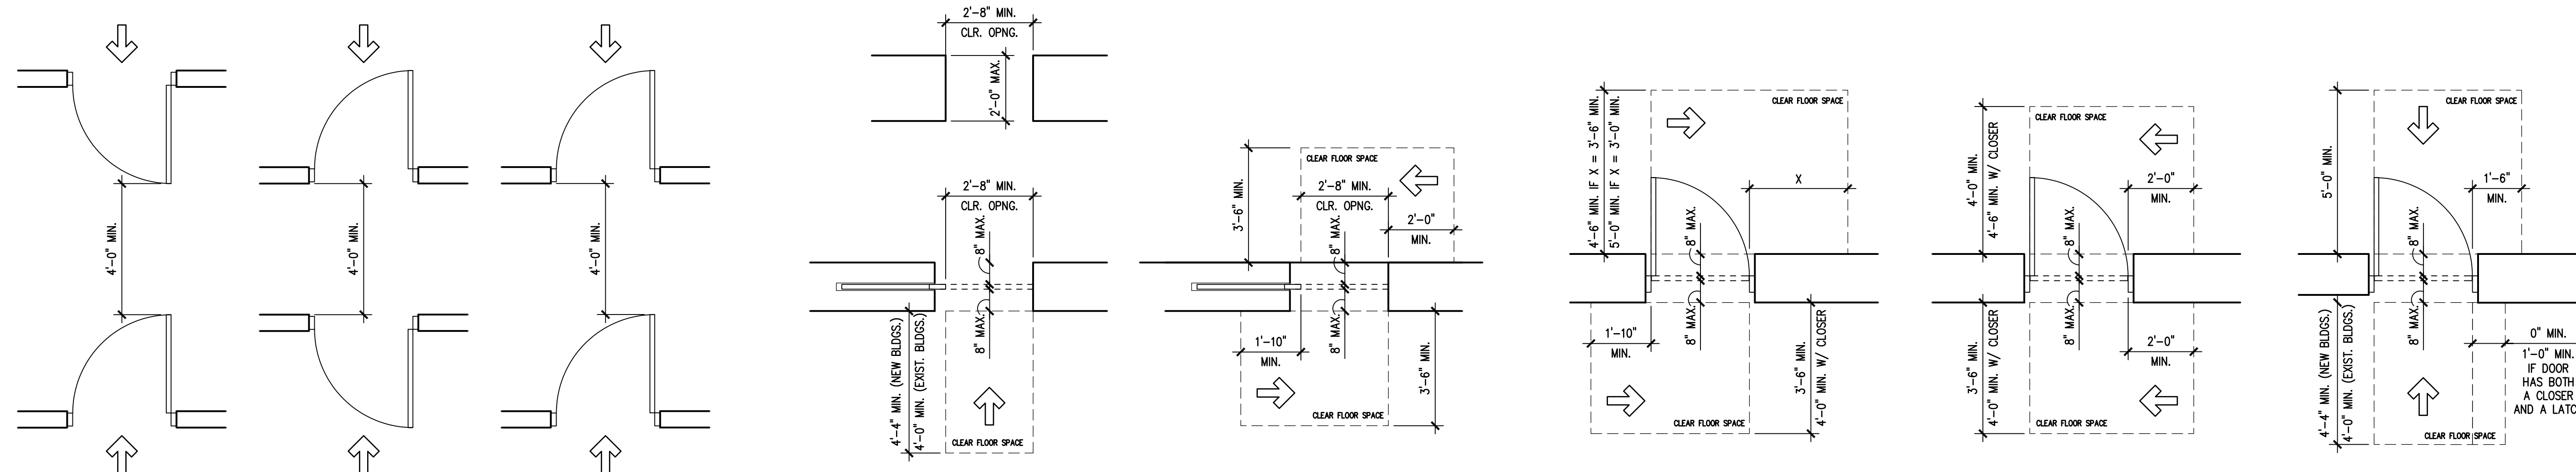

**DOOR CLEARANCES**  
SCALE: NONE **4**

ISSUED	OWNER REVIEW
DATE/TIME	BID DOCUMENTS

JOB NO.	23-429-1495
DRAWN	SKF
CHECKED	CDH
APPROVED	CJH

SHEET TITLE  
**ACCESSIBILITY REQUIREMENTS**

SHEET NUMBER

**G201**





- 2 L101 Silt Fence
- 4 L101 Temporary Concrete Washout
- 1 L101 Tree Protection Fence
- 3 L101 Soil Erosion Control Blanket - by Others

Stockpile excavated soils not used as backfill at nature center pad within designated boundary. Grade to maintain existing drainage direction (south/southwest). Excess/unsuitable soils shall not be placed within 50' of the delineated wetland boundary.

No traffic or storage within wetland areas will be allowed.

## STORM WATER POLLUTION PREVENTION PLAN

THE FOLLOWING PLAN IS ESTABLISHED AND INCORPORATED IN THE PROJECT TO DIRECT THE CONTRACTOR IN THE PLACEMENT OF TEMPORARY EROSION AND SEDIMENT CONTROL SYSTEMS AND TO PROVIDE A STORM WATER POLLUTION PREVENTION PLAN FOR COMPLIANCE UNDER NPDES.

THE PURPOSE OF THIS PLAN IS TO MINIMIZE EROSION WITHIN THE CONSTRUCTION SITE AND TO LIMIT SEDIMENT FROM LEAVING THE CONSTRUCTION SITE BY UTILIZING PROPER TEMPORARY EROSION AND SEDIMENT CONTROL SYSTEMS AND PROVIDING GROUND COVER WITHIN A REASONABLE AMOUNT OF TIME.

CERTAIN SEDIMENT CONTROL FACILITIES SHALL BE INSTALLED BY THE CONTRACTOR AT THE BEGINNING OF CONSTRUCTION. OTHER ITEMS SHALL BE INSTALLED BY THE CONTRACTOR AS DIRECTED BY THE ENGINEER ON A CASE BY CASE BASIS DEPENDING ON THE CONTRACTOR'S SEQUENCE OF ACTIVITIES, TIME OF YEAR, AND EXPECTED WEATHER CONDITIONS.

THE CONTRACTOR SHALL INSTALL PERMANENT EROSION CONTROL SYSTEMS AND SEEDING WITHIN A TIME FRAME SPECIFIED HEREIN AND AS DIRECTED BY THE ENGINEER, THEREFORE MINIMIZING THE AMOUNT OF AREA SUSCEPTIBLE TO EROSION AND REDUCING THE AMOUNT OF TEMPORARY SEEDING. THE ENGINEER WILL DETERMINE IF ANY TEMPORARY EROSION CONTROL SYSTEMS SHOWN IN THE PLAN CAN BE DELETED AND IF ANY ADDITIONAL TEMPORARY EROSION CONTROL SYSTEMS ARE NOT INCLUDED IN THIS PLAN, SHALL BE ADDED. THE CONTRACTOR SHALL PERFORM ALL WORK AS DIRECTED BY THE ENGINEER AND AS SHOWN IN IDOT STANDARD 280001.

SECTION 280, TEMPORARY EROSION CONTROL, OF THE STANDARD SPECIFICATIONS ADDITIONALLY SUPPLEMENTS THIS PLAN.

**SITE DESCRIPTION**  
**DESCRIPTION OF CONSTRUCTION ACTIVITY:**

1. THE PROJECT IS LOCATED IN SUBAT FOREST PRESERVE, KENDALL COUNTY, IL.
2. THE SUBAT FOREST PRESERVE PROJECT SHALL GENERALLY CONSIST OF THE FOLLOWING:
  - 1.) INSTALLATION OF NEW ASPHALT AND LIMESTONE WALKING PATHS;
  - 2.) REMOVAL AND REPLACEMENT/EXPANSION OF A PARKING LOT;
  - 3.) INSTALLATION OF PARKING LOT ENTRANCES ALONG ELDAMAN ROAD;
  - 4.) CULVERT INSTALLATION WITHIN THE ROADSIDE DITCH ALONG ELDAMAN ROAD AND THE NORTHWEST CORNER OF THE INTERSECTION OF ELDAMAN ROAD AND RIVER ROAD;
  - 5.) INSTALLATION OF A NATURE CENTER PAVILION AND ASSOCIATED CONCRETE PAD; AND
  - 6.) INSTALLATION OF A BOARDWALK.

**DESCRIPTION OF INTENDED SEQUENCE FOR MAJOR CONSTRUCTION ACTIVITIES WHICH WILL DISTURB SOILS FOR MAJOR PORTION OF THE CONSTRUCTION SITE:**

1. INSTALL SILT FENCING, TREE PROTECTION FENCING, STABILIZED CONSTRUCTION ENTRANCE, AND TEMPORARY CONCRETE WASHOUT.
2. INSTALL FLARED END PROTECTION IMMEDIATELY FOLLOWING INSTALLATION OF CULVERTS.
3. SITE SHALL BE TEMPORARILY STABILIZED IMMEDIATELY FOLLOWING GRADING COMPLETION.
4. THE SITE SHALL BE SEEDING AND STABILIZED WITH EROSION CONTROL MAT UPON COMPLETION OF GRADING.
5. TEMPORARY EROSION CONTROL MEASURES WILL BE REMOVED FOLLOWING FINAL STABILIZATION.

**AREA OF CONSTRUCTION SITE:**  
APPROXIMATELY 1.65 ACRES WILL BE DISTURBED BY EXCAVATION, GRADING, AND OTHER ACTIVITIES.

**OTHER REPORTS, STUDIES AND PLANS, WHICH AID IN THE DEVELOPMENT OF THE STORM WATER POLLUTION PREVENTION PLAN AS REFERENCED DOCUMENTS:**

1. INFORMATION OF THE SOILS AND TERRAIN WITHIN THE SITE WAS OBTAINED FROM TOPOGRAPHIC SURVEYS AND SOIL BORINGS THAT WERE UTILIZED FOR THE DEVELOPMENT OF THE PROPOSED TEMPORARY EROSION AND SEDIMENT CONTROL SYSTEMS.
2. PROJECT PLAN DOCUMENTS, SPECIFICATIONS AND SPECIAL PROVISIONS, AND PLAN DRAWINGS INDICATING DRAINAGE PATTERNS AND APPROXIMATE SLOPES ANTICIPATED AFTER GRADING ACTIVITIES WERE UTILIZED FOR THE PROPOSED PLACEMENT OF THE TEMPORARY EROSION CONTROL SYSTEMS.

**DRAINAGE TRIBUTARIES AND SENSITIVE AREAS RECEIVING RUNOFF FROM THIS CONSTRUCTION SITE:**

1. ON-SITE WETLANDS

THIS PLAN HAS BEEN PREPARED TO COMPLY WITH THE PROVISIONS OF THE NPDES PERMIT NUMBER ILR10 ISSUED BY THE ILLINOIS ENVIRONMENTAL PROTECTION AGENCY FOR STORM WATER DISCHARGES FROM CONSTRUCTION SITE ACTIVITIES.

I CERTIFY UNDER PENALTY OF LAW THAT THIS DOCUMENT AND ALL ATTACHMENTS WERE PREPARED UNDER MY DIRECTION OR SUPERVISION IN ACCORDANCE WITH A SYSTEM DESIGNED TO ASSURE THAT QUALIFIED PERSONNEL PROPERLY GATHERED AND EVALUATED THE INFORMATION SUBMITTED, BASED ON MY INQUIRY OF THE PERSON OR PERSONS WHO MANAGE THE SYSTEM, OR THOSE PERSONS DIRECTLY RESPONSIBLE FOR GATHERING THE INFORMATION, THE INFORMATION SUBMITTED IS TO THE BEST OF MY KNOWLEDGE AND BELIEF, TRUE, ACCURATE AND NOT FALSIFIED. I AM AWARE THAT THERE ARE SIGNIFICANT PENALTIES FOR SUBMITTING FALSE INFORMATION, INCLUDING THE POSSIBILITY OF FINE AND IMPRISONMENT FOR KNOWING VIOLATIONS.

**ENGINEER:** DATE:

**SEDIMENT EROSION CONTROL AND POLLUTION PREVENTION NOTES:**

1. DURING CONSTRUCTION, AREAS OUTSIDE THE CONSTRUCTION LIMITS SHALL BE PROTECTED. THE CONTRACTOR SHALL NOT USE THESE AREAS FOR STORAGE, PARKING OF VEHICLES OR CONSTRUCTION EQUIPMENT, STORAGE OF MATERIALS OR OTHER CONSTRUCTION RELATED ACTIVITIES.
2. CONSTRUCTION EQUIPMENT SHALL BE STORED AT DESIGNATED LOCATIONS. ALL NECESSARY MEASURES SHALL BE TAKEN TO CONTAIN ANY FUEL OR OTHER POLLUTANT IN ACCORDANCE WITH EPA WATER QUALITY REGULATIONS. LEAKING EQUIPMENT OR SUPPLIES SHALL BE IMMEDIATELY REPAIRED OR REMOVED FROM THE SITE.
3. TEMPORARY SEDIMENT CONTROL SYSTEMS SHALL BE LEFT IN PLACE WITH PROPER MAINTENANCE UNTIL PERMANENT EROSION CONTROL IS IN PLACE AND WORKING PROPERLY AND ALL PERMANENT VEGETATION IS GROWING AND THRIVING.
4. EROSION CONTROL MEASURES SHALL BE INSTALLED PRIOR TO START OF CONSTRUCTION.
5. ALL EROSION CONTROL MEASURES MUST BE INSPECTED WEEKLY AND AFTER EACH 1/2" RAIN EVENT.
6. THE EROSION CONTROL BLANKET AND/OR STRAW MULCH WITH NETTING (DEPENDENT ON SLOPE, SLOPE LENGTH AND FLOW RATES) SHALL BE INSTALLED ON ALL SLOPES AND IN CRITICAL AREAS (I.E. POND PERIMETER, BEAMS, ETC.) IMMEDIATELY UPON FINAL GRADING.
7. IN AREAS WHERE WORK IS COMPLETE, PERMANENT STABILIZATION SHALL OCCUR WITHIN 7 DAYS OF COMPLETION, AND IN AREAS WHERE WORK HAS TEMPORARILY CEASED FOR 14 DAYS OR MORE, TEMPORARY STABILIZATION SHALL OCCUR BY THE 7TH DAY AFTER WORK HAS CEASED.
8. WINTER PROTECTION SHALL BE ADDRESSED EARLY IN THE FALL GROWING SEASON SO THAT SLOPES AND OTHER BARE EARTH AREAS MAY BE STABILIZED WITH TEMPORARY AND/OR PERMANENT VEGETATIVE COVER FOR PROPER EROSION AND SEDIMENT CONTROL.
9. ALL ADJACENT STREETS MUST BE KEPT CLEAR OF DEBRIS, INSPECTED DAILY, AND CLEANED WHEN NECESSARY AND AS DIRECTED BY ENGINEER.
10. UNLESS OTHERWISE INDICATED, ALL VEGETATIVE AND STRUCTURAL EROSION AND SEDIMENT CONTROL PRACTICES WILL BE CONSTRUCTED ACCORDING TO MINIMUM STANDARDS AND SPECIFICATIONS IN THE MOST RECENT ILLINOIS URBAN MANUAL.
11. THE COUNTY MUST BE NOTICED ONE WEEK PRIOR TO THE PRE-CONSTRUCTION CONFERENCE, ONE WEEK PRIOR TO THE COMMENCEMENT OF LAND DISTURBING ACTIVITIES, AND ONE WEEK PRIOR TO THE FINAL INSPECTION.
12. A COPY OF THE APPROVED EROSION AND SEDIMENT CONTROL PLAN SHALL BE MAINTAINED ON THE SITE AT ALL TIMES.
13. PRIOR TO COMMENCING LAND-DISTURBING ACTIVITIES IN AREAS OTHER THAN INDICATED ON THESE PLANS (INCLUDING BUT NOT LIMITED TO, ADDITIONAL PHASES OF DEVELOPMENT AND OFF-SITE BORROW OR WASTE AREAS) A SUPPLEMENTARY EROSION CONTROL PLAN SHALL BE SUBMITTED TO THE OWNER FOR REVIEW BY THE COUNTY.
14. THE CONTRACTOR IS RESPONSIBLE FOR INSTALLATION OF ANY ADDITIONAL EROSION CONTROL MEASURES NECESSARY TO PREVENT EROSION AND SEDIMENTATION AS DETERMINED BY THE COUNTY.
15. NO WORK SHALL BE PERFORMED IN FLOWING WATER, WORK IN AND NEAR THE CRITICAL AREAS SHOULD BE ISOLATED FROM CONCENTRATED FLOWS OR STREAM FLOW. ONCE WORK IN THIS AREA BEGINS, PRIORITY SHALL BE GIVEN TO THE COMPLETION OF THE WORK AND FINAL STABILIZATION OF ALL DISTURBED AREAS.
16. IT IS THE RESPONSIBILITY OF THE LANDOWNER AND/OR GENERAL CONTRACTOR TO INFORM ANY SUB-CONTRACTORS (WHO MAY PERFORM WORK ON THIS PROJECT, OF THE REQUIREMENTS IN IMPLEMENTING AND MAINTAINING THESE EROSION CONTROL PLANS AND ASSURE COMPLIANCE WITH ALL APPLICABLE LOCAL, STATE, AND FEDERAL REGULATIONS.
17. EXCAVATED AREAS SHALL BE PERMANENTLY SEEDING IMMEDIATELY AFTER FINAL GRADING. IF NOT, THEY SHALL BE TEMPORARILY SEEDING IF NO CONSTRUCTION ACTIVITY IN THE AREA IS PLANNED FOR SEVEN (7) DAYS.
18. TEMPORARY EROSION CONTROL SEEDING SHALL BE APPLIED AT A RATE OF 50 LBS/ACRES.
19. CONSTRUCTION IS COMPLETE AFTER ACCEPTANCE BY THE OWNER. MAINTENANCE UP TO THIS DATE WILL BE BY THE CONTRACTOR.
20. SEDIMENT COLLECTED DURING CONSTRUCTION BY THE VARIOUS TEMPORARY SEDIMENT CONTROL SYSTEMS SHALL BE DISPOSED OF ON THE SITE ON A REGULAR BASIS, AS DIRECTED BY THE ENGINEER. THE COST OF THIS MAINTENANCE SHALL BE PAID FOR AT THE CONTRACT UNIT PRICE PER CUBIC YARD FOR EARTH EXCAVATION.
21. ALL TEMPORARY EROSION AND SEDIMENT CONTROL MEASURES SHALL BE REMOVED WITHIN 30 DAYS AFTER FINAL STABILIZATION IS ACHIEVED. TEMPORARY SEDIMENT RESULTING FROM TEMPORARY MEASURES SHALL BE PROPERLY DISPOSED OF PRIOR TO PERMANENT STABILIZATION.
22. ALL EROSION AND SEDIMENT CONTROL PRODUCTS FURNISHED SHALL BE SPECIFICALLY RECOMMENDED BY THE MANUFACTURER FOR THE USE SPECIFIED IN THE EROSION AND SEDIMENT CONTROL PLAN. PRIOR TO THE APPROVAL AND USE OF THE PRODUCT, THE CONTRACTOR SHALL SUBMIT TO THE ENGINEER A NOTARIZED CERTIFICATION BY THE PRODUCER STATING THE INTENDED USE OF THE PRODUCT AND THAT THE PHYSICAL PROPERTIES REQUIRED FOR THIS APPLICATION ARE MET OR EXCEEDED. THE CONTRACTOR SHALL PROVIDE MANUFACTURER INSTALLATION PROCEDURES TO FACILITATE THE ENGINEER IN CONSTRUCTION INSPECTION.
23. THE DRAWINGS, SPECIFICATIONS AND SPECIAL PROVISIONS WILL ENSURE THAT EXISTING VEGETATION IS PRESERVED WHERE ATTAINABLE AND DISTURBED PORTIONS OF THE SITE WILL BE STABILIZED. STABILIZATION PRACTICES INCLUDE TEMPORARY SEEDING, PERMANENT SEEDING, MULCHING, PROTECTION OF TREES, PRESERVATION OF NATURAL VEGETATION, AND OTHER APPROPRIATE MEASURES AS DIRECTED BY THE ENGINEER. STABILIZATION MEASURES SHALL BE INITIATED AS SOON AS PRACTICABLE IN PORTIONS OF THE SITE WHERE CONSTRUCTION ACTIVITIES HAVE TEMPORARILY OR PERMANENTLY CEASED, BUT IN NO CASE MORE THAN 7 DAYS AFTER THE CONSTRUCTION ACTIVITY IN THAT PORTION OF THE SITE HAS TEMPORARILY OR PERMANENTLY CEASED.
24. AREAS OF EXISTING VEGETATION, WOOD AND GRASSLANDS, OUTSIDE THE PROPOSED CONSTRUCTION LIMITS SHALL BE IDENTIFIED BY THE ENGINEER FOR PRESERVING AND SHALL BE PROTECTED FROM CONSTRUCTION ACTIVITIES.
  - a. DEAD, DISEASED, OR UNSUITABLE VEGETATION WITHIN THE SITE SHALL BE REMOVED AS DIRECTED BY THE ENGINEER.
  - b. BARE AND SPARSELY VEGETATED GROUND IN HIGH EROSION AREAS AS DETERMINED BY THE ENGINEER SHALL BE TEMPORARILY SEEDING AT THE BEGINNING OF CONSTRUCTION WHERE NO CONSTRUCTION ACTIVITIES ARE EXPECTED WITHIN SEVEN (7) DAYS.
25. THE SITE SHOULD BE PHASED IN A WAY THAT REDUCES THE AMOUNT OF STRIPPED, UNSTABILIZED AREAS WITHIN THE SITE AT ANY ONE TIME. MASS GRADING BE PLACED AS TO PREVENT EROSION ON SITE AND SEDIMENTATION ISSUES DOWNSTREAM.
26. BARRIER PROTECTION SHALL BE ENTIRE OF SOIL DISTURBANCE FOR ALL UNDISTURBED WETLAND AREAS.

**CONTRACTOR'S CERTIFICATION**

I CERTIFY UNDER PENALTY OF LAW THAT I UNDERSTAND THE TERMS AND CONDITIONS OF THE GENERAL NATIONAL POLLUTANT DISCHARGE ELIMINATION SYSTEM (NPDES) PERMIT (ILR10) THAT AUTHORIZES THE STORMWATER DISCHARGES ASSOCIATED WITH ACTIVITY FROM THE CONSTRUCTION SITE IDENTIFIED AS PART OF THIS CERTIFICATION.



GENERAL CONTRACTOR:  
SIGNATURE \_\_\_\_\_ TITLE \_\_\_\_\_ DATE \_\_\_\_\_  
COMPANY \_\_\_\_\_

**OWNER'S CERTIFICATION**


I CERTIFY UNDER PENALTY OF LAW THAT THIS DOCUMENT AND ALL ATTACHMENTS WERE PREPARED UNDER MY DIRECTION OR SUPERVISION IN ACCORDANCE WITH A SYSTEM DESIGNED TO ASSURE THAT QUALIFIED PERSONNEL PROPERLY GATHERED AND EVALUATED THE INFORMATION SUBMITTED, BASED ON MY INQUIRY OF THE PERSON OR PERSONS WHO MANAGE THE SYSTEM, OR THOSE PERSONS DIRECTLY RESPONSIBLE FOR GATHERING THE INFORMATION, THE INFORMATION SUBMITTED IS TO THE BEST OF MY KNOWLEDGE AND BELIEF, TRUE, ACCURATE AND COMPLETE. I AM AWARE THAT THERE ARE SIGNIFICANT PENALTIES FOR SUBMITTING FALSE INFORMATION, INCLUDING THE POSSIBILITY OF FINE AND IMPRISONMENT FOR KNOWING VIOLATIONS.

OWNER:  
SIGNATURE \_\_\_\_\_ TITLE \_\_\_\_\_ DATE \_\_\_\_\_  
COMPANY \_\_\_\_\_


- REMOVALS LEGEND**
- TPF Tree Protection Fence
  - SF Silt Fence

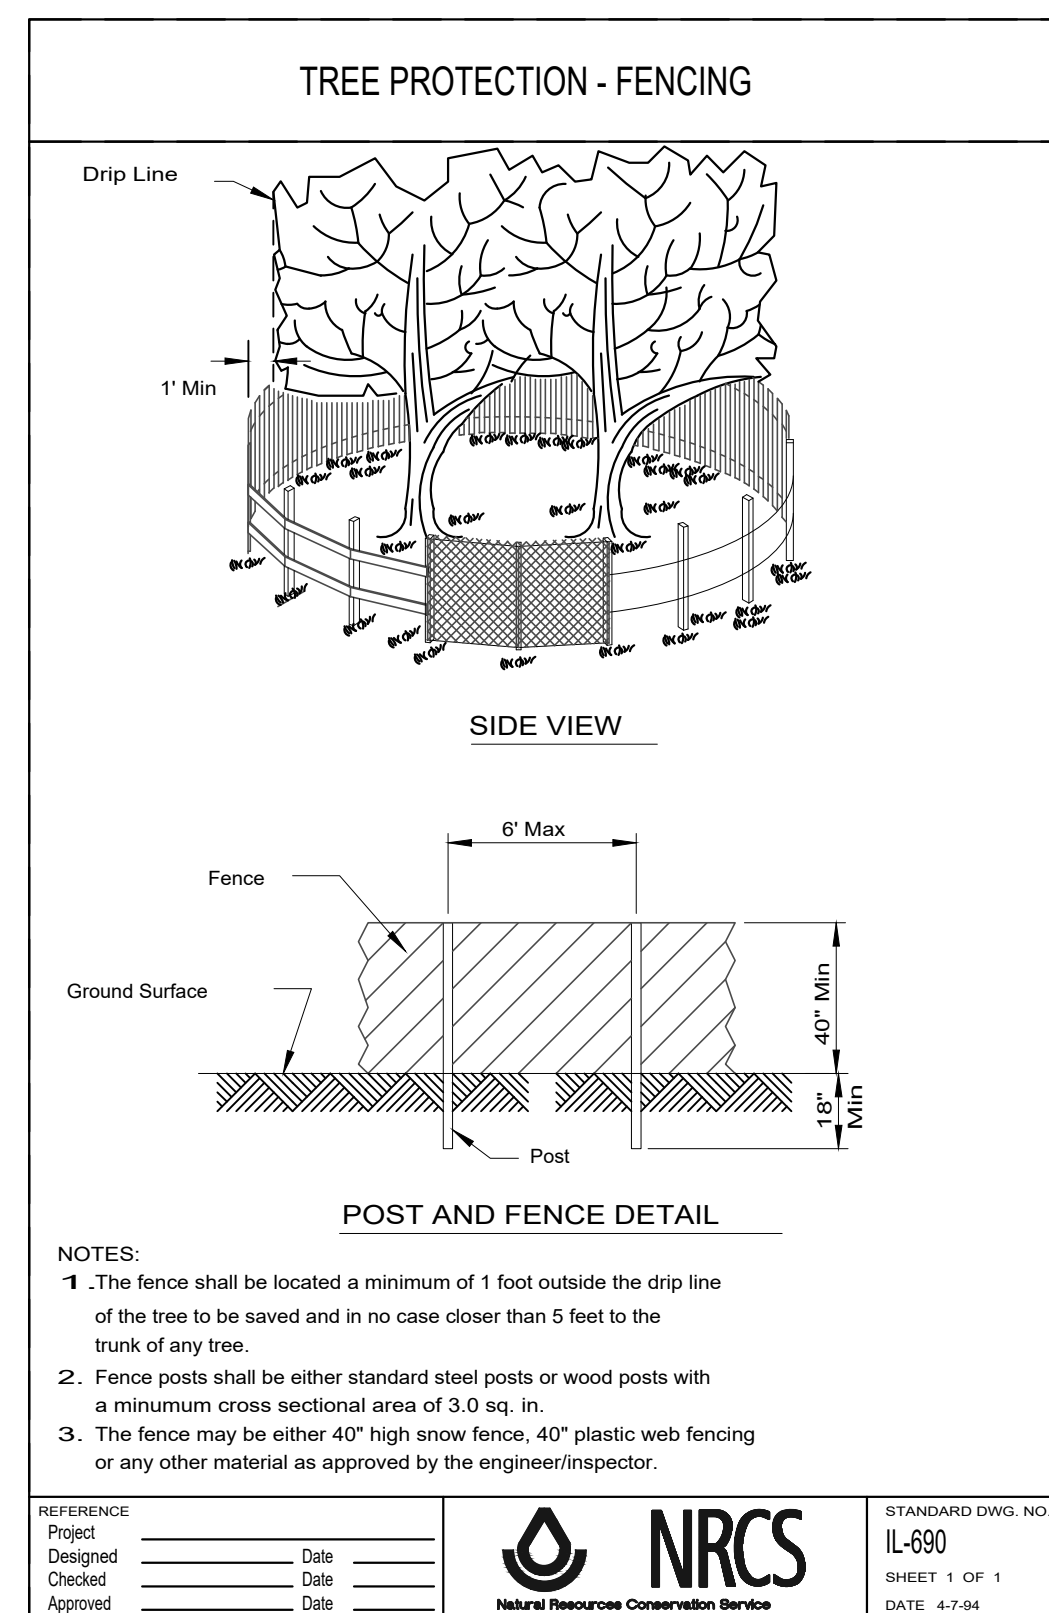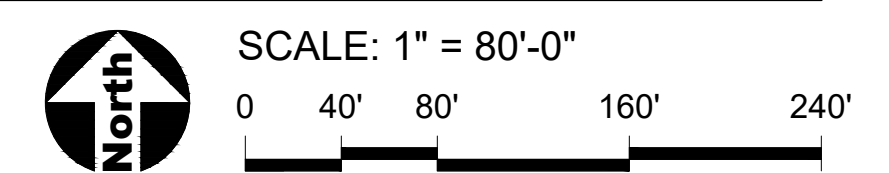


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SCALE: NTS  
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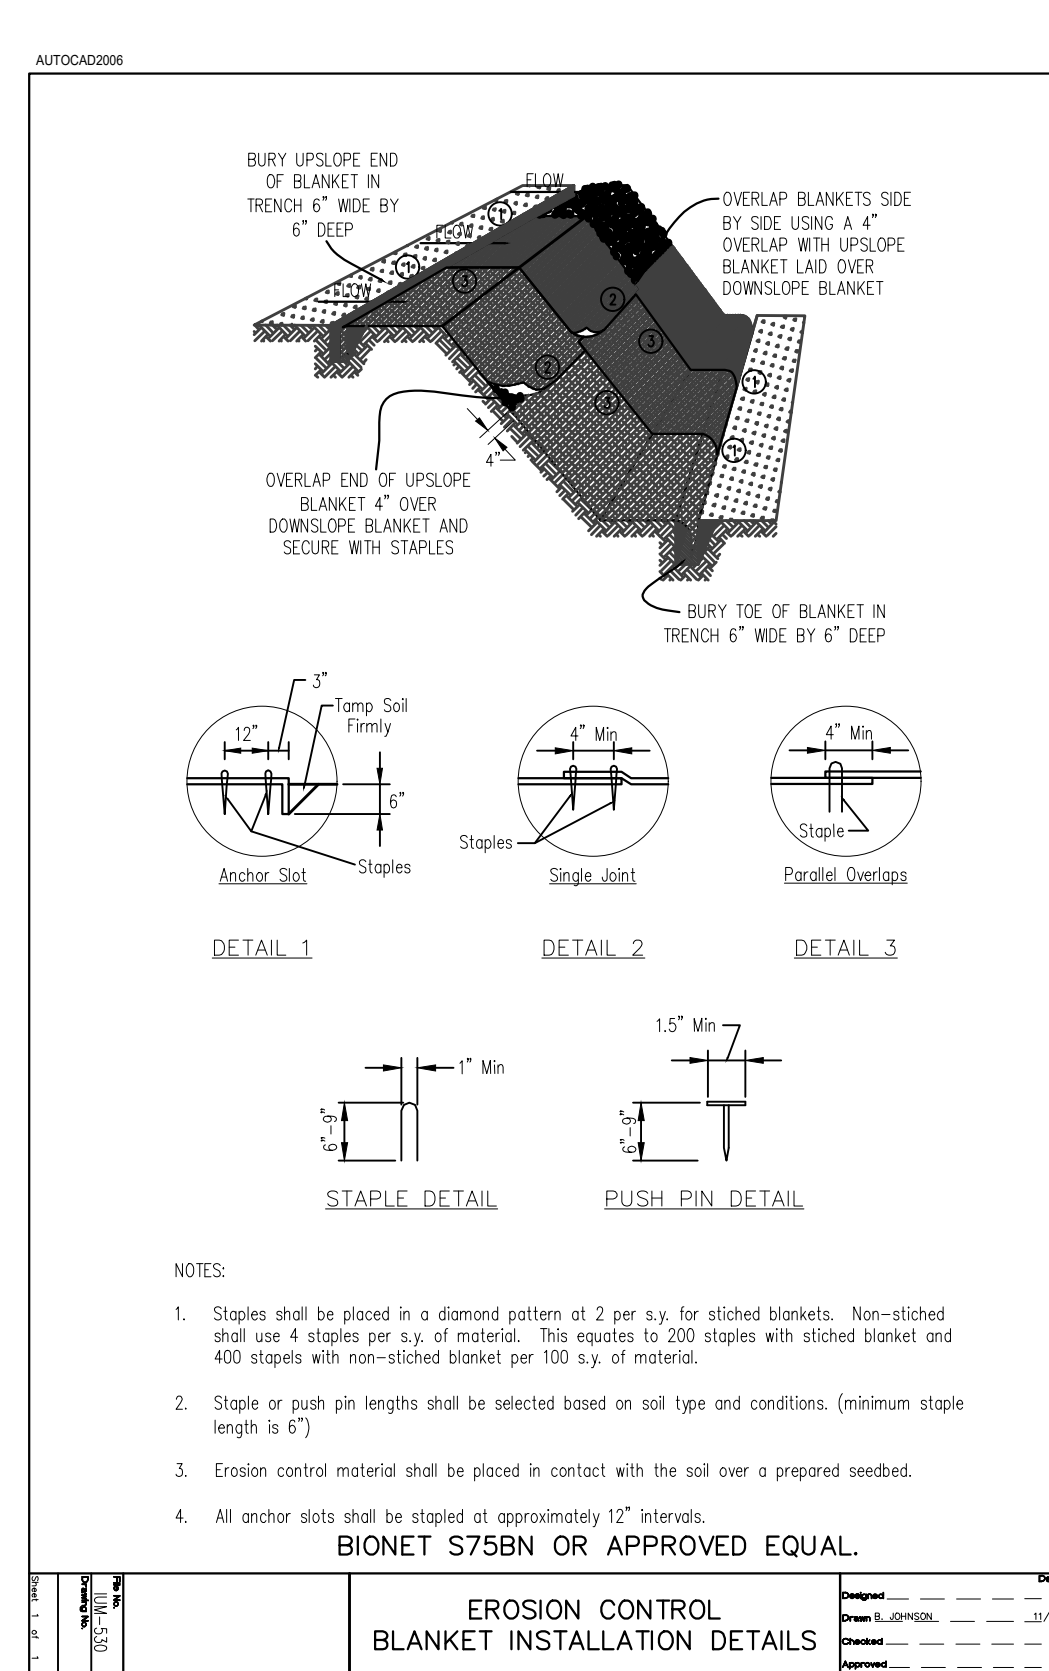
4 Temporary Concrete Washout  
SCALE: NTS  
d-IUM-65458-concrete washout\_12

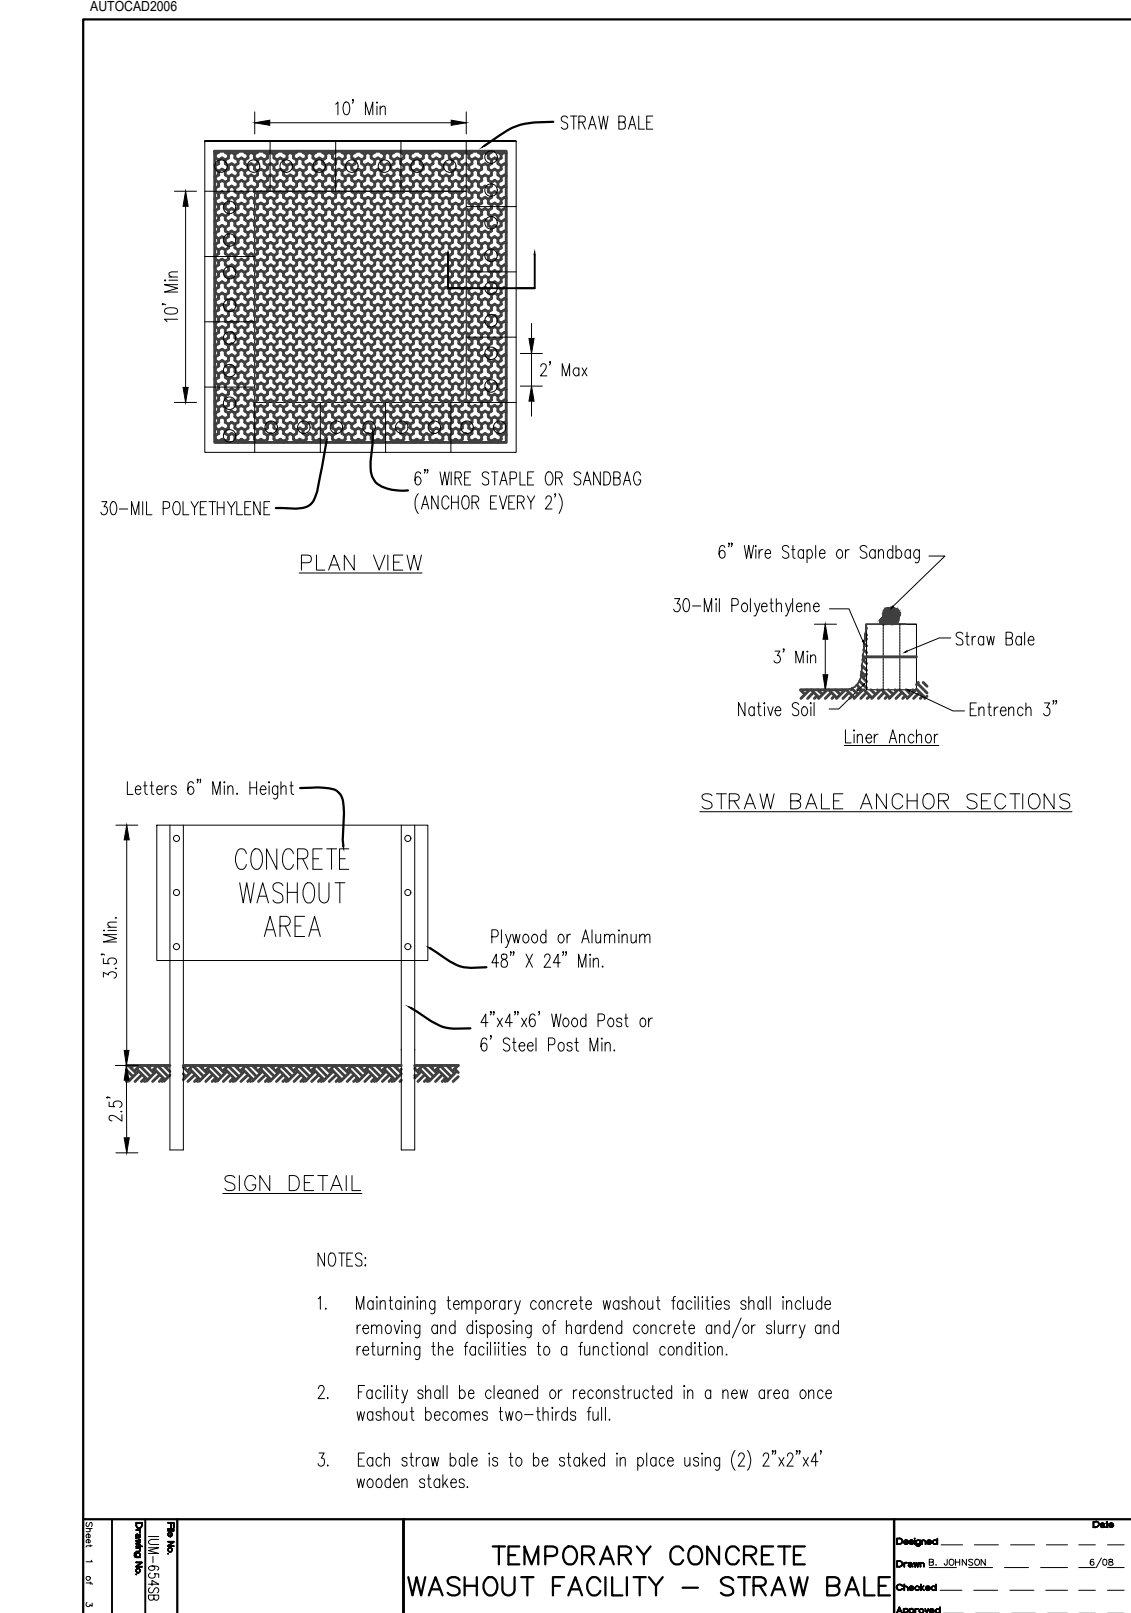

2 Silt Fence  
SCALE: NTS  
d-IUM 620B-silt fence\_12

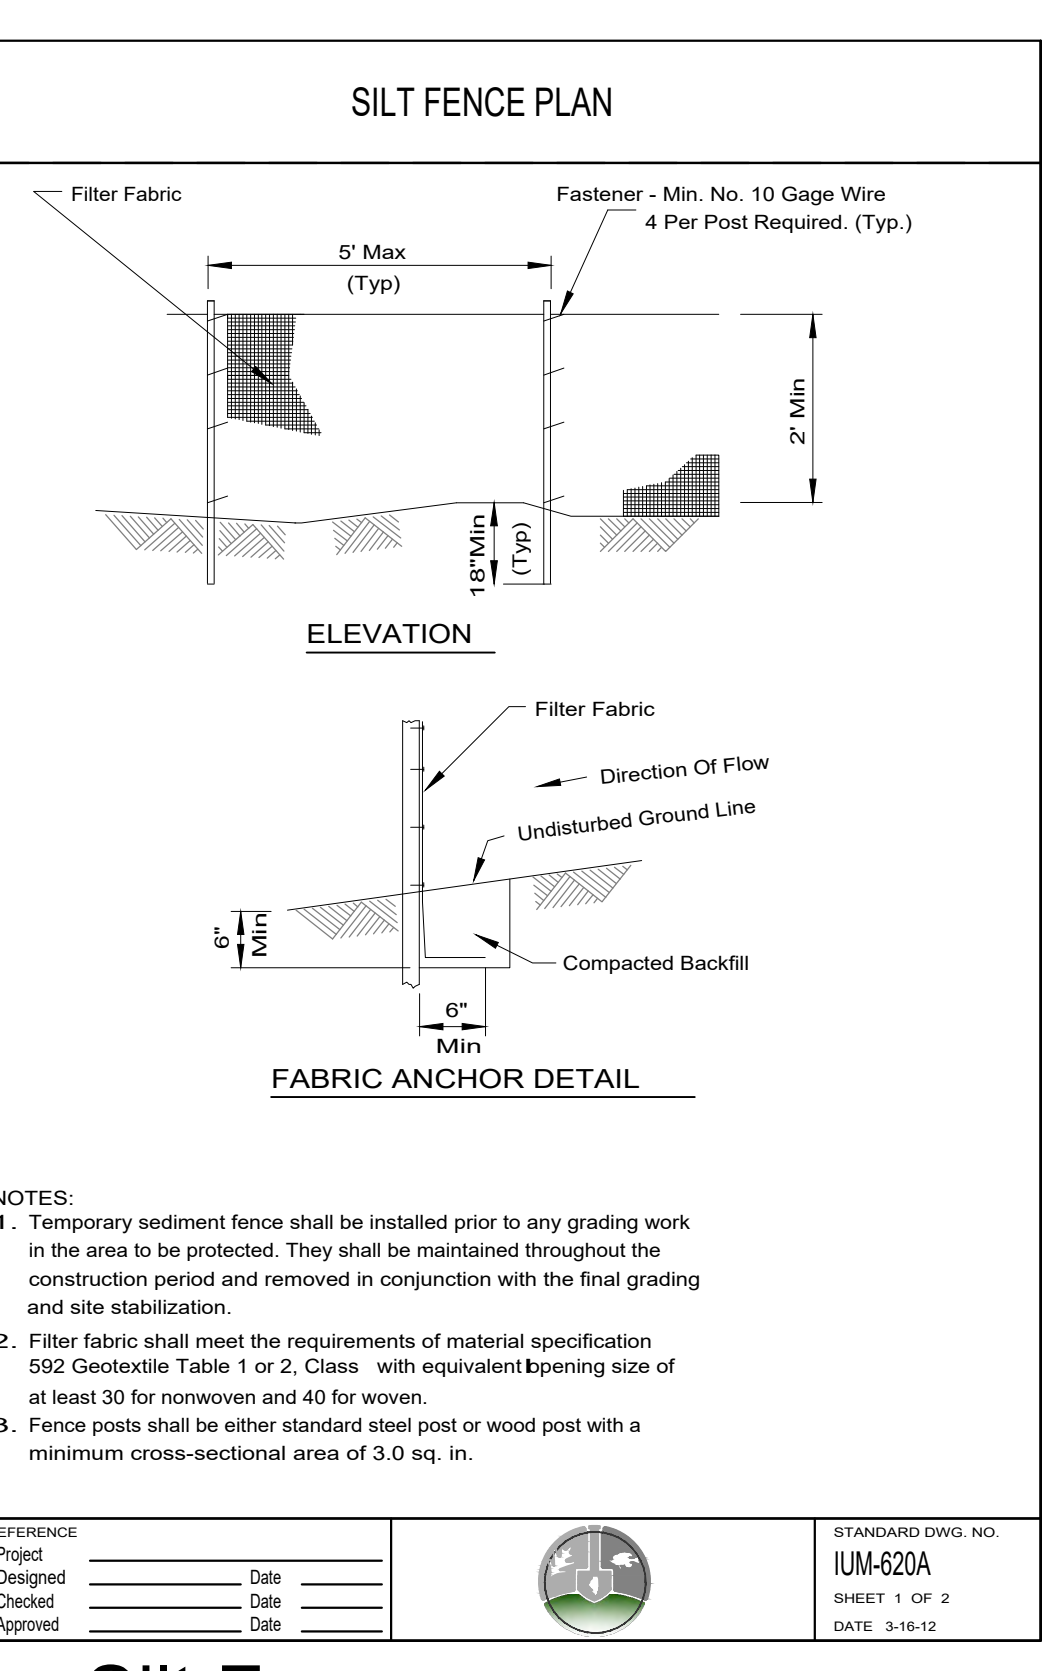

3 Erosion Control Blanket  
SCALE: NTS  
d-IUM-530-erosion control blanket\_12

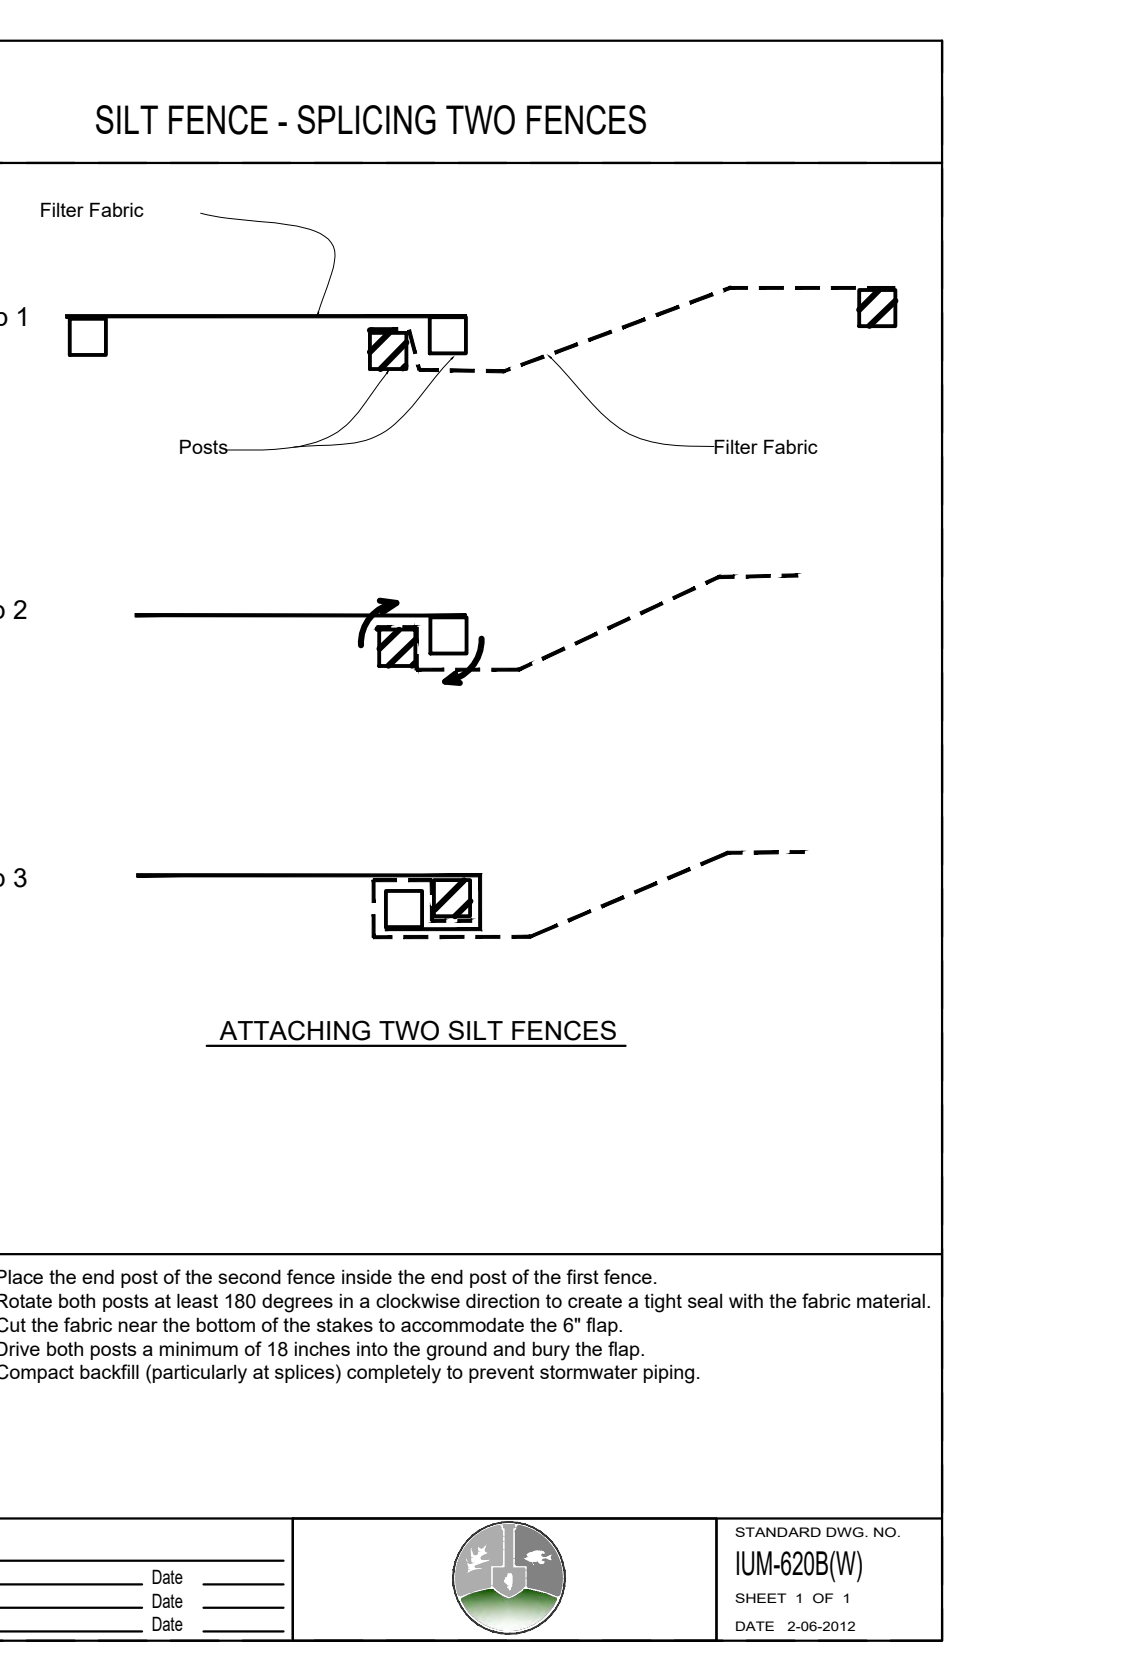

3 Erosion Control Blanket  
SCALE: NTS  
d-IUM-530-erosion control blanket\_12

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**QUALITY BID DOCUMENTS**

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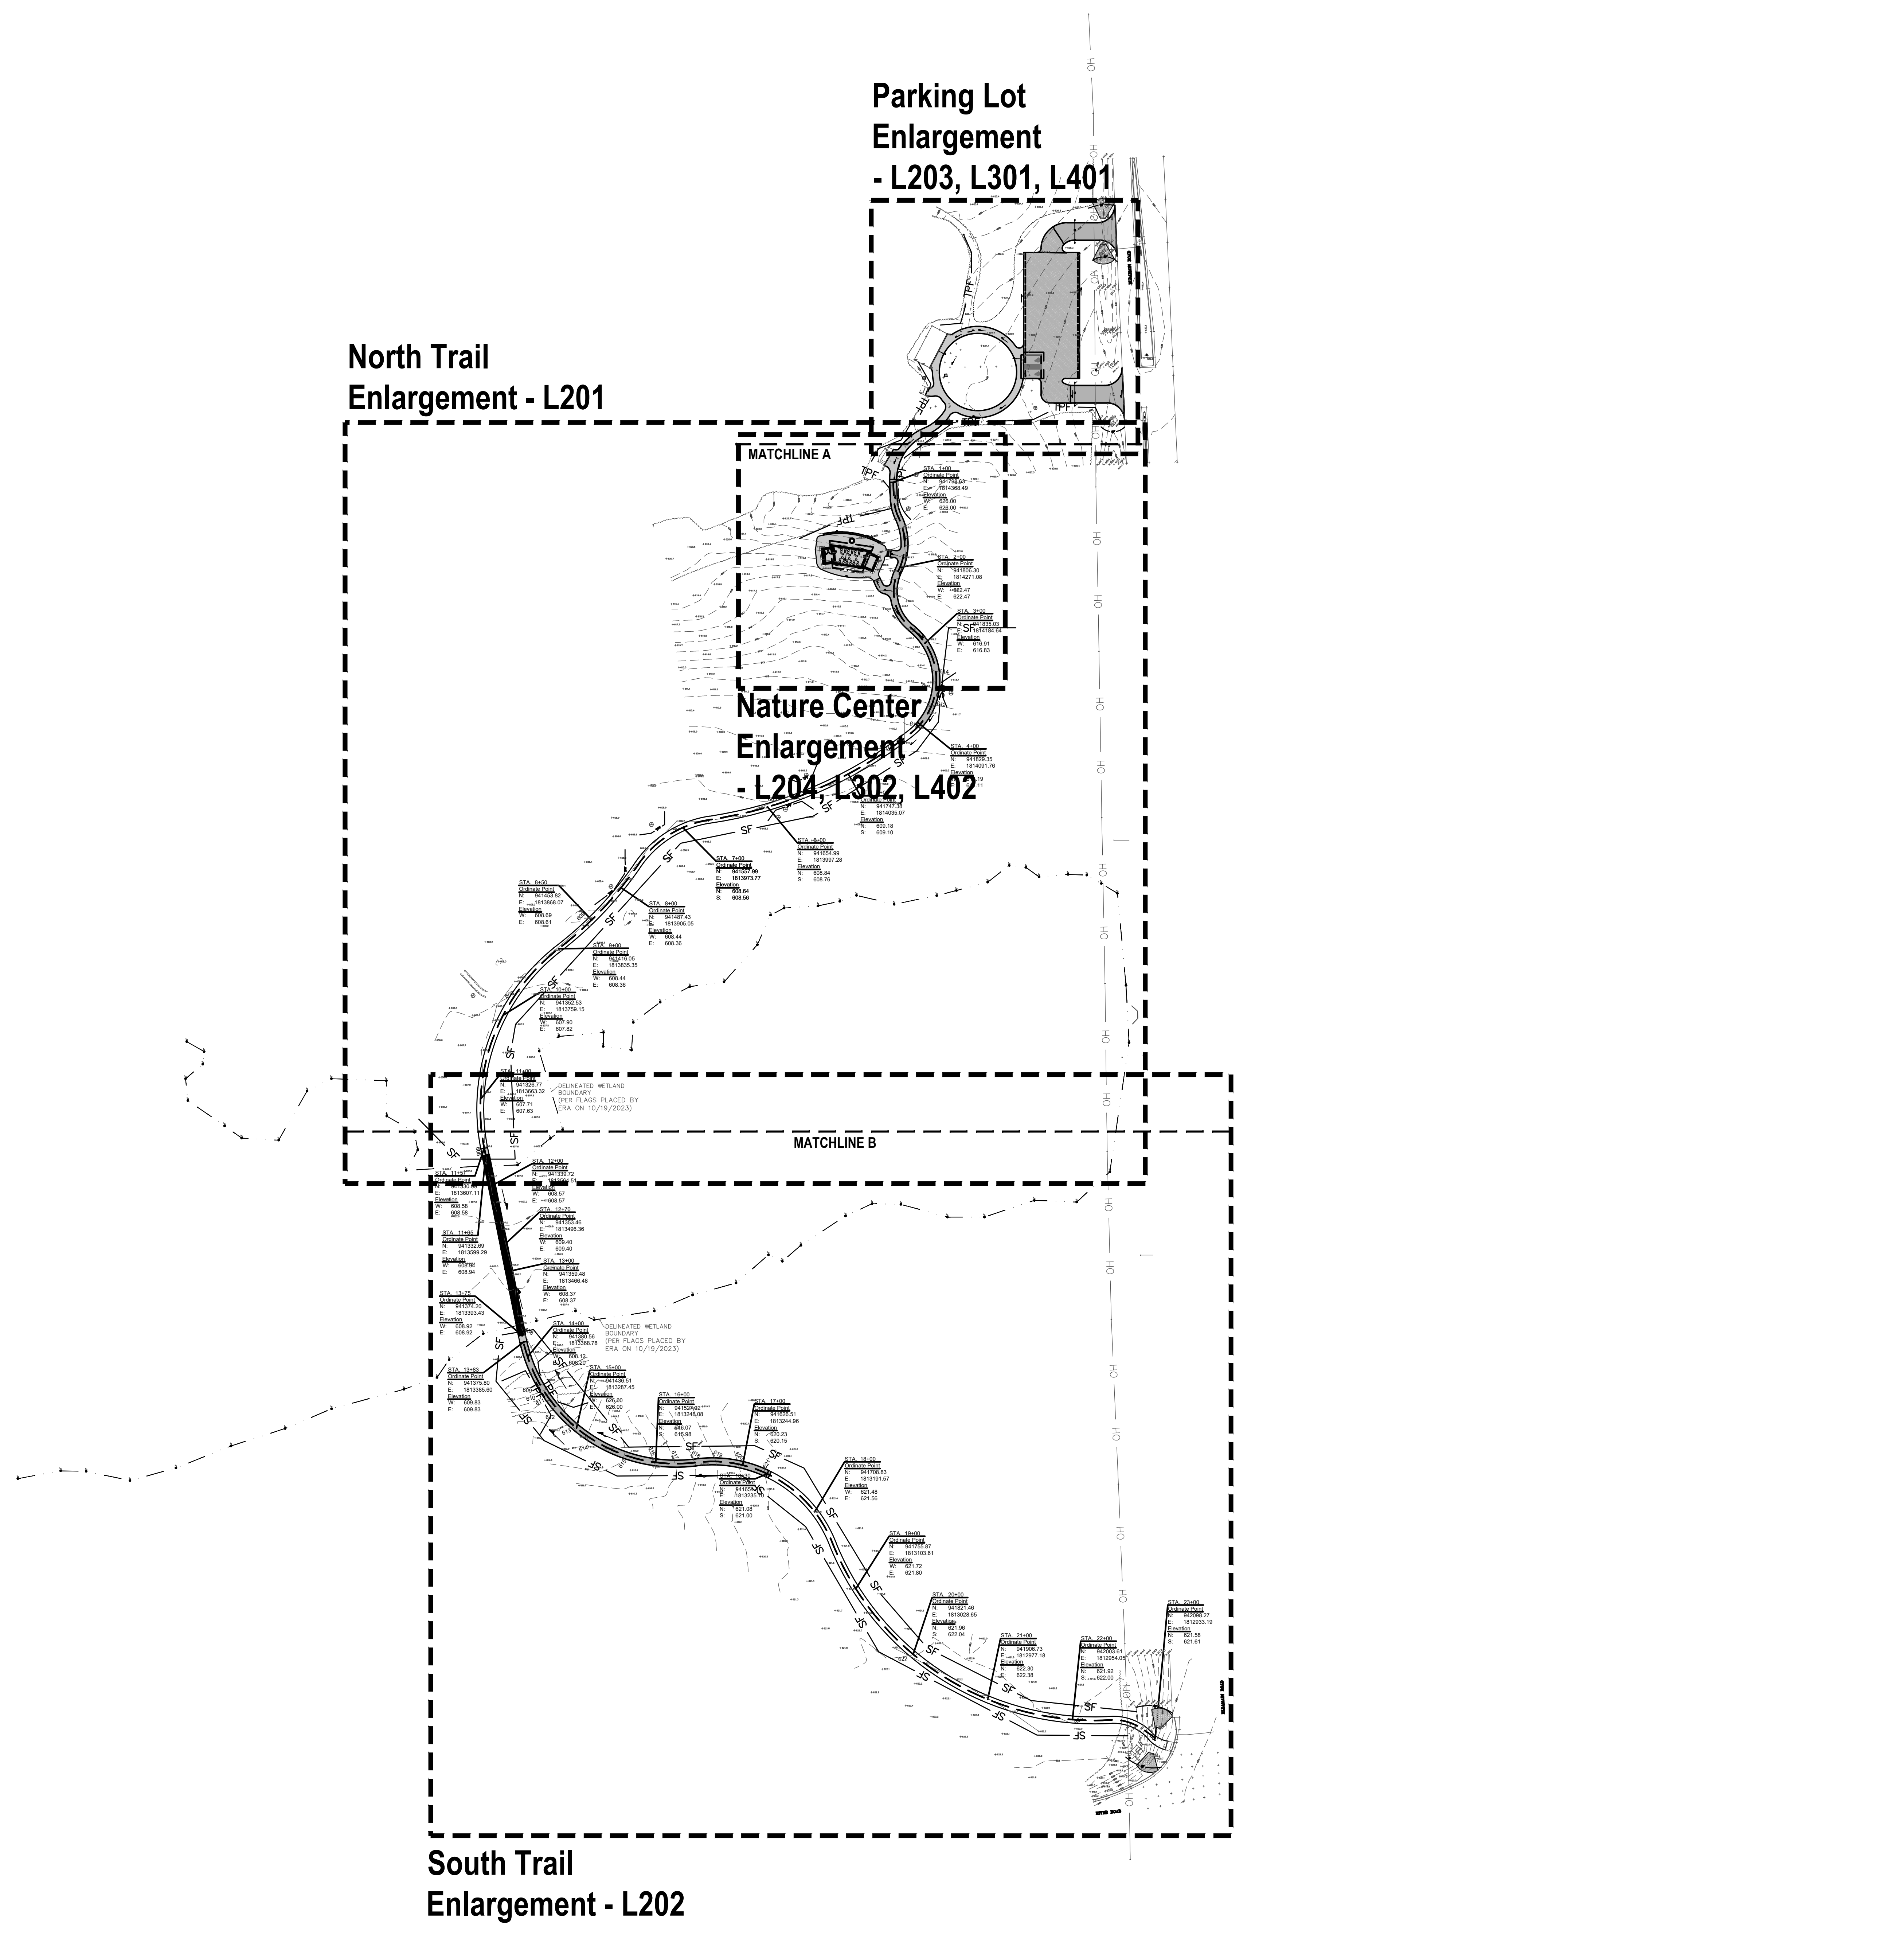
JOB NO. 23-428-1498  
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APPROVED MK

**SHEET TITLE**

**STORMWATER POLLUTION PREVENTION PLAN**

**SHEET NUMBER**

**L101**



GENERAL NOTES: LAYOUT

- 1. It is the responsibility of the Contractor to perform layout of all project elements and points for review by Owner prior to construction. (This work is considered incidental to the project and not paid as a separate bid item).
- 2. The contractor shall be responsible for all materials and quantities as required to complete the work in accordance with the plans and specifications. The contractor will notify the Owner's Representative in writing of any discrepancies or changes required to complete the work before any action may be taken. All changes or change orders must be approved by the Owner's Representative and Owner before any changes are executed.

REFERENCED SPECIFICATIONS AND CODES

- 1. The Americans with Disabilities Act and the Illinois Accessibility Code.
- 2. The Illinois Procedures and Standards for Urban Soil Erosion and Sedimentation Control, and IEPA Standards and Specifications for Soil Erosion and Sedimentation Control.
- 3. U.S. Soil Conservation Service Field Engineering Handbook
- 4. All codes and ordinances of the City of Plano, United States Army Corp of Engineers, Illinois Department of Natural Resources, Kendall County Soil and Water Conservation Districts, and all agencies having jurisdiction.
- 5. All requirements of the Occupational Safety and Health Administration.
- 6. The cited standard specifications, codes and permits, with these construction plans and details, are all to be considered part of the work, incidental items or accessories necessary to complete this work may not be specifically noted but are considered a part of these improvements.
- 7. In case of conflict, the more restrictive provision shall apply.

GENERAL NOTES: DIMENSION


- 1. Paving radii shall be formed completely and shall smoothly transition into tangents and adjoining lines. Dimensions are to face of curb and edge of pavement unless otherwise specified.
- 2. Dimensions are in feet or degrees. Dimensions are perpendicular & parallel unless otherwise noted.
- 3. See Layout Plan, Sheet L300 for additional general notes and referenced specifications and codes.
- 4. Contractor shall perform all construction layout for the project. Contractor will be provided with an electronic file in AutoCAD format to assist with layout. Neither the Owner nor their representative shall be responsible for setting additional layout points.

GENERAL NOTES: GRADING

- 1. Finished surfaces to be smooth and even with no abrupt or awkward changes in grade. Paving to meet adjacent grades flush and smooth.
- 2. Contractor shall restore all areas disturbed as a result of construction.
- 3. All walks, drives and paved areas are to follow ADA per incorporated specifications. Any deviation shall be removed and reinstalled to follow this law.
- 4. All Accessible Route paving shall not exceed 4.5% in any direction. Cross slopes shall be less than 2%. Contractor shall slope all walks and slabs to eliminate ponding. ADA Turning Radius paving shall be less than 2% in all directions.
- 5. This work shall include the excavation, stockpile, and placement of topsoil and suitable excavated material.
- 6. Follow the Illinois Procedures and Standards for Urban Soil Erosion and Sedimentation Control, IEPA Standards and Specifications for Soil Erosion and Sedimentation Control, and U.S. Soil Conservation Service Field Engineering Handbook.
- 7. Transitions between paving types (i.e. concrete to asphalt) shall be smooth. Transitions not to exceed 1/4" vertical or horizontal difference.

LEGEND

	Asphalt Paving
	Concrete Paving
	Crushed Limestone Surfacing
	Gravel Surfacing
	Boardwalk
	EJ Concrete Expansion Joints
	CL Construction Limits / Construction Fence

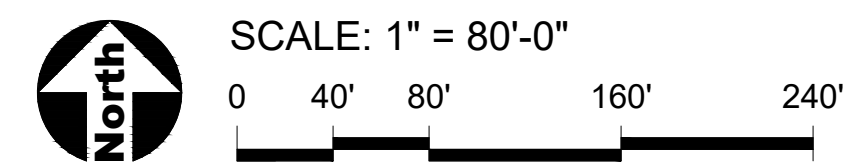

NOTE: SCALES DEPICTED ON THIS DRAWING ARE NOT CORRECT UNLESS PLOTTED SHEET SIZE IS 30 X 42 INCHES.

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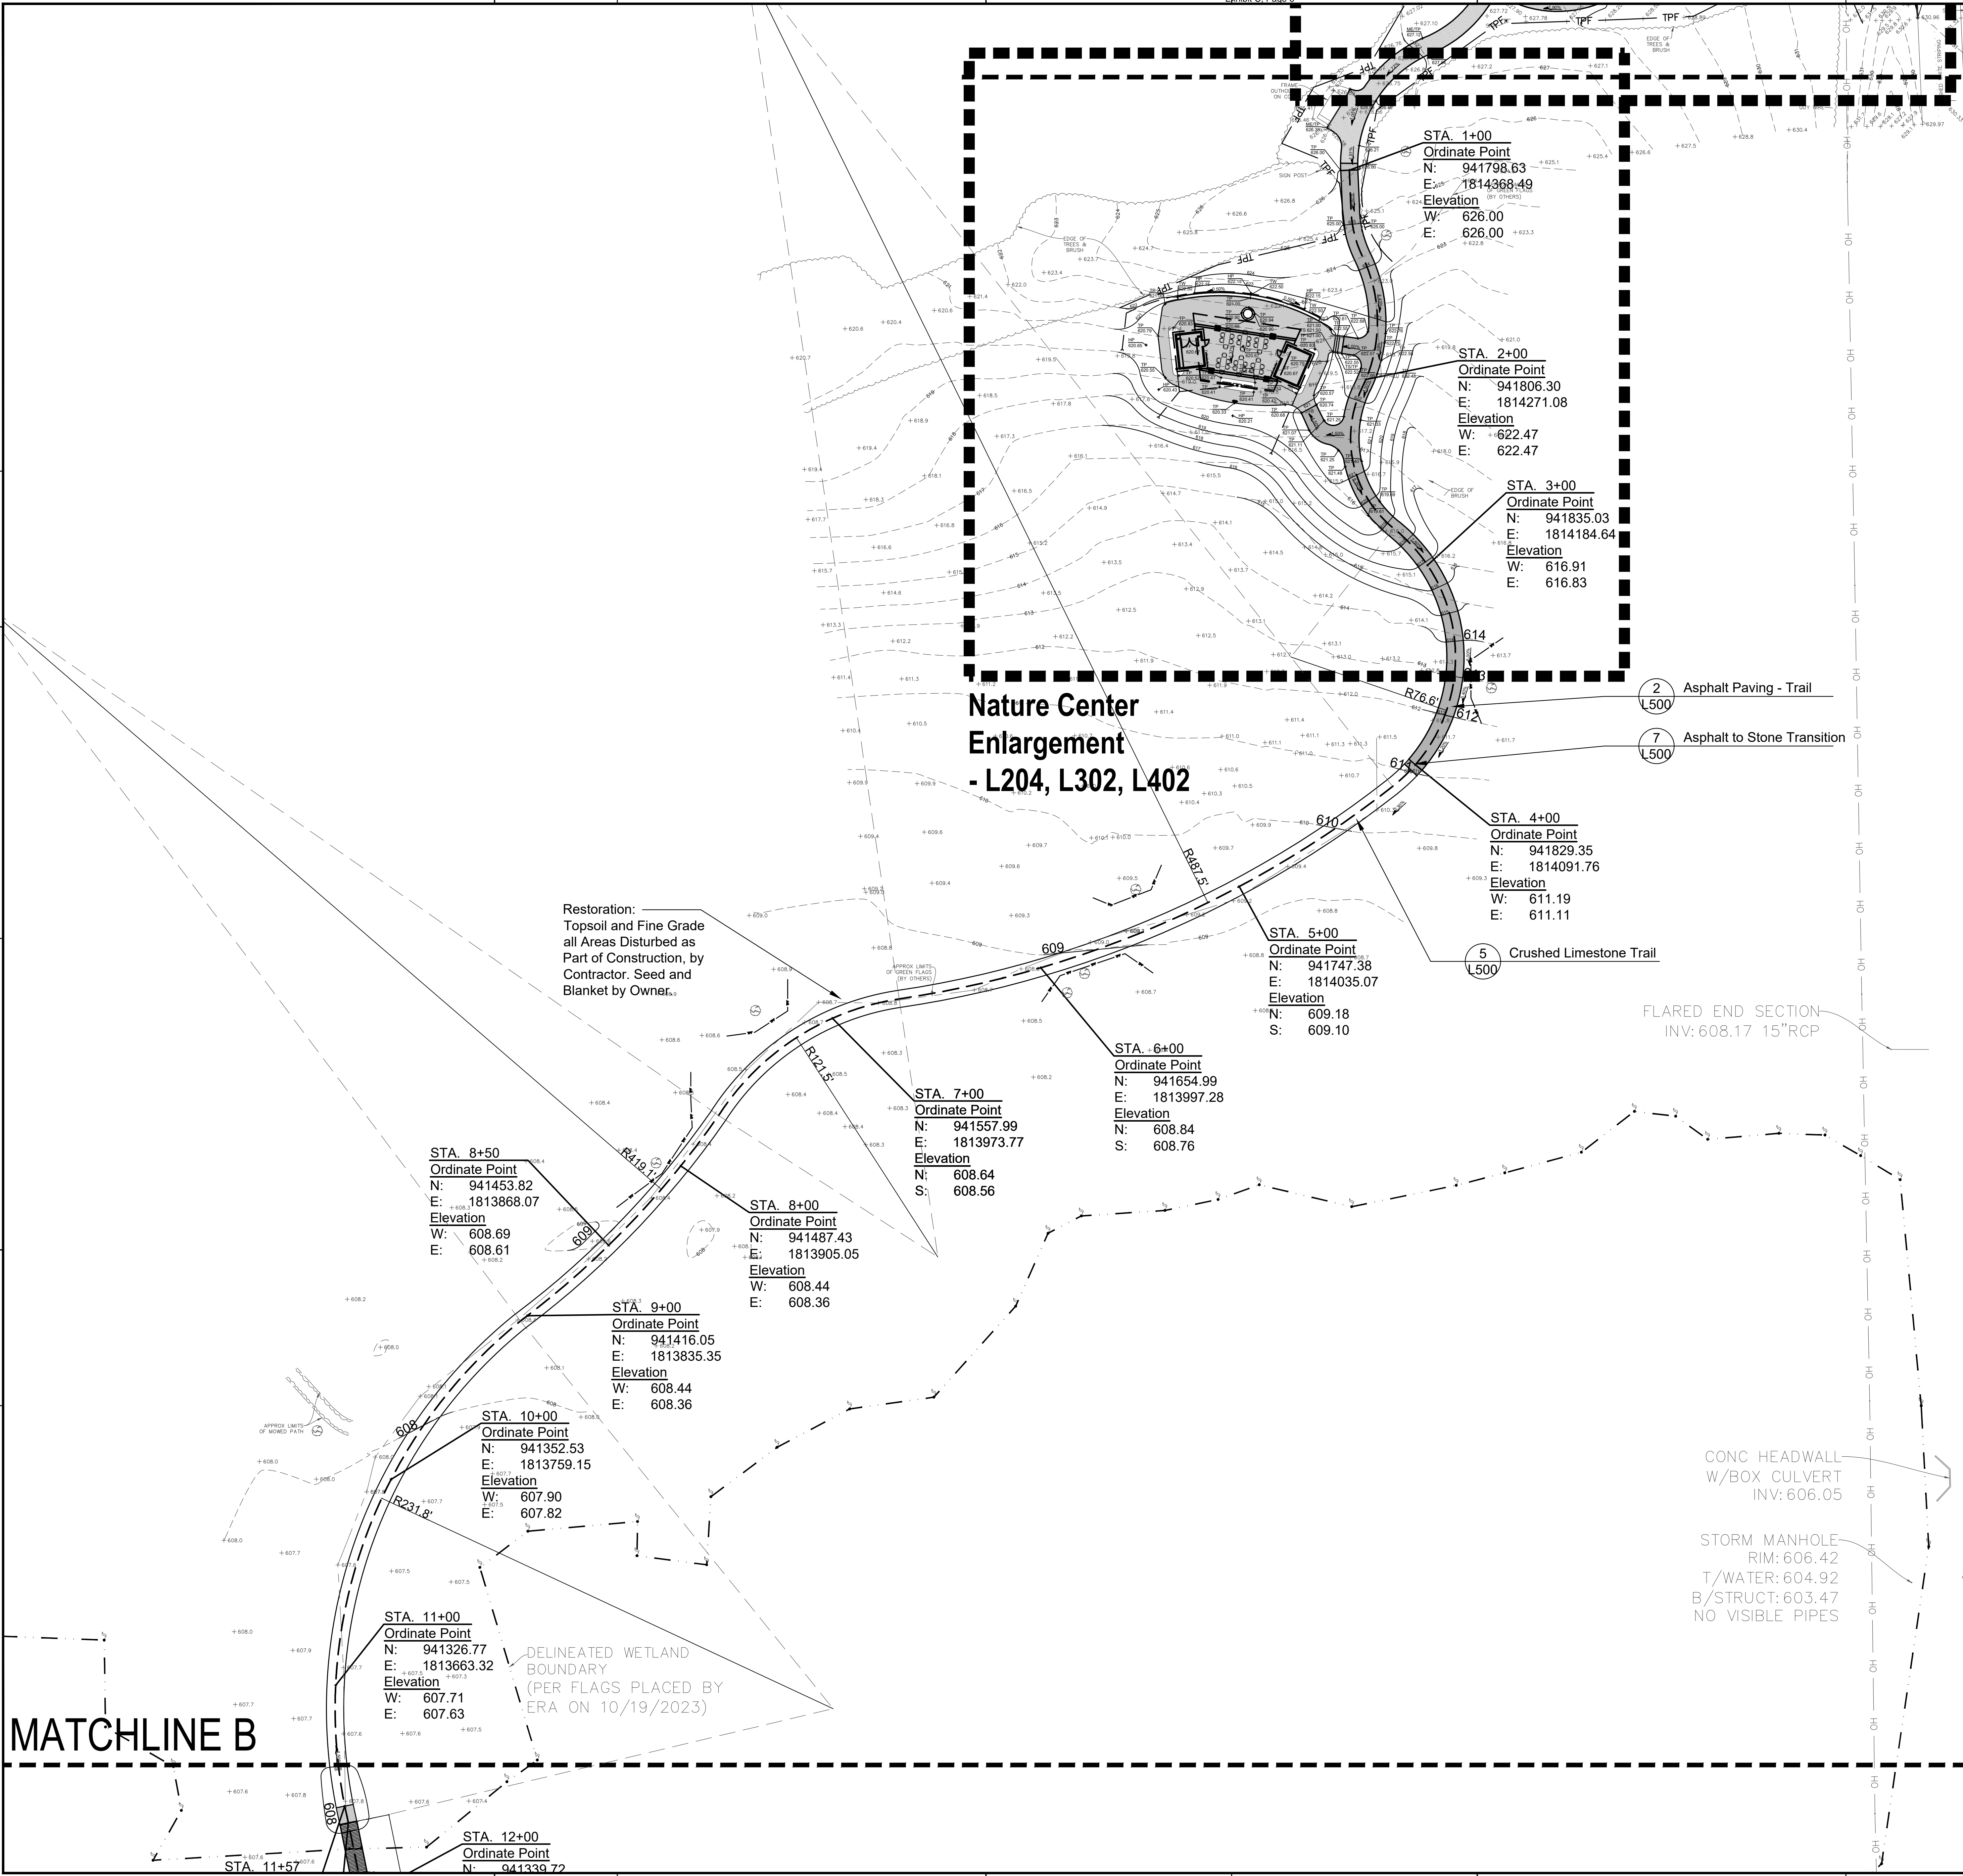


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APPROVED	MK

LAYOUT PLAN - OVERALL

L200



**GENERAL NOTES: LAYOUT**  
1. See Sheet L200 for Notes

**REFERENCED SPECIFICATIONS AND CODES**  
1. See Sheet L200 for Notes

**GENERAL NOTES: DIMENSION**  
1. See Sheet L200 for Dimension Notes

**GENERAL NOTES: GRADING**  
1. See Sheet L200 for Grading Notes


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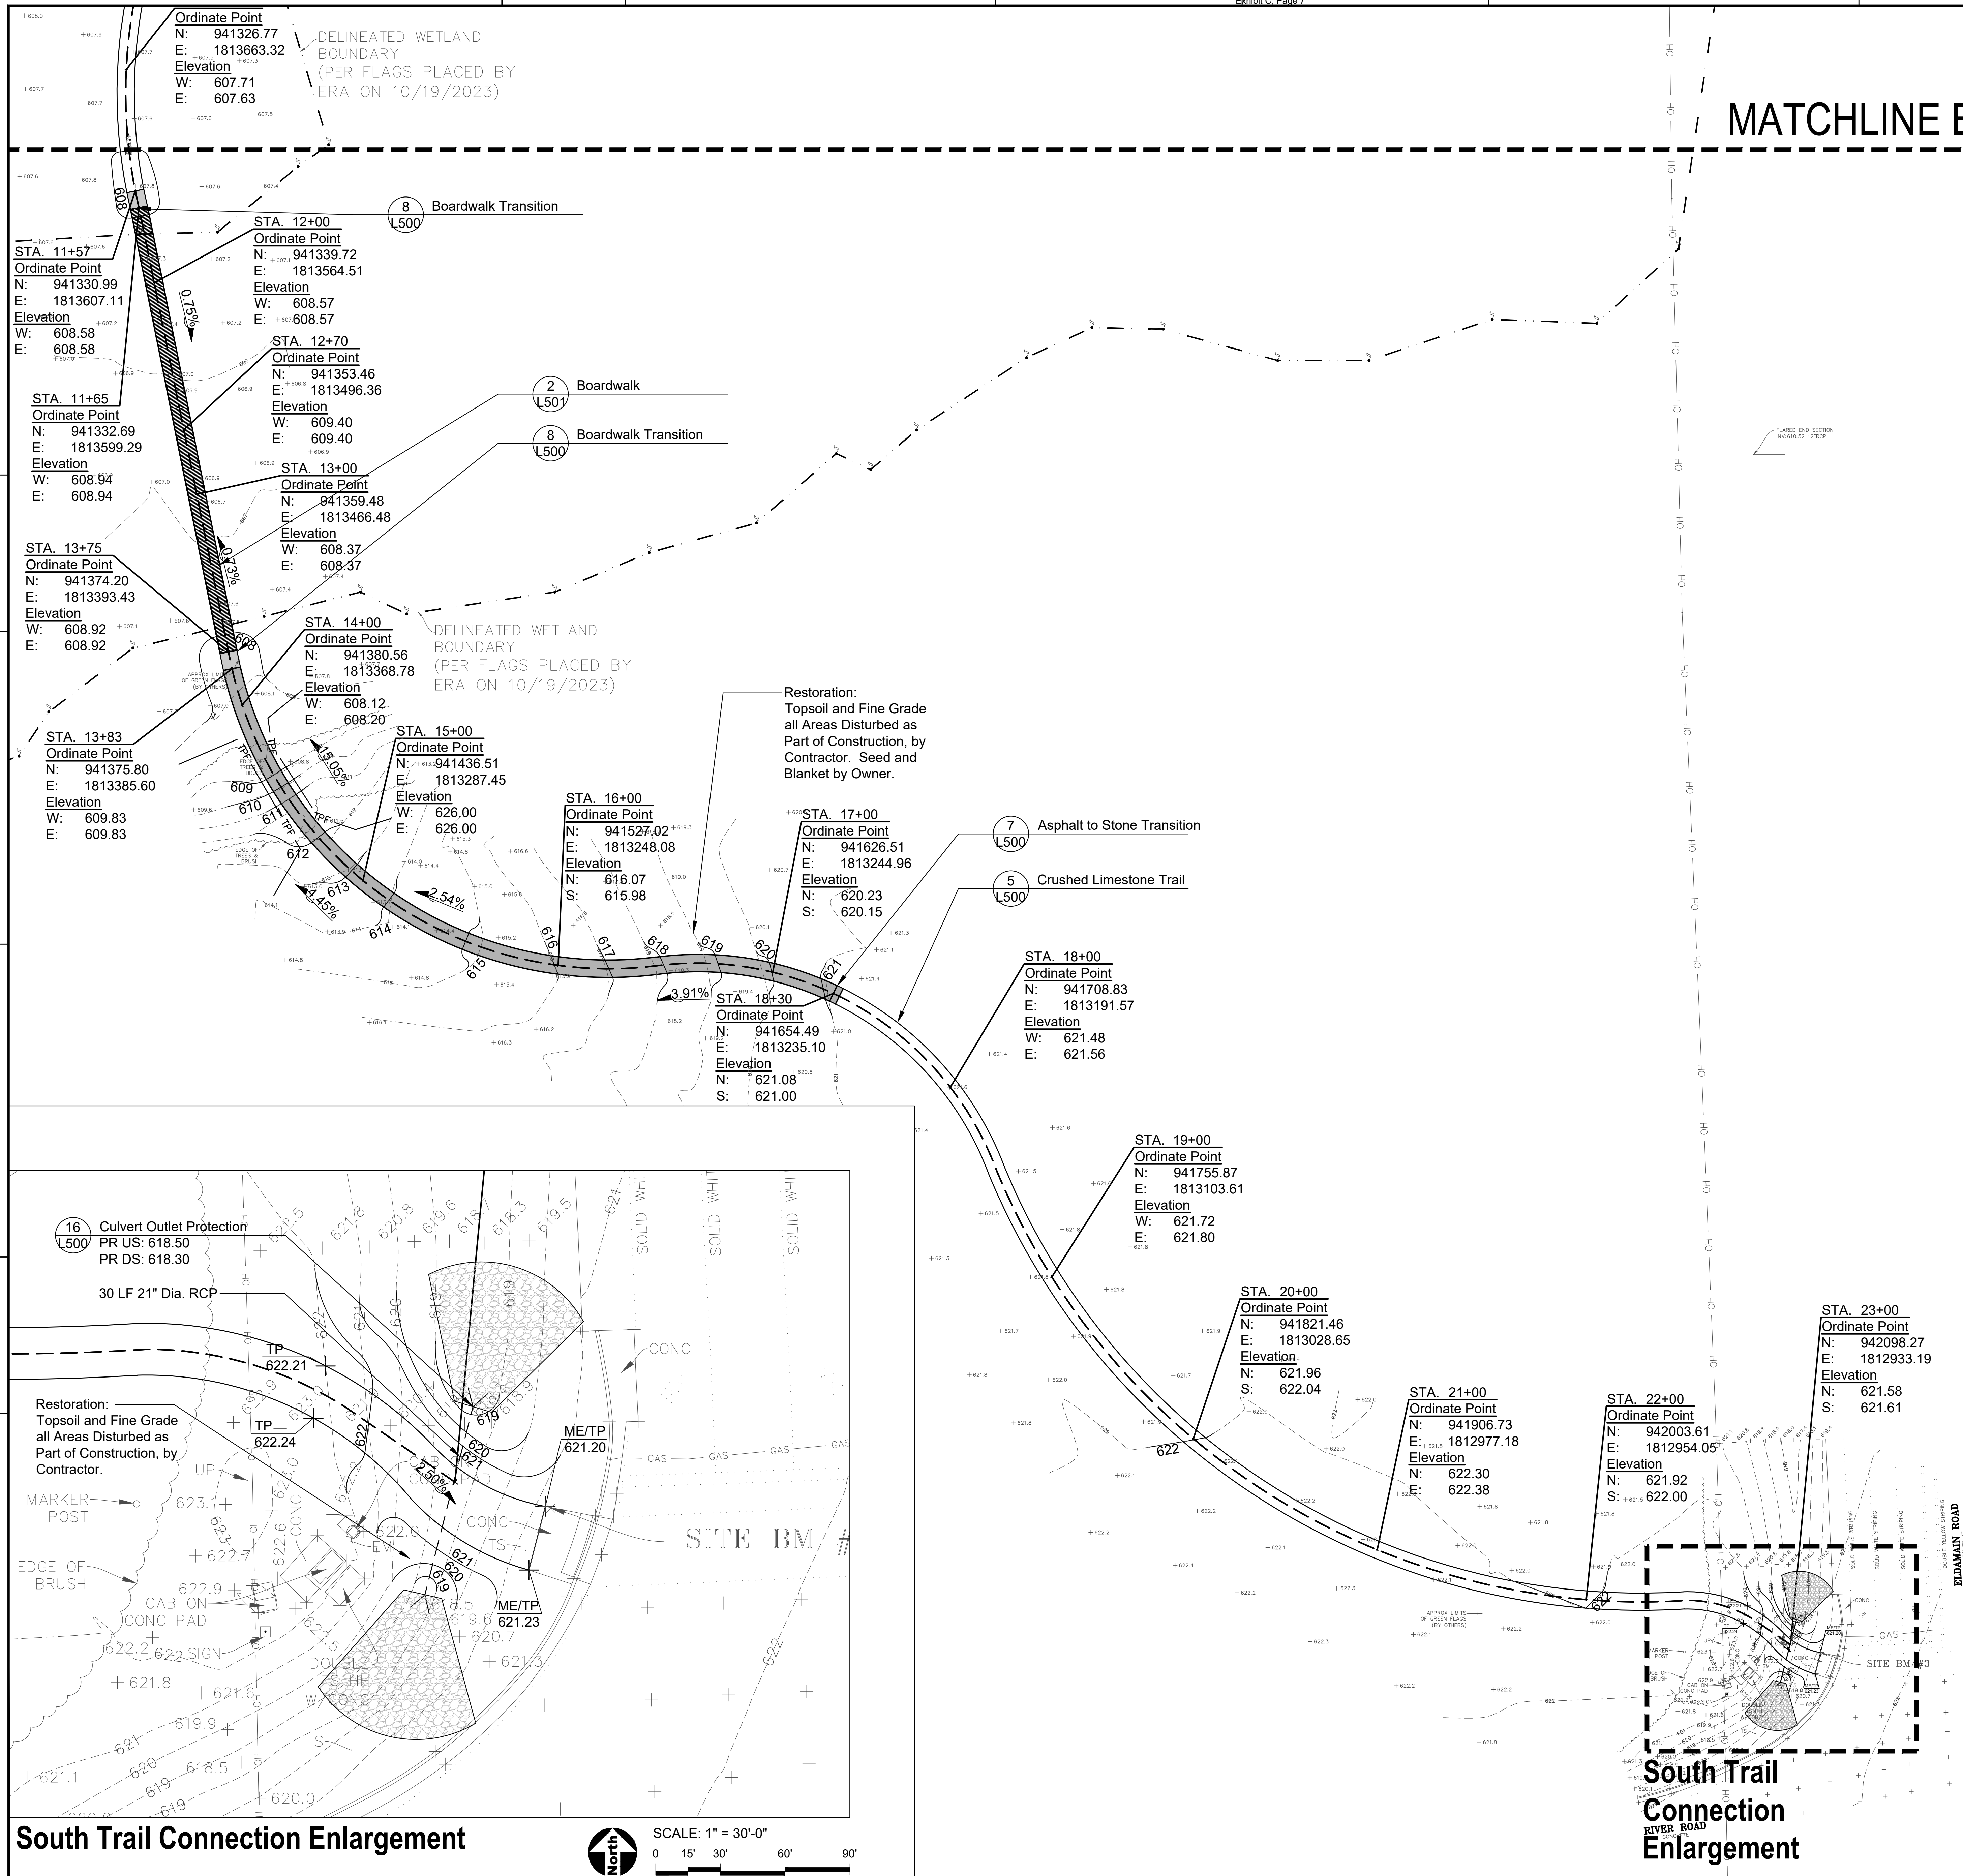


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JOB NO.	23-428-1485
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**SHEET TITLE**  
LAYOUT, DIMENSION, & GRADING PLAN - NORTH TRAIL

**SHEET NUMBER**  
L201

**MATCHLINE B**

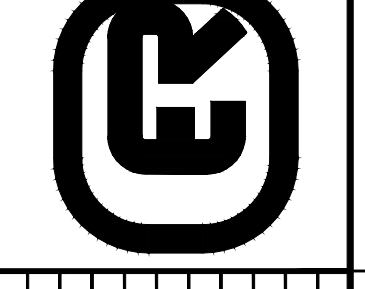

# MATCHLINE B

### GENERAL NOTES: LAYOUT

1. See Sheet L200 for Notes

### REFERENCED SPECIFICATIONS AND CODES

1. See Sheet L200 for Notes

### GENERAL NOTES: DIMENSION

1. See Sheet L200 for Dimension Notes


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1. See Sheet L200 for Grading Notes


### LEGEND

- Asphalt Paving
- Concrete Paving
- Crushed Limestone Surfacing
- Gravel Surfacing
- Boardwalk
- EJ Concrete Expansion Joints
- CL Construction Limits / Construction Fence

## South Trail Connection Enlargement

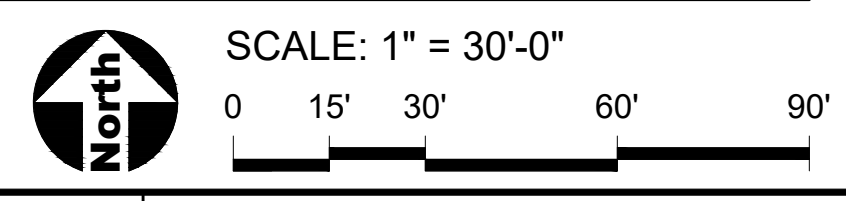

## South Trail Connection Enlargement

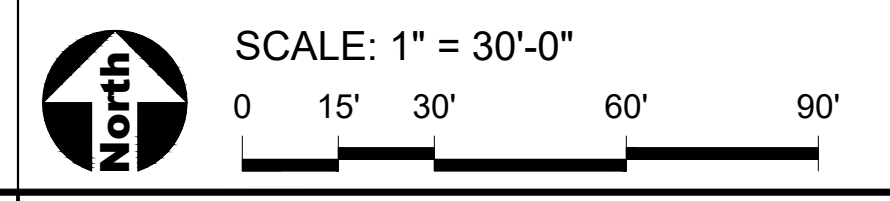

NOTE: SCALES DEPICTED ON THIS DRAWING ARE NOT CORRECT UNLESS PLOTTED SHEET SIZE IS 30 X 42 INCHES.


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SHEET TITLE

LAYOUT, DIMENSION, & GRADING PLAN - SOUTH TRAIL

SHEET NUMBER

# L202

GENERAL NOTES: LAYOUT

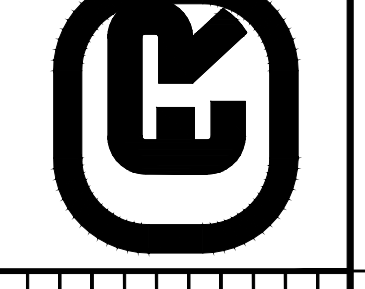- See Sheet L200 for Layout Notes.

REFERENCED SPECIFICATIONS AND CODES

- See Sheet L200 for Referenced Specification and Codes.

- 15 Cable Gate
- 1 Asphalt Paving - Parking
- 6 12" Gravel Parking Lot

- 5 Crushed Limestone Trail
- 13 Wheelstop
- 7 Asphalt to Stone Transition
- 1 Asphalt Paving - Parking
- 12 Multiple Access ADA Parking

- 1 ADA Van Sign
- 1 - New
- 1 - Relocated

LEGEND

- Asphalt Paving
- Concrete Paving
- Crushed Limestone Surfacing
- Gravel Surfacing
- Boardwalk
- EJ Concrete Expansion Joints
- CL Construction Limits / Construction Fence



SCALE: 1" = 10'-0"



NOTE: SCALES DEPICTED ON THIS DRAWING ARE NOT CORRECT UNLESS PLOTTED SHEET SIZE IS 30 X 42 INCHES.

MATCHLINE A

WOOD SIGN  
CANOPY

CANOPY  
OVER CONC

AGGREGATE

EDGE OF  
TREES &  
BRUSH

SOLID WHITE STRIPING  
ELDAMAIN ROAD  
CONCRETE

SIG

ASHED WHITE STRIPING


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SHEET TITLE  
LAYOUT PLAN  
- PARKING LOT  
ENLARGEMENT

SHEET NUMBER

**L203**

# MATCHLINE A

### GENERAL NOTES: LAYOUT

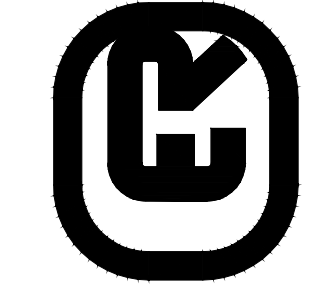1. See Sheet L200 for Notes

### REFERENCED SPECIFICATIONS AND CODES

1. See Sheet L200 for Notes

BASE BID: Broom Finish Natural Concrete.  
ALTERNATE BID #2: Stamped and Stained Concrete. Refer to Architect's Drawings.

See Architect's drawings for building and concrete paving.

See Architect's drawings.

- 5 Crushed Limestone Trail (L500)
- 7 Asphalt to Stone Transition (L500)
- 9 Unit Retaining Wall (L500)
- 10 Unit Block Fire Pit (L500)

Future Restroom Building Location

Future Retaining Walls Location and Accessible Route

11 Stairs and Handrail (L500)


2 Asphalt Paving - Trail (L500)

SF SF SF SF SF

5' 5' 5' 5' 5' 5'

### LEGEND

- Asphalt Paving
- Concrete Paving
- Crushed Limestone Surfacing
- Gravel Surfacing
- Boardwalk
- EJ Concrete Expansion Joints
- CL Construction Limits / Construction Fence

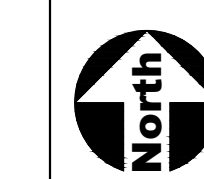

SCALE: 1" = 10'-0"



NOTE: SCALES DEPICTED ON THIS DRAWING ARE NOT CORRECT UNLESS PLOTTED SHEET SIZE IS 30 X 42 INCHES.

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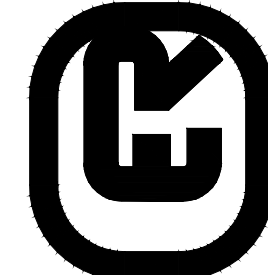
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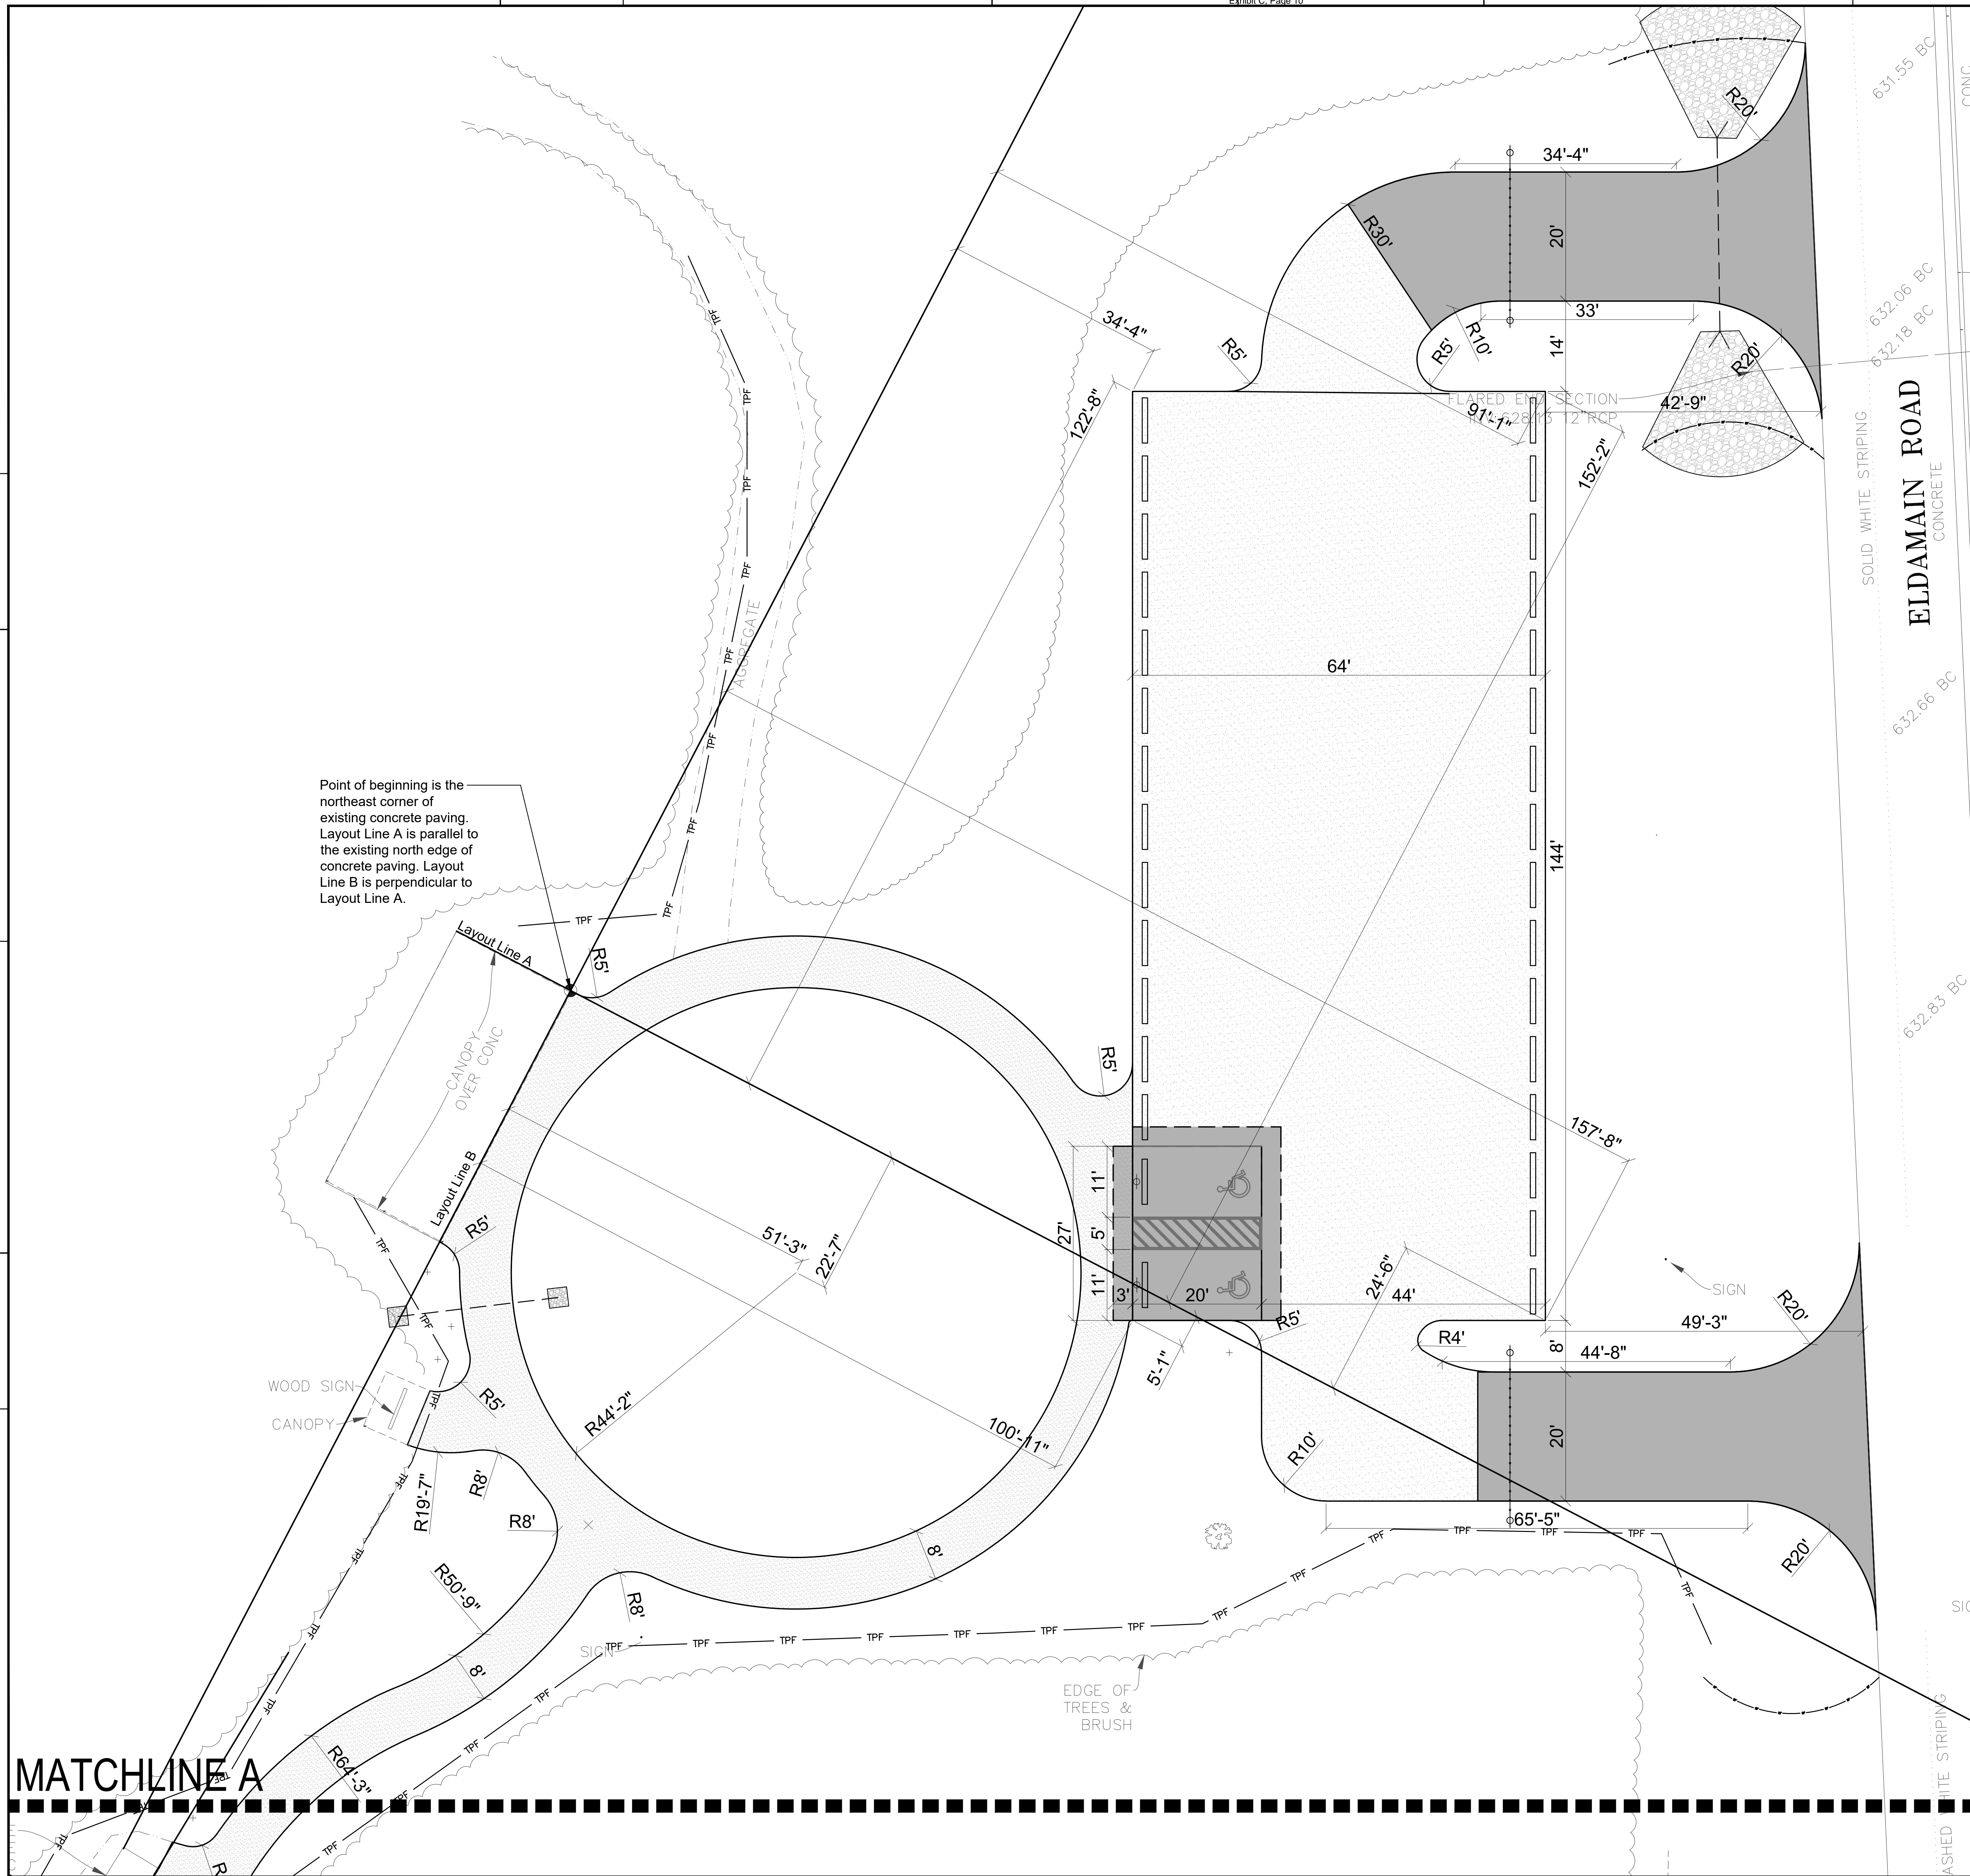
LAYOUT PLAN  
- NATURE CENTER  
ENLARGEMENT

### SHEET NUMBER

L204

GENERAL NOTES: DIMENSION


1. See Sheet L200 for Dimension Notes



Point of beginning is the northeast corner of existing concrete paving. Layout Line A is parallel to the existing north edge of concrete paving. Layout Line B is perpendicular to Layout Line A.

**LEGEND**

	Asphalt Paving
	Concrete Paving
	Crushed Limestone Surfacing
	Gravel Surfacing
	Boardwalk
	EJ Concrete Expansion Joints
	CL Construction Limits / Construction Fence

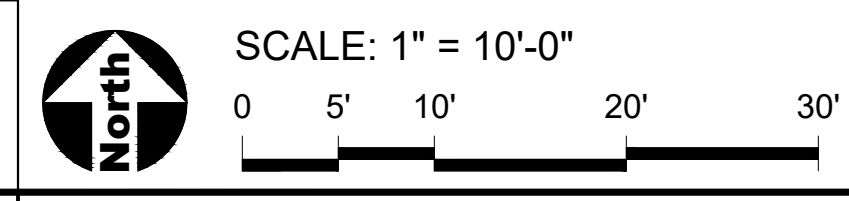

NOTE: SCALES DEPICTED ON THIS DRAWING ARE NOT CORRECT UNLESS PLOTTED SHEET SIZE IS 30 X 42 INCHES.

MATCHLINE A

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SHEET TITLE  
**DIMENSION PLAN - PARKING LOT ENLARGEMENT**

SHEET NUMBER


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# MATCHLINE A

### GENERAL NOTES: DIMENSION


- See Sheet L200 for Dimension Notes

Point of beginning is the south corner of existing building. Layout Line C is parallel to the existing south edge of building. Layout Line D is perpendicular to Layout Line C.

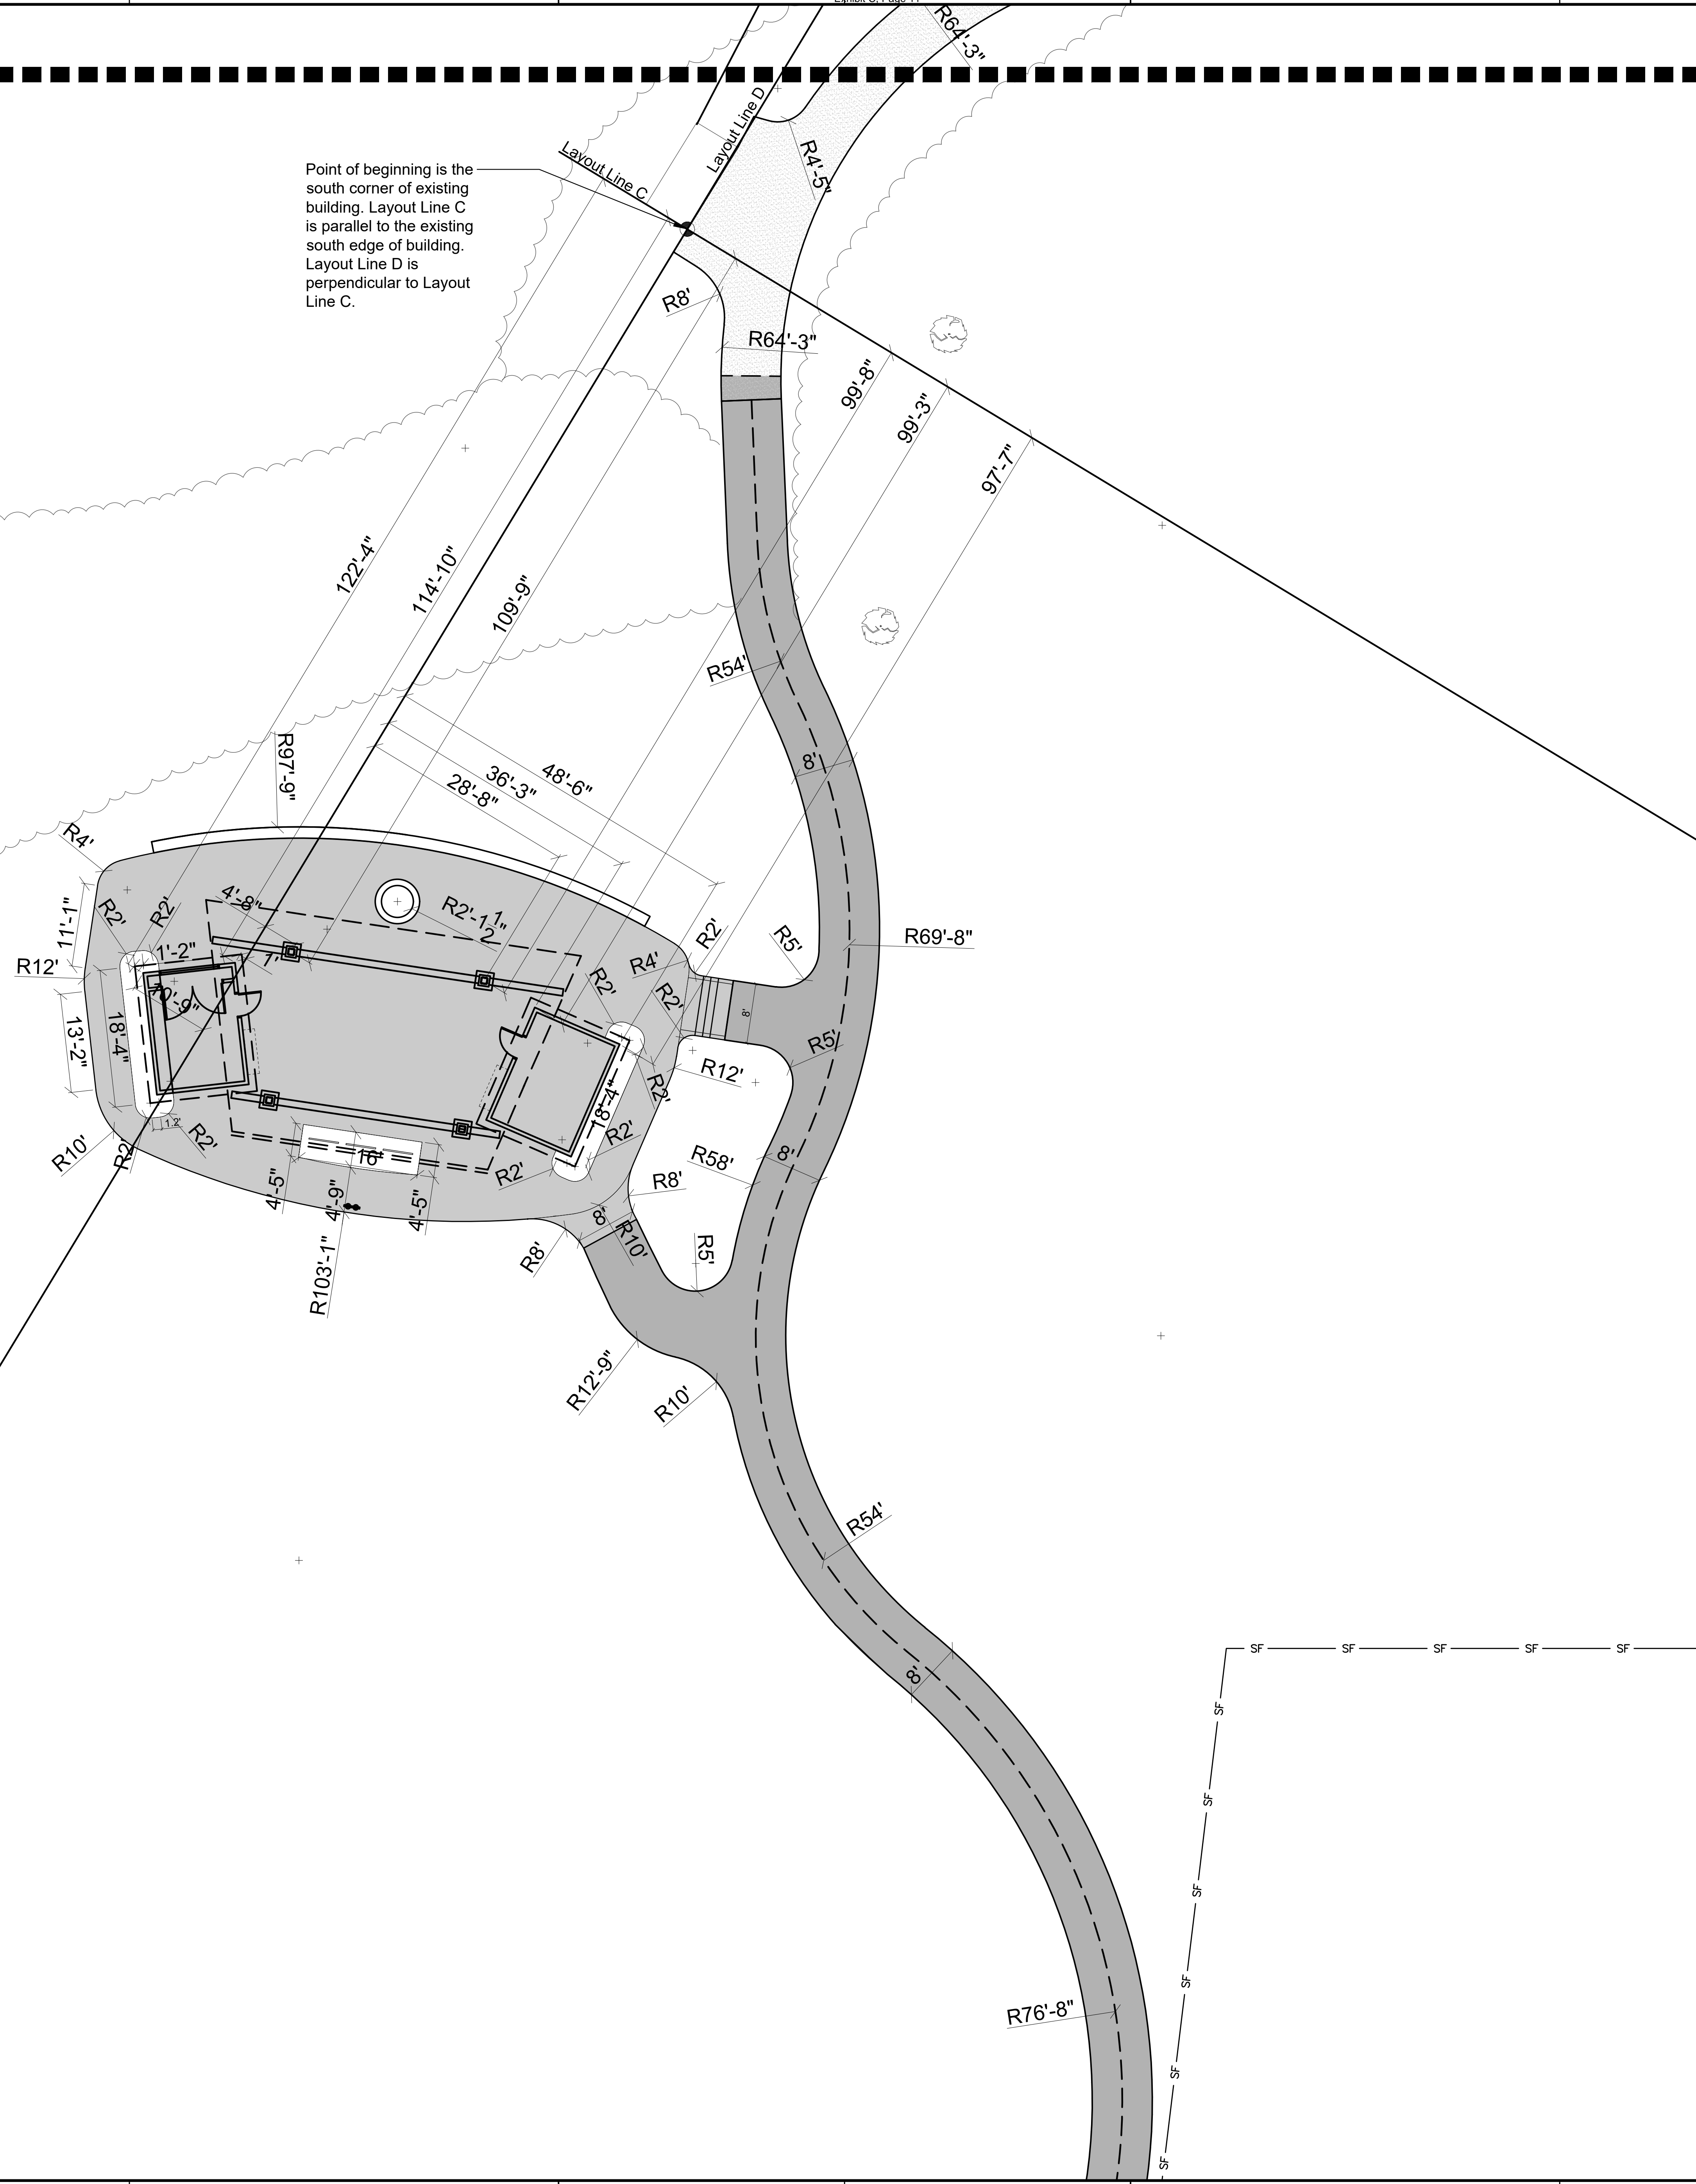

### LEGEND

- Asphalt Paving
- Concrete Paving
- Crushed Limestone Surfacing
- Gravel Surfacing
- Boardwalk
- EJ Concrete Expansion Joints
- CL Construction Limits / Construction Fence

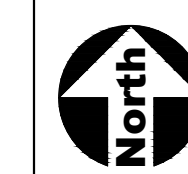

SCALE: 1" = 10'-0"



NOTE: SCALES DEPICTED ON THIS DRAWING ARE NOT CORRECT UNLESS PLOTTED SHEET SIZE IS 30 X 42 INCHES.

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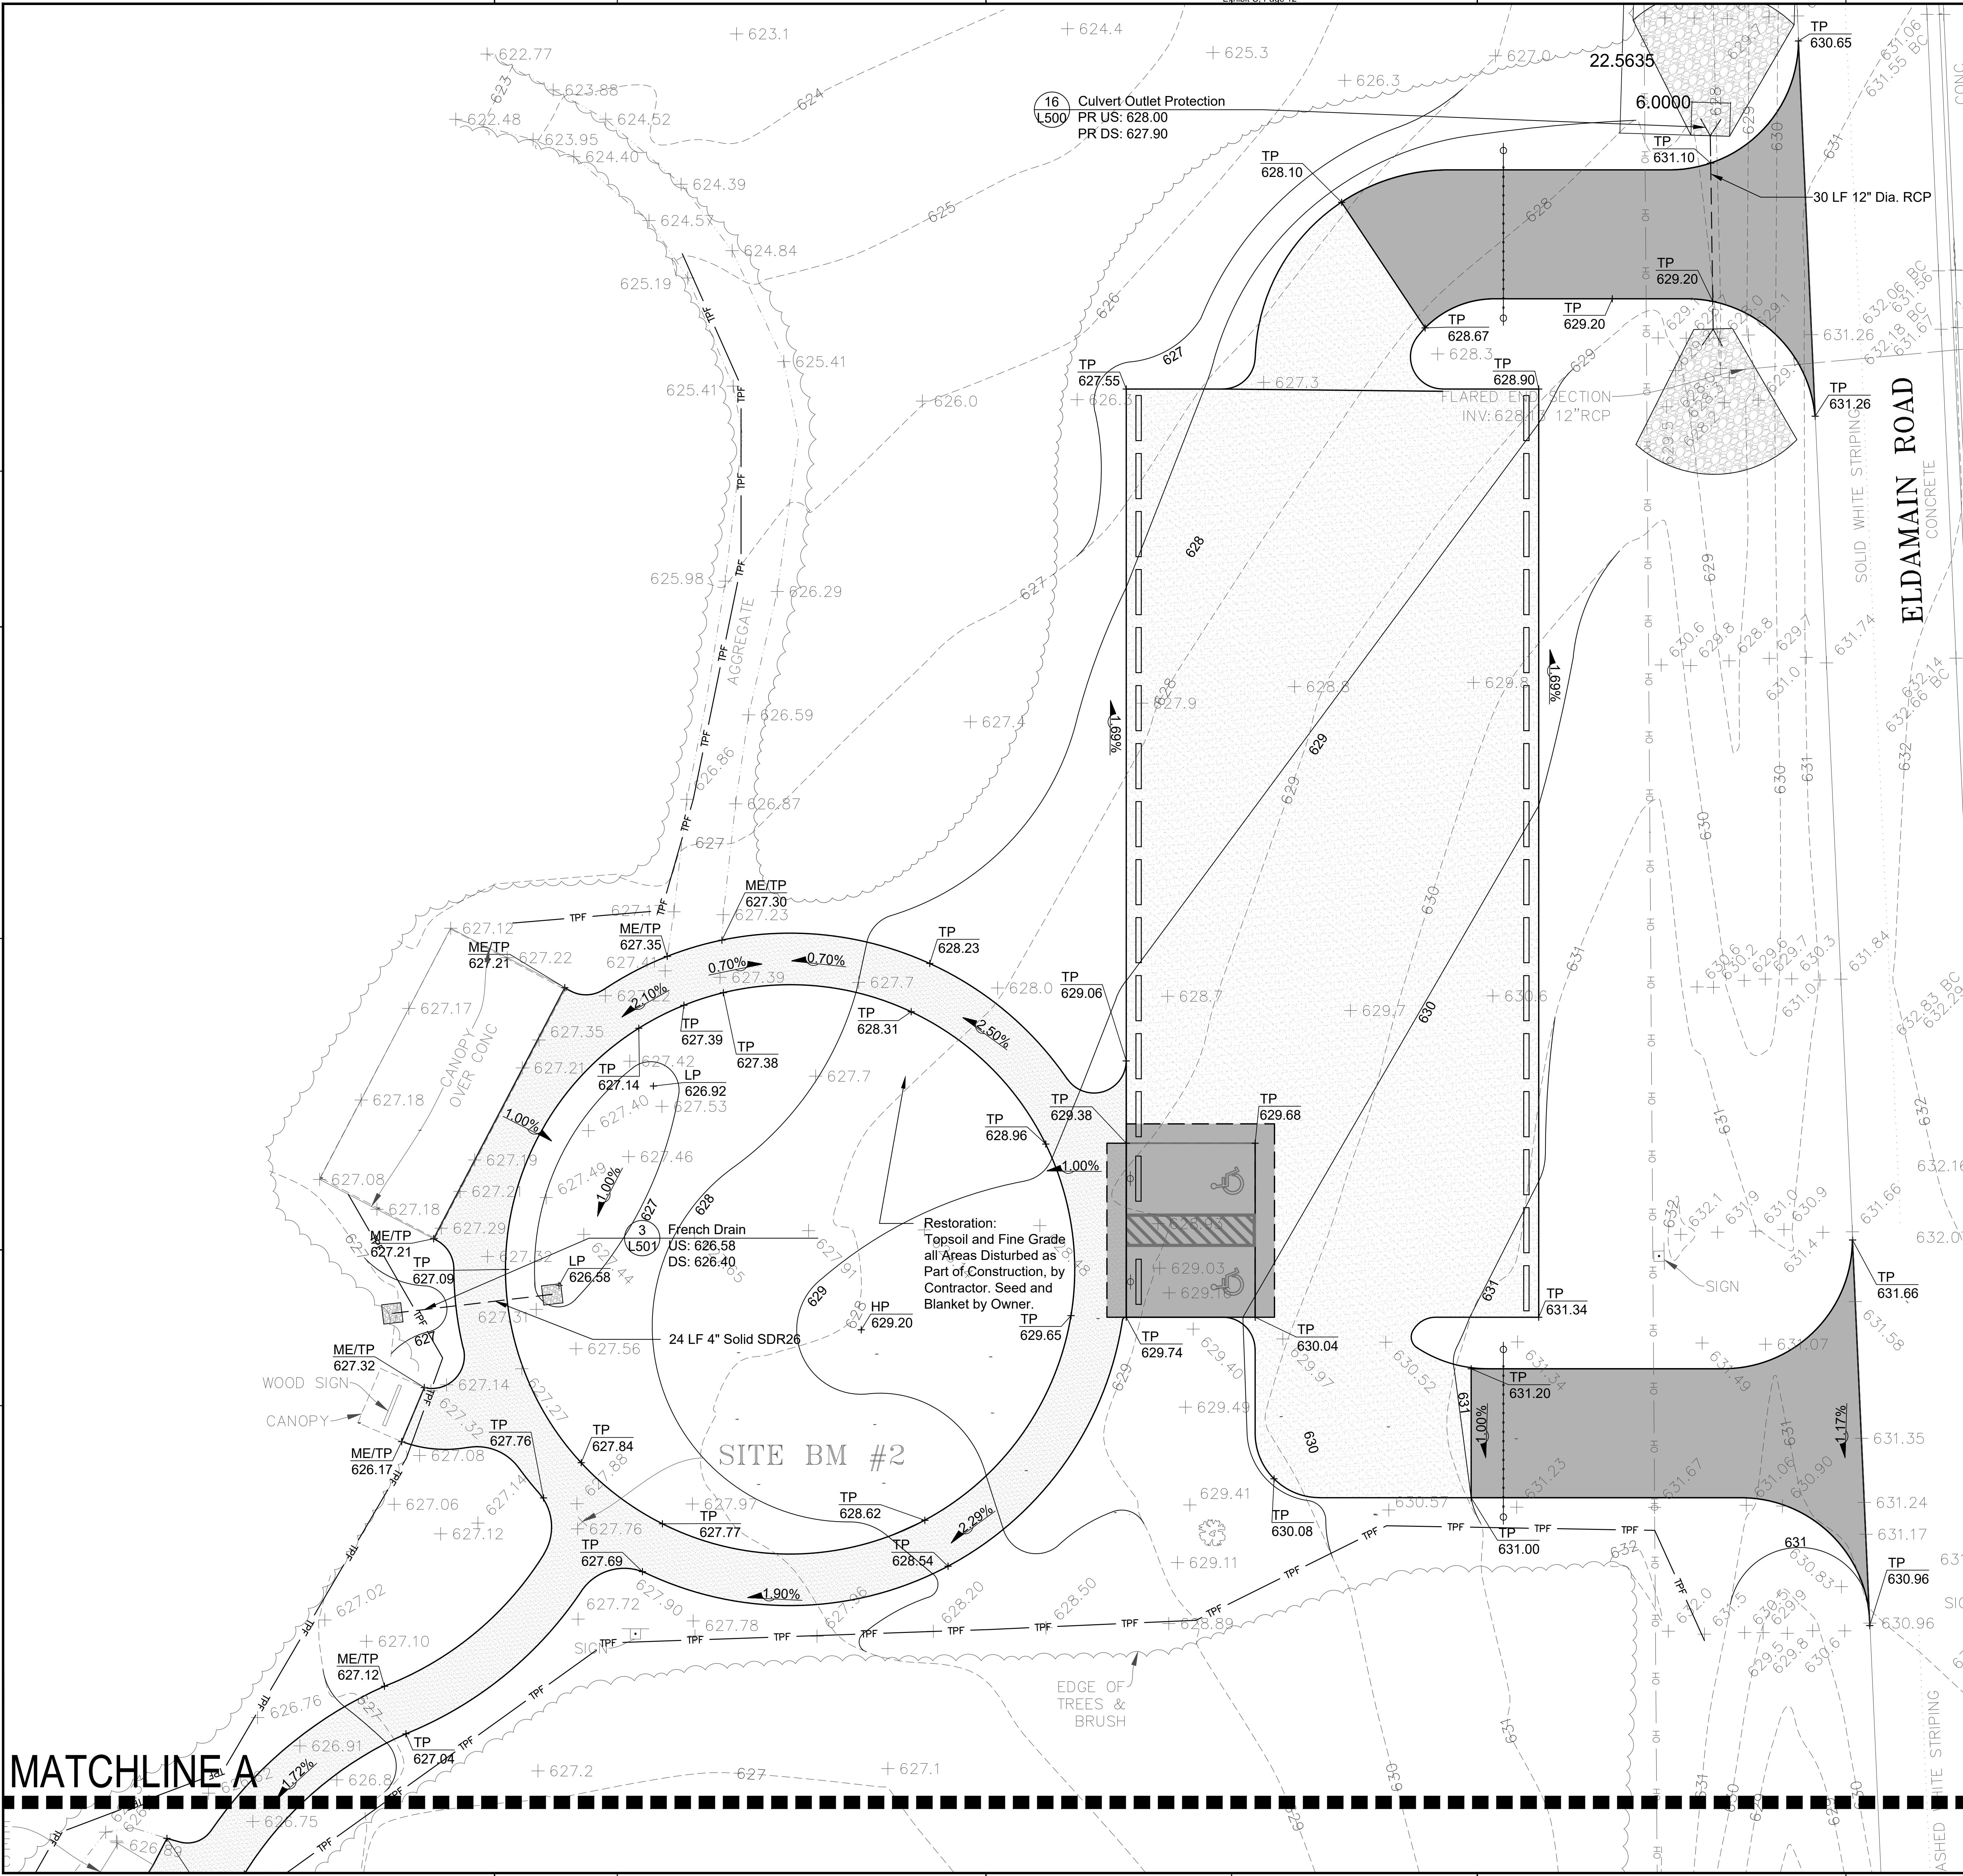
JOB NO. 23-428-1485  
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APPROVED MK

SHEET TITLE  
**DIMENSION PLAN - NATURE CENTER ENLARGEMENT**

SHEET NUMBER

**L302**





**GENERAL NOTES: GRADING**  
 1. See Sheet L200 for Grading Notes.

**LEGEND**

- 681 --- Existing Contour Line
- - - 681 - - - Proposed Contour Line
- + 683.35 + Existing Spot Elevation
- + 689.66 + Proposed Spot Elevation
- 2% ▾ Drainage Flow Direction
- CL — Construction Limits / Construction Fence

**INDEX OF ACRONYMS AND ABBREVIATIONS**

- HP - High Point
- INV - Pipe Invert Elevation
- LP - Low Point
- ME - Match Existing Elevation
- RIM - Top of Rim Elevation
- TC - Top of Curb
- TP - Top of Pavement
- TW - Top of Wall

**SCALE: 1" = 10'-0"**  
 0 5' 10' 20' 30'

**MATCHLINE A**

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SHEET TITLE  
**GRADING PLAN - PARKING LOT ENLARGEMENT**

SHEET NUMBER  
**L401**

NOTE: SCALES DEPICTED ON THIS DRAWING ARE NOT CORRECT UNLESS PLOTTED SHEET SIZE IS 30 X 42 INCHES.

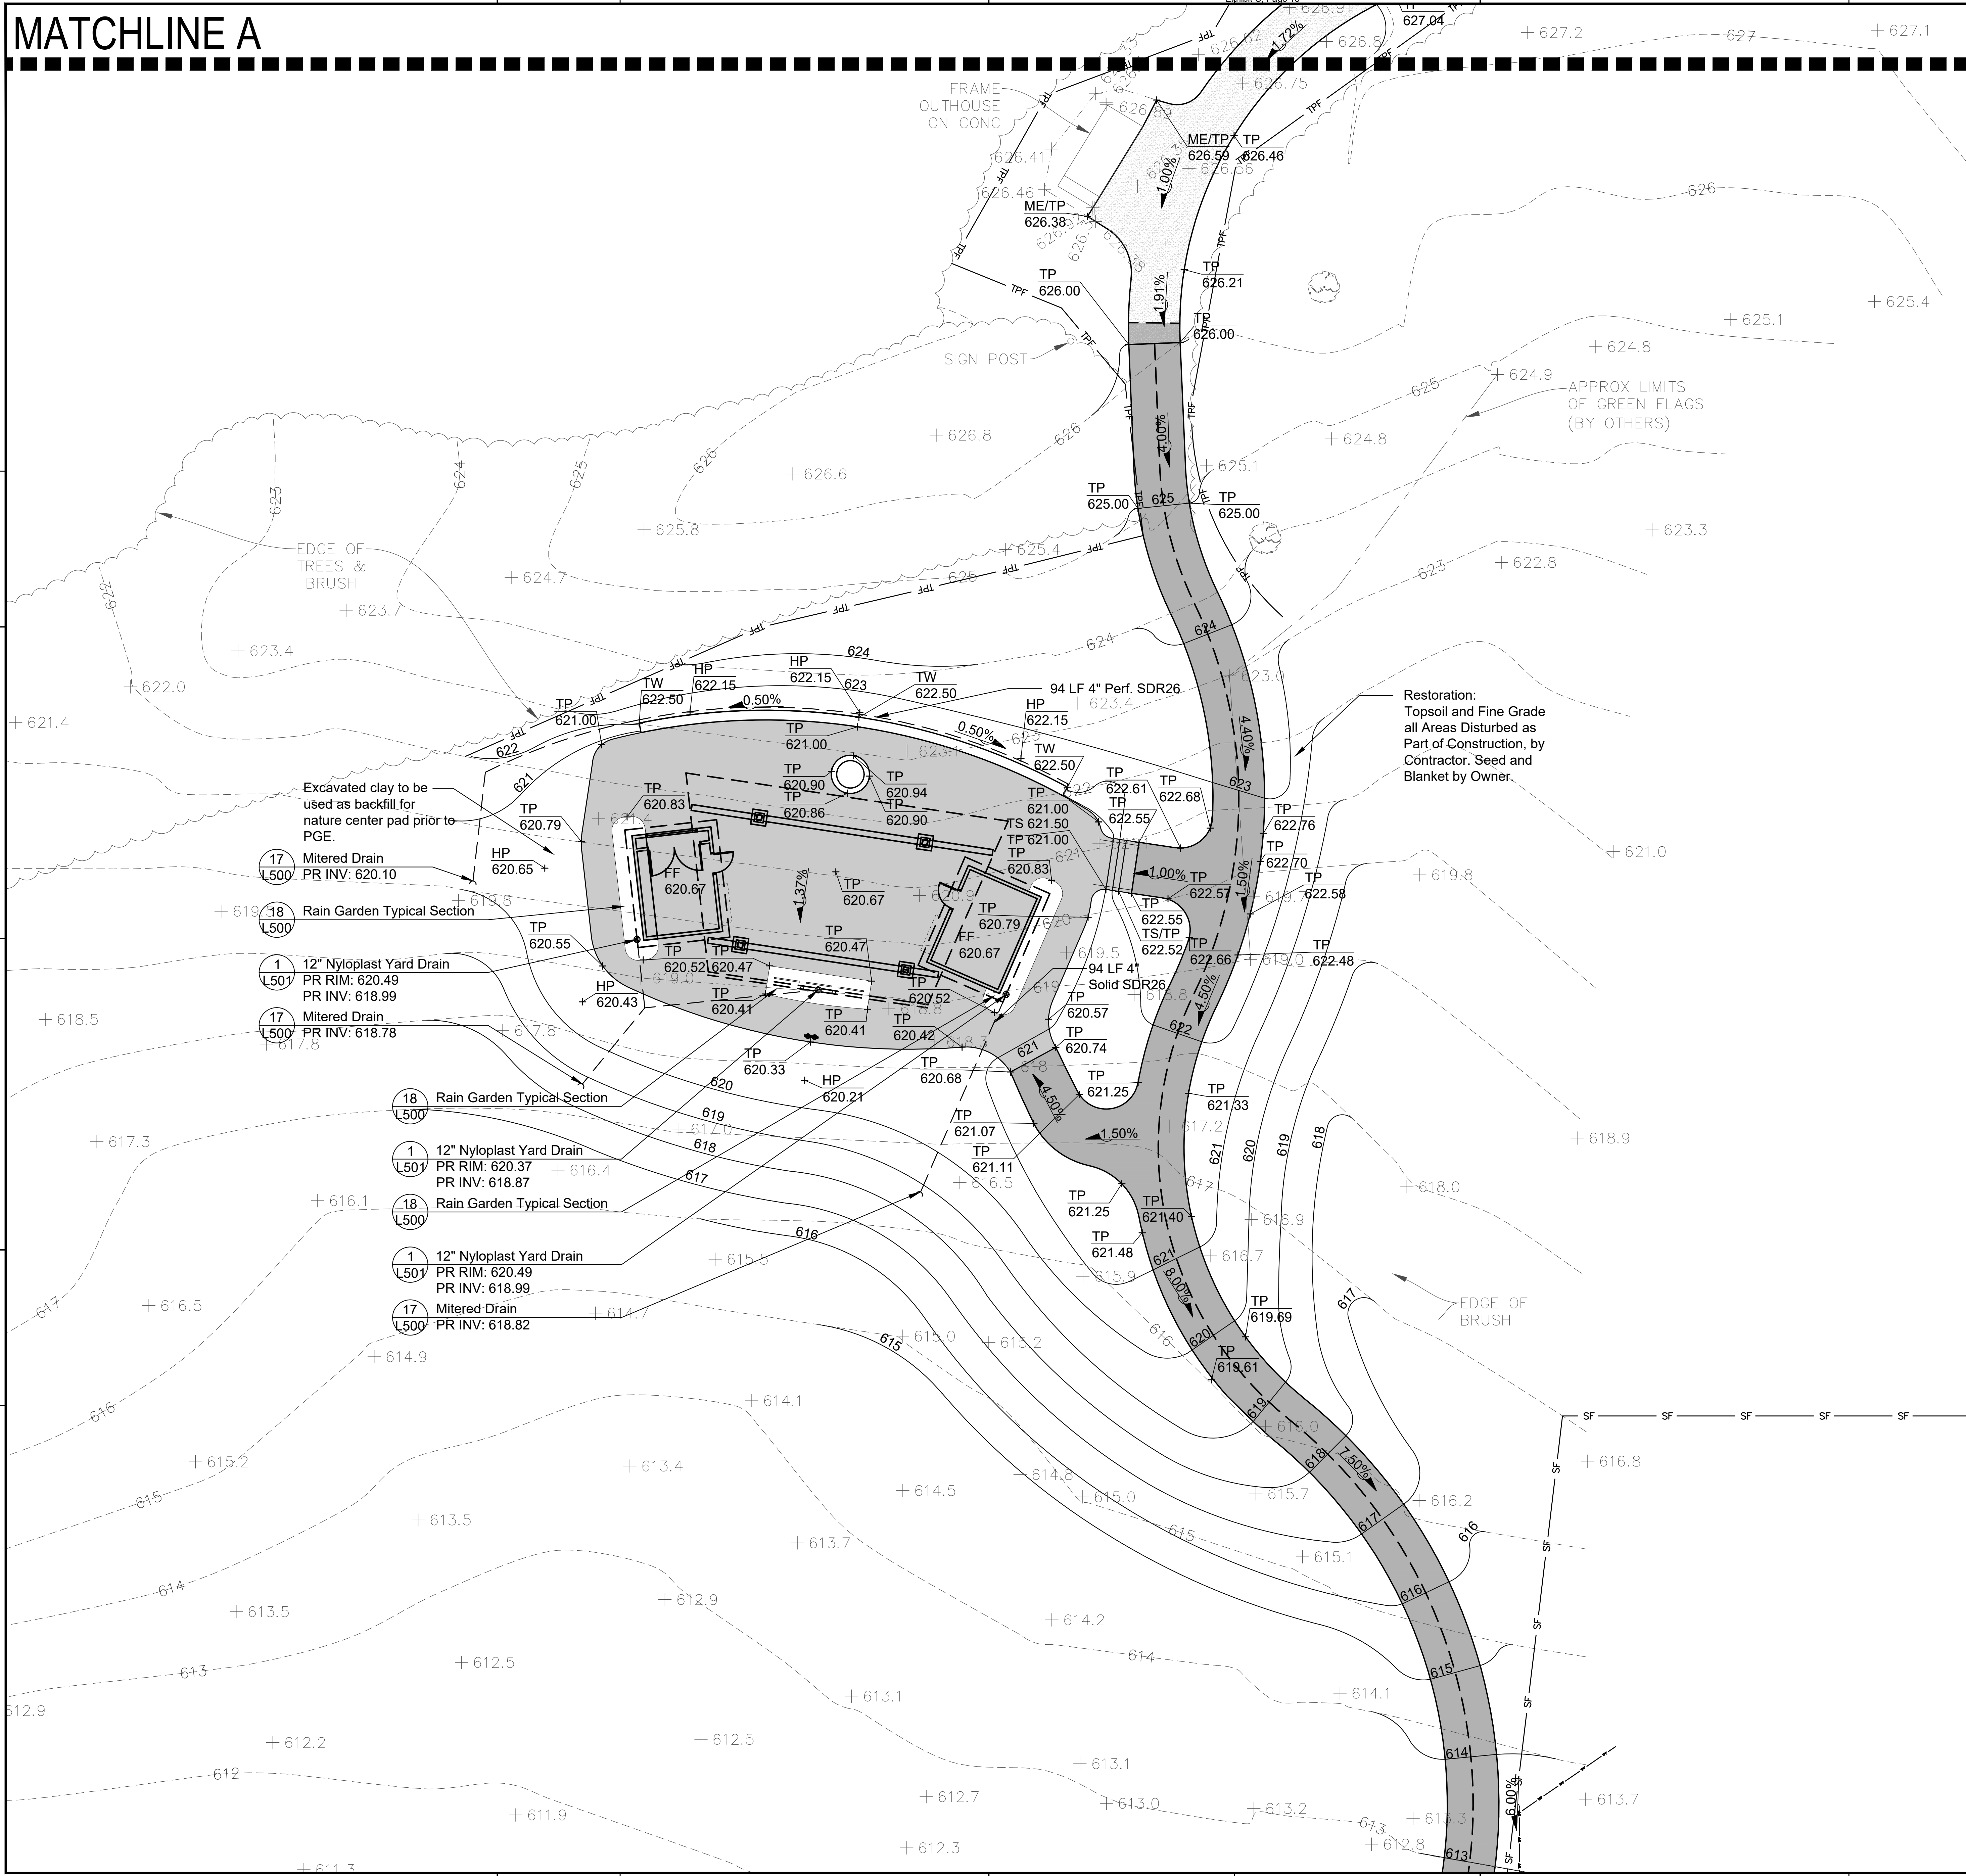
# MATCHLINE A

Exhibit C, Page 13

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## GENERAL NOTES: GRADING

- See Sheet L200 for Grading Notes




### LEGEND

- 681 --- Existing Contour Line
- 681 — Proposed Contour Line
- + 683.35 + Existing Spot Elevation
- + 689.66 + Proposed Spot Elevation
- 2% — Drainage Flow Direction
- CL — Construction Limits / Construction Fence

### INDEX OF ACRONYMS AND ABBREVIATIONS

- HP - High Point
- INV - Pipe Invert Elevation
- LP - Low Point
- ME - Match Existing Elevation
- RIM - Top of Rim Elevation
- TC - Top of Curb
- TP - Top of Pavement
- TW - Top of Wall

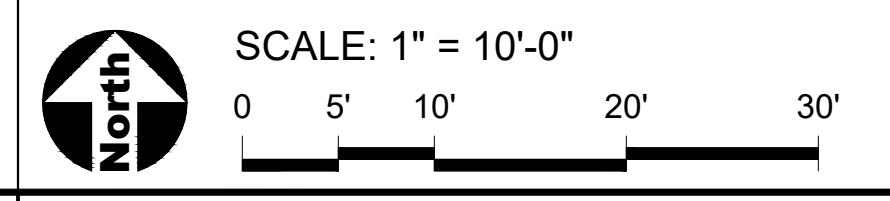

NOTE: SCALES DEPICTED ON THIS DRAWING ARE NOT CORRECT UNLESS PLOTTED SHEET SIZE IS 30 X 42 INCHES.

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SHEET TITLE  
**GRADING PLAN - NATURE CENTER ENLARGEMENT**

SHEET NUMBER  
**L402**


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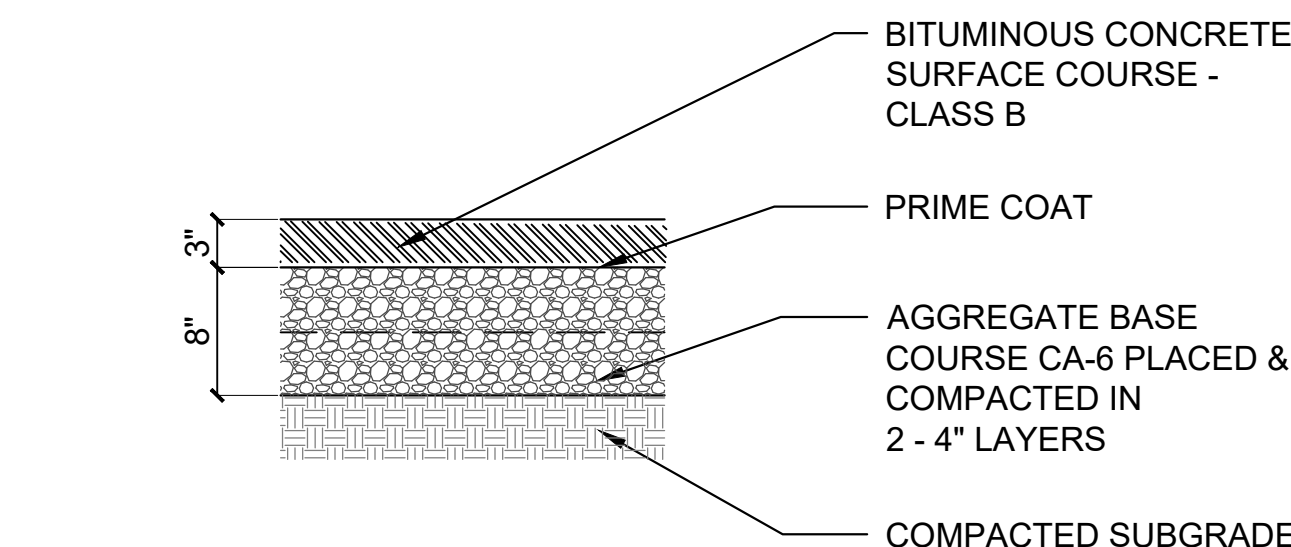
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SHEET NUMBER	
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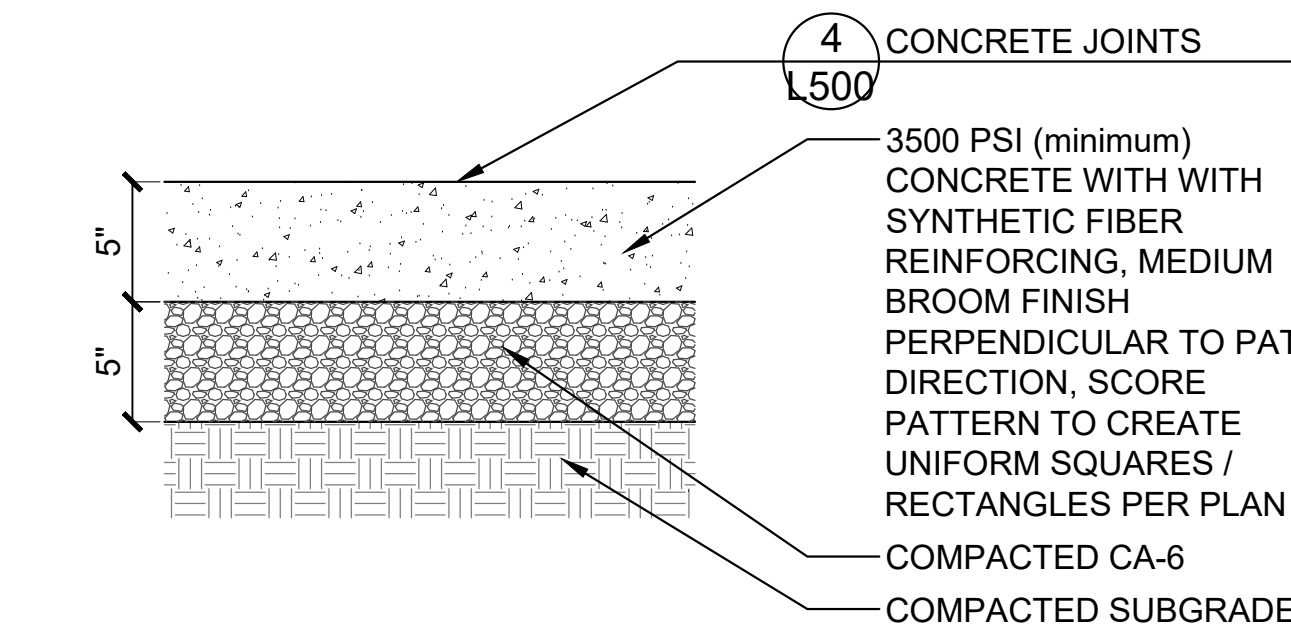
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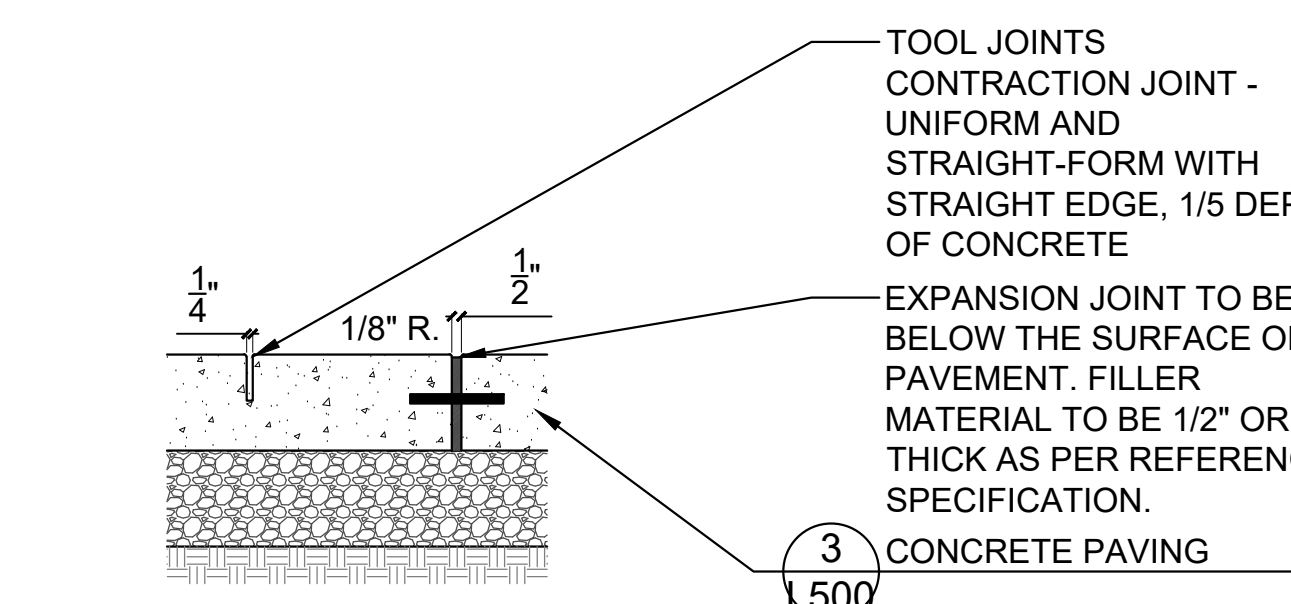
**1 Asphalt Paving - Parking**  
SCALE: 1"=1'-0"  
detail drawing sorted.dwg




**2 Asphalt Paving - Trail**  
SCALE: 1"=1'-0"  
d-asph\_trail\_12.dwg




**3 Concrete Paving**  
SCALE: 1 1/2"=1'-0"  
d-conc pav\_5\_8

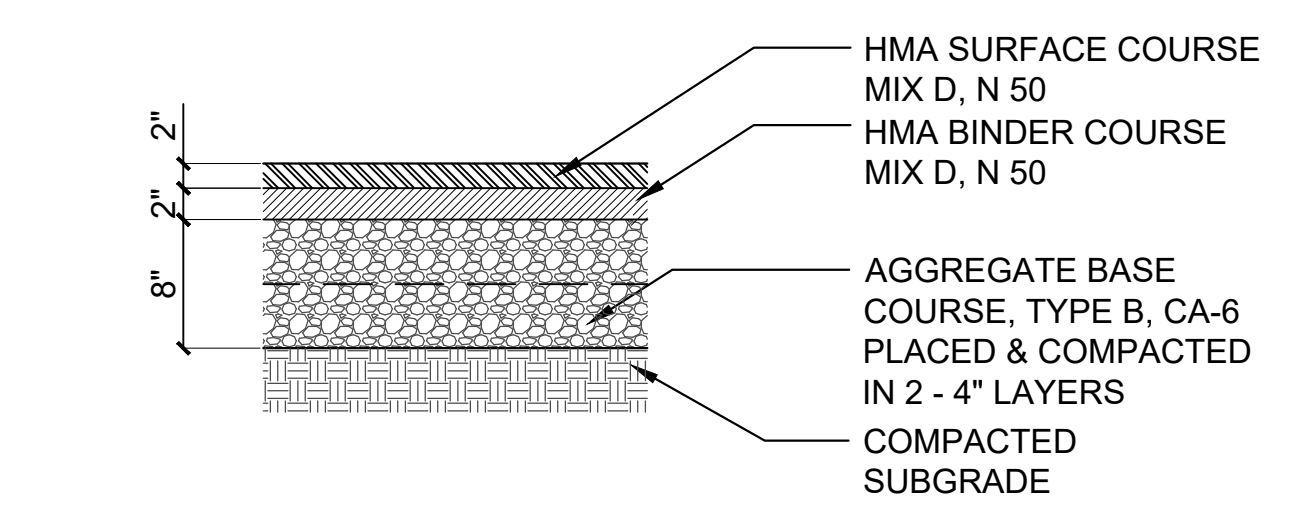


**4 Concrete Joints**  
SCALE: 1 1/2"=1'-0"  
d-conc\_joints\_8.dwg

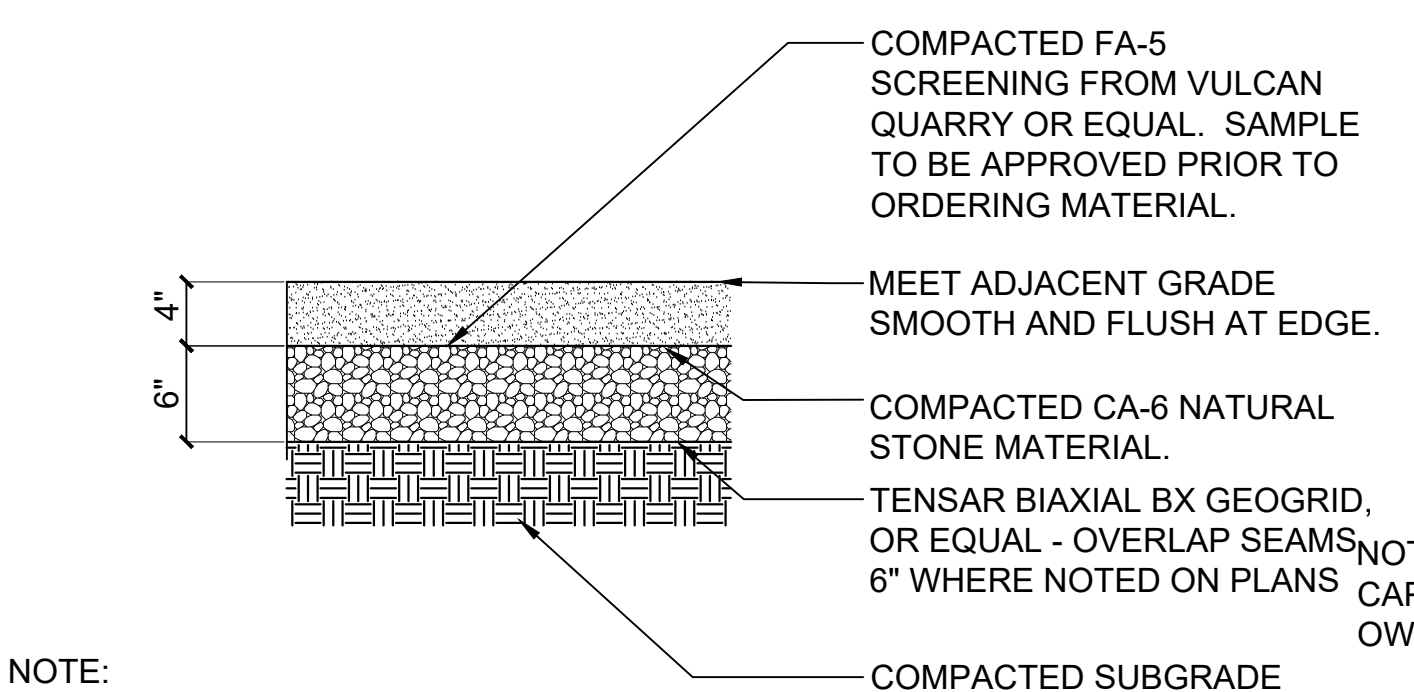


**5 Crushed Limestone Trail**  
SCALE: 1"=1'-0"  
Limestone-FA5 A

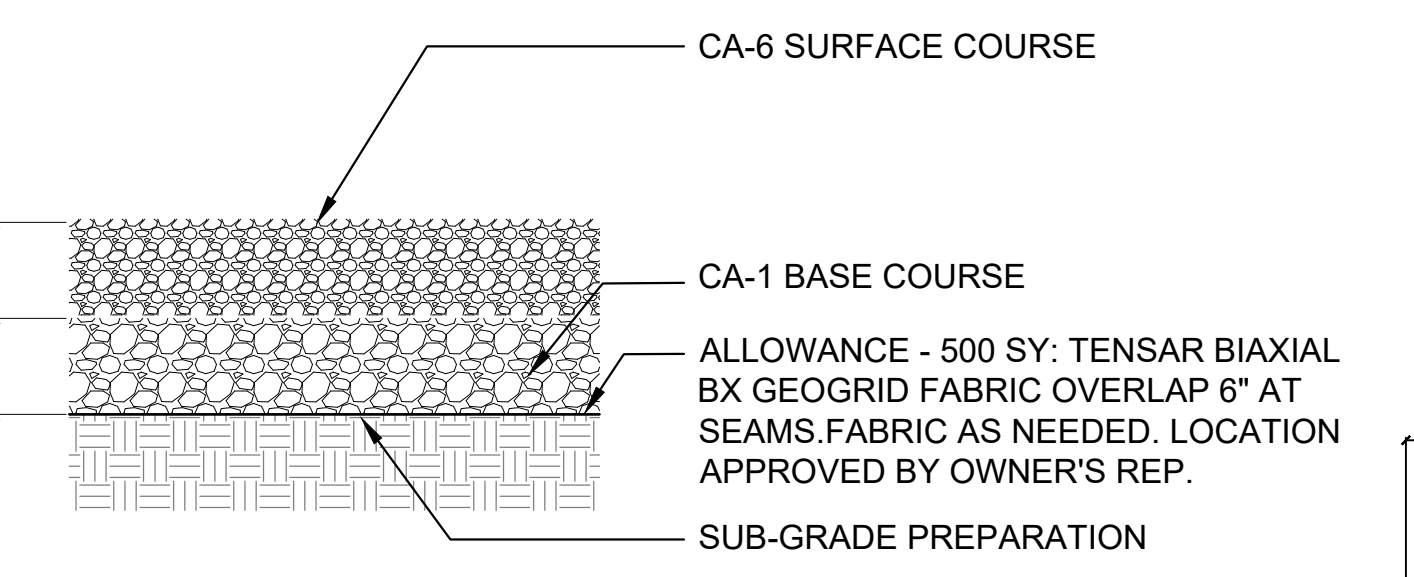


**6 12" Gravel Parking Lot**  
SCALE: 1"=1'-0"  
12 gravel CA6\_1\_12

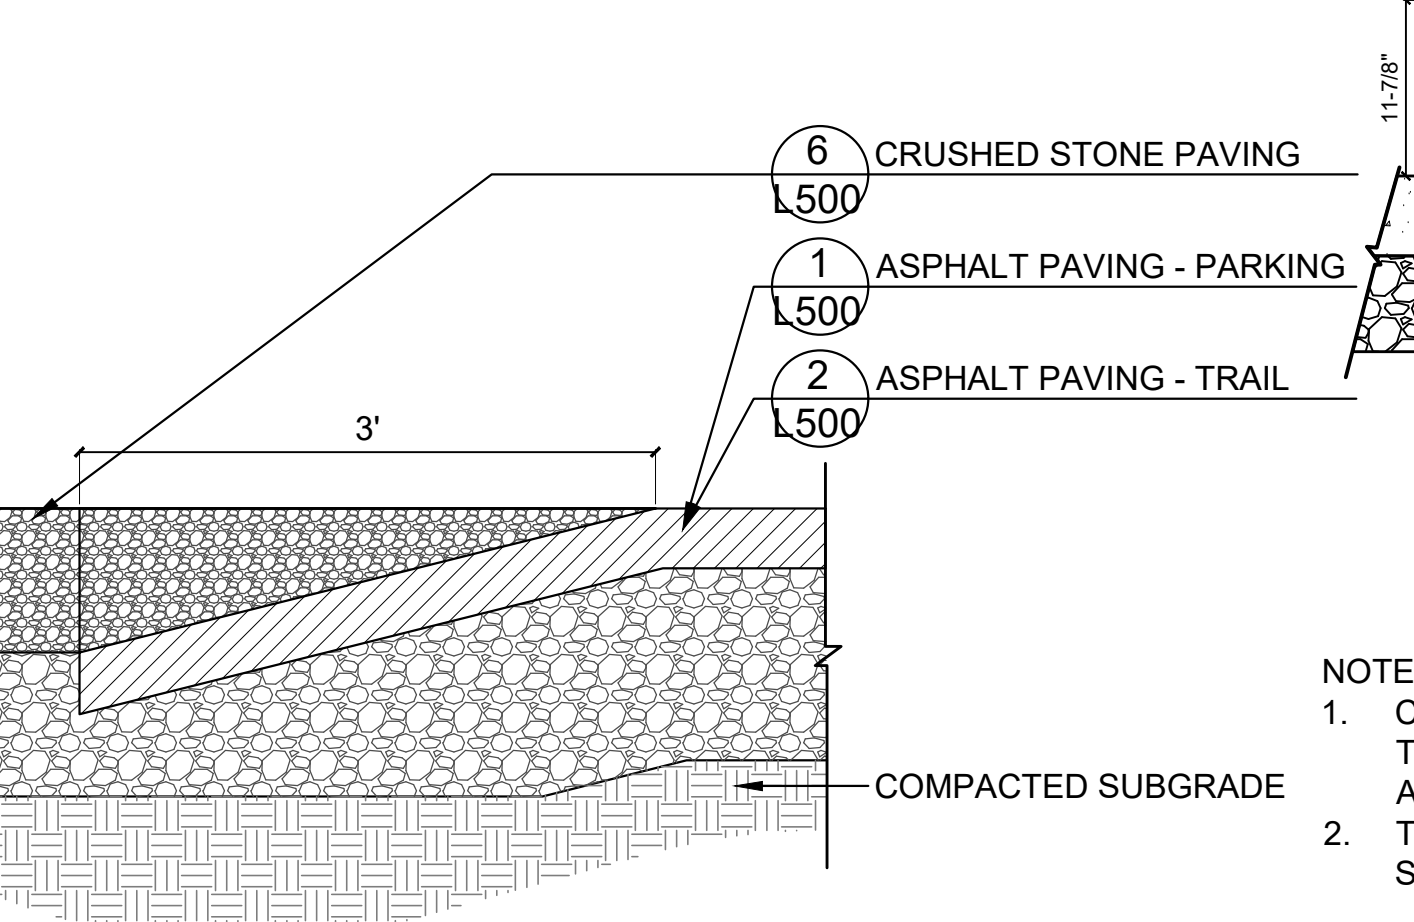


**7 Asphalt to Stone Transition**  
SCALE: 1 1/2"=1'-0"  
d-asph-gravel transition\_8

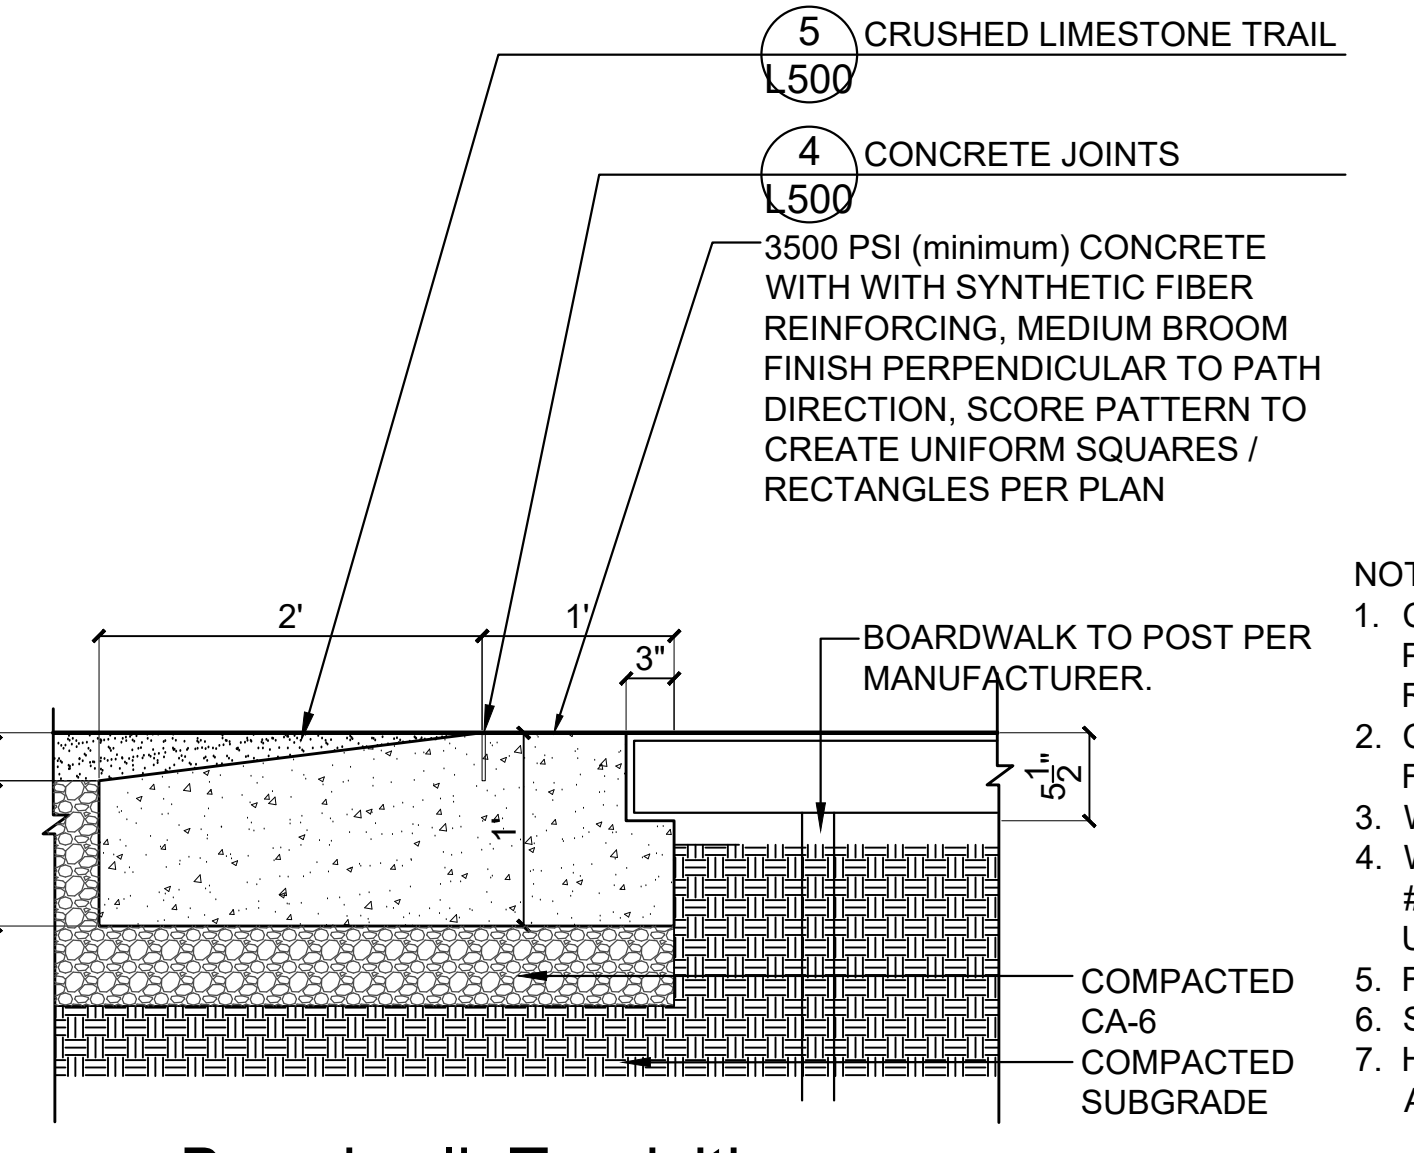


**8 Boardwalk Transition**  
SCALE: Not to Scale  
CRing-FirePit

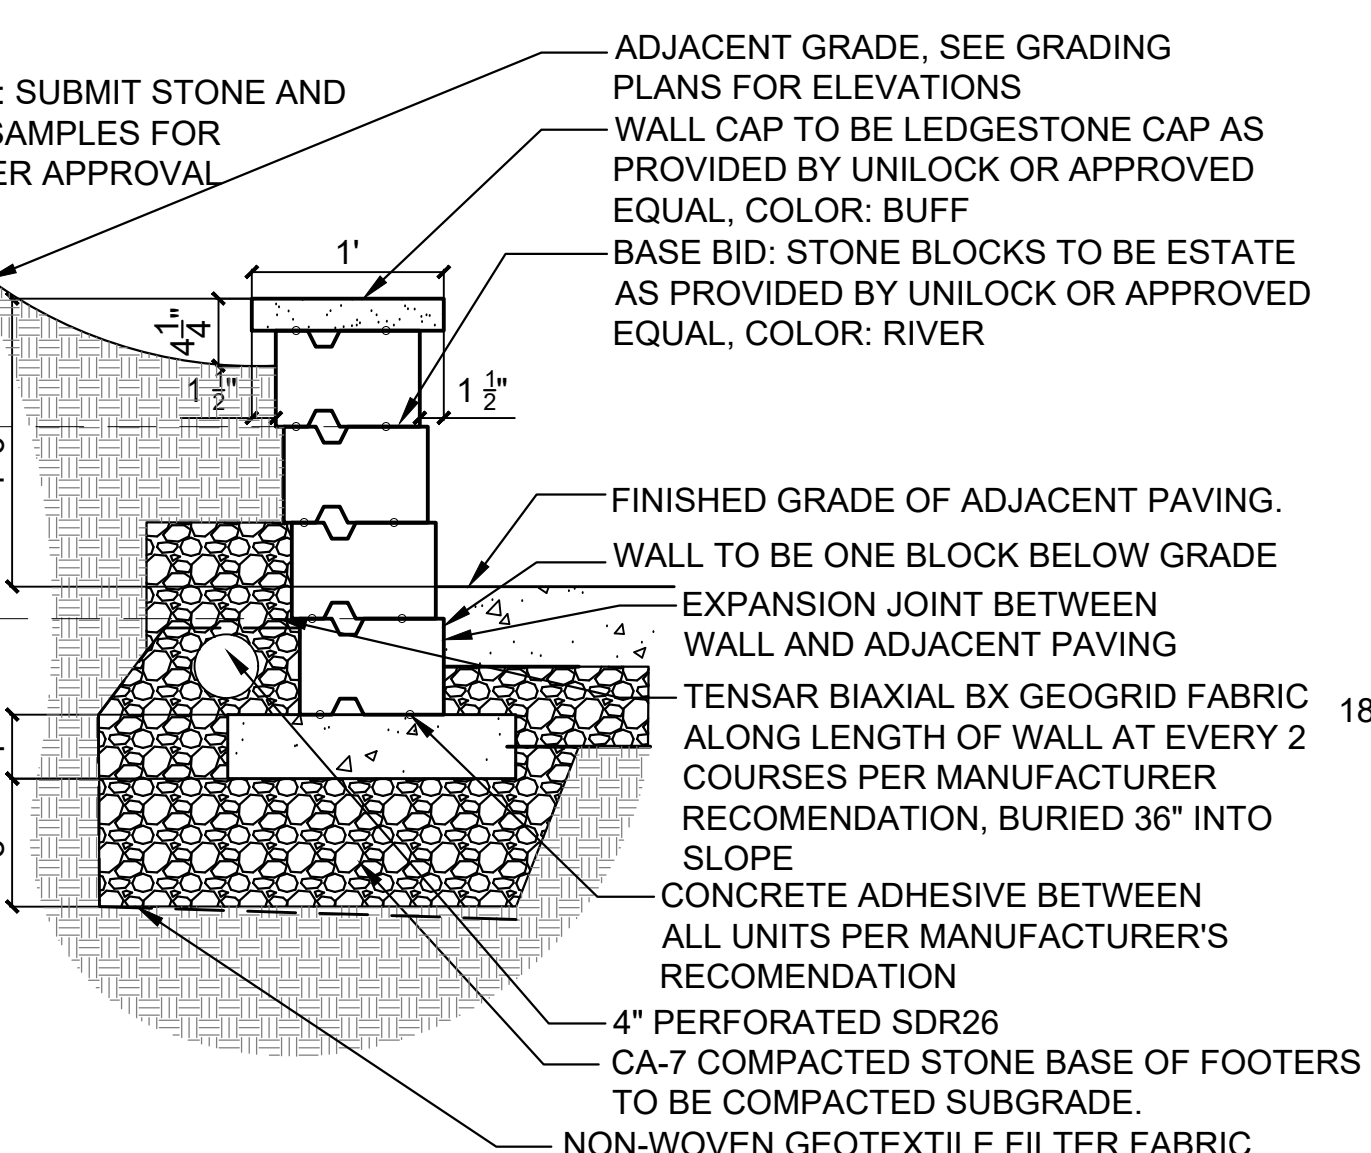


**9 Unit Retaining Wall**  
SCALE: Not to Scale  
d-limestone seat wall-2 sides

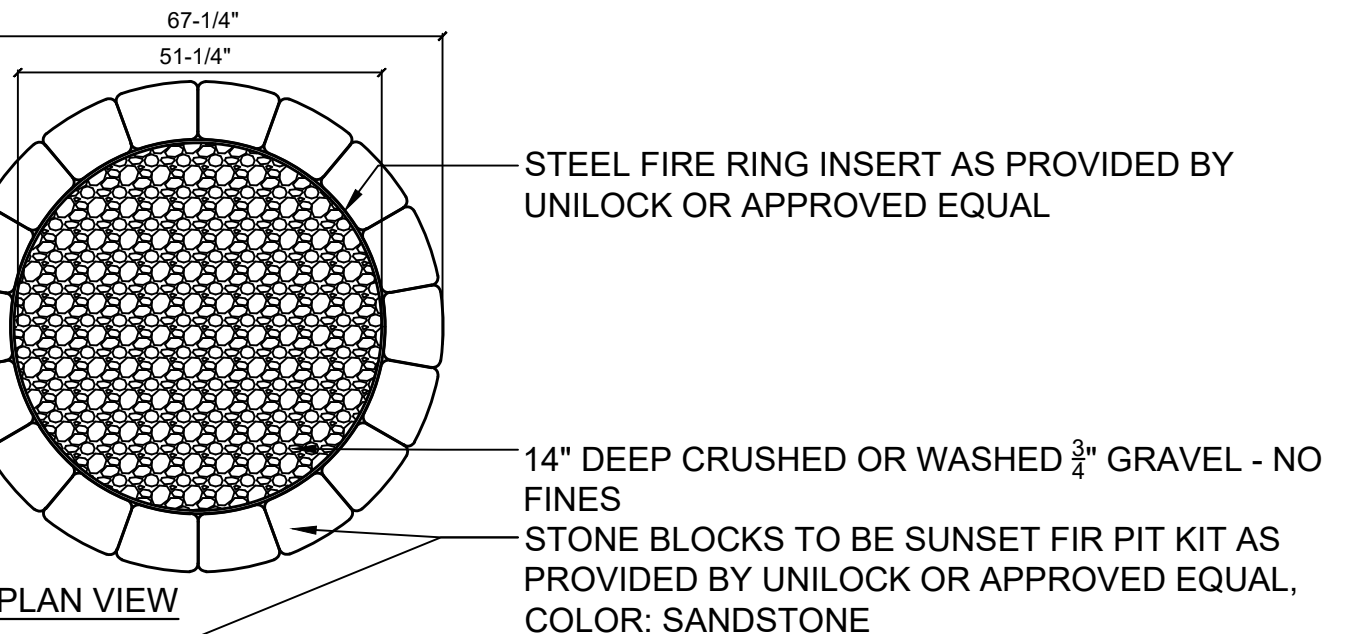


**10 Unit Block Fire Pit**  
SCALE: Not to Scale  
CRing-FirePit

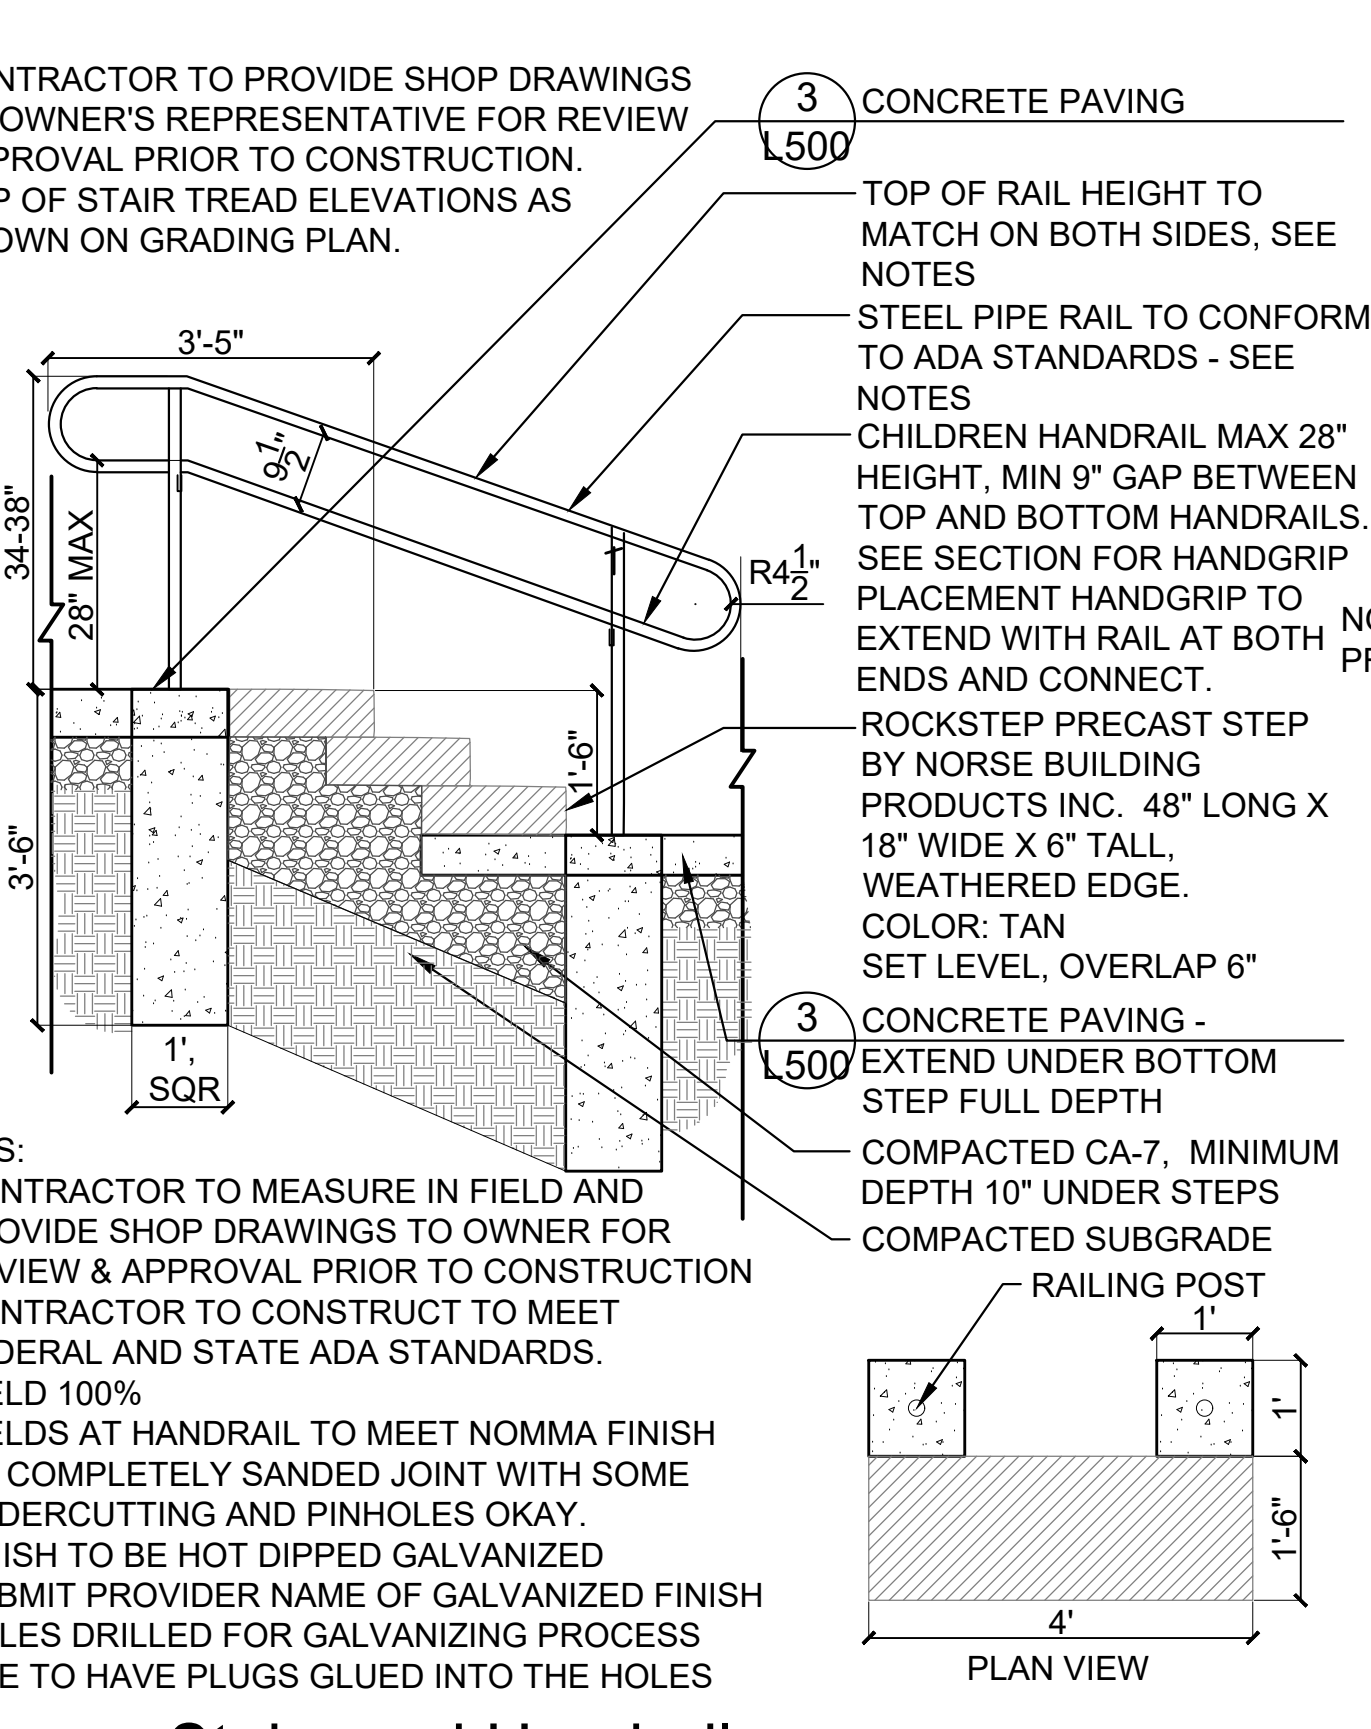


**11 Stairs and Handrail**  
SCALE: 1"=1/2"  
d-stairs\_hillside

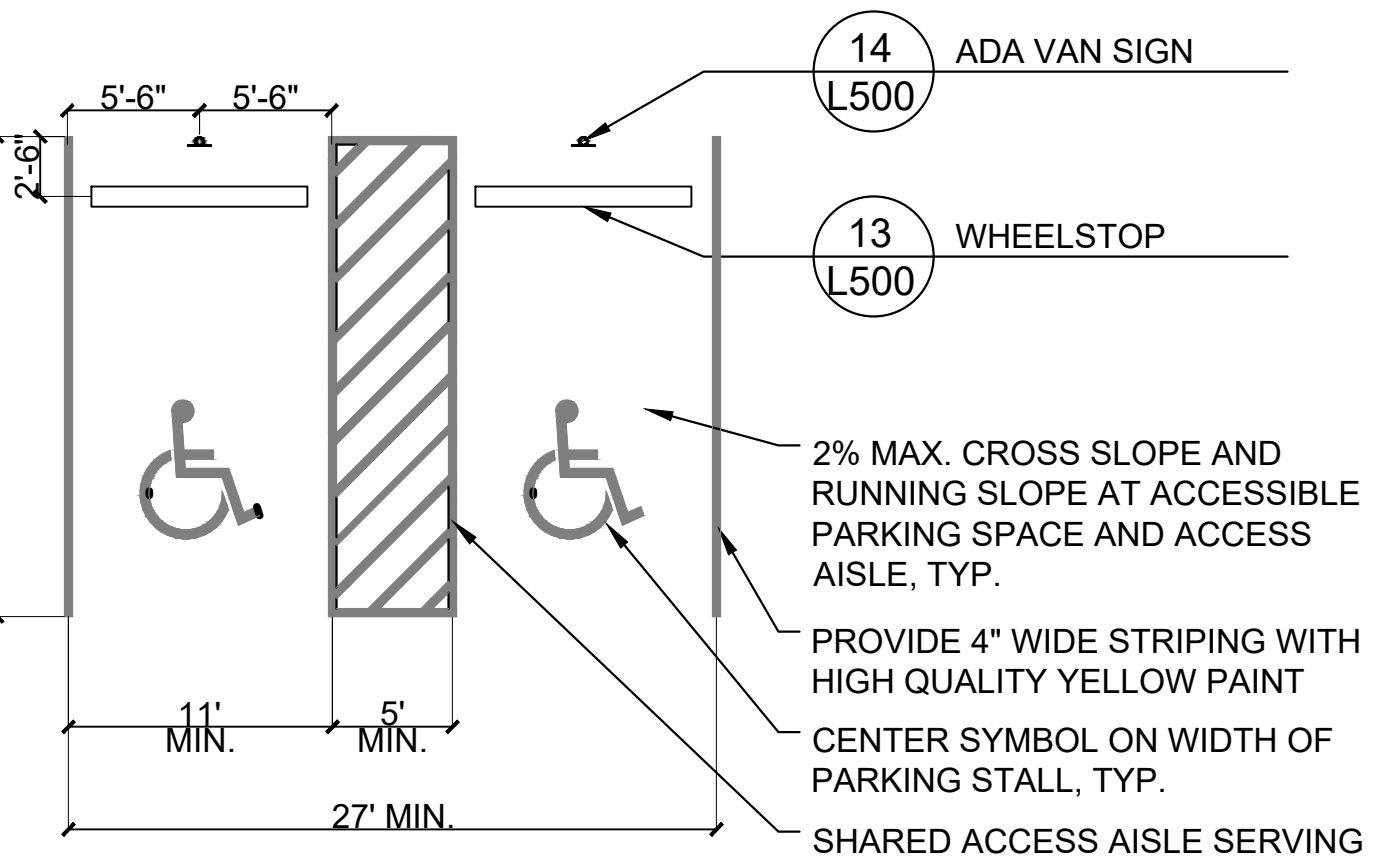


**12 Multiple Access ADA Parking**  
SCALE: 1/8"=1'-0"  
d-ADA Parking\_96

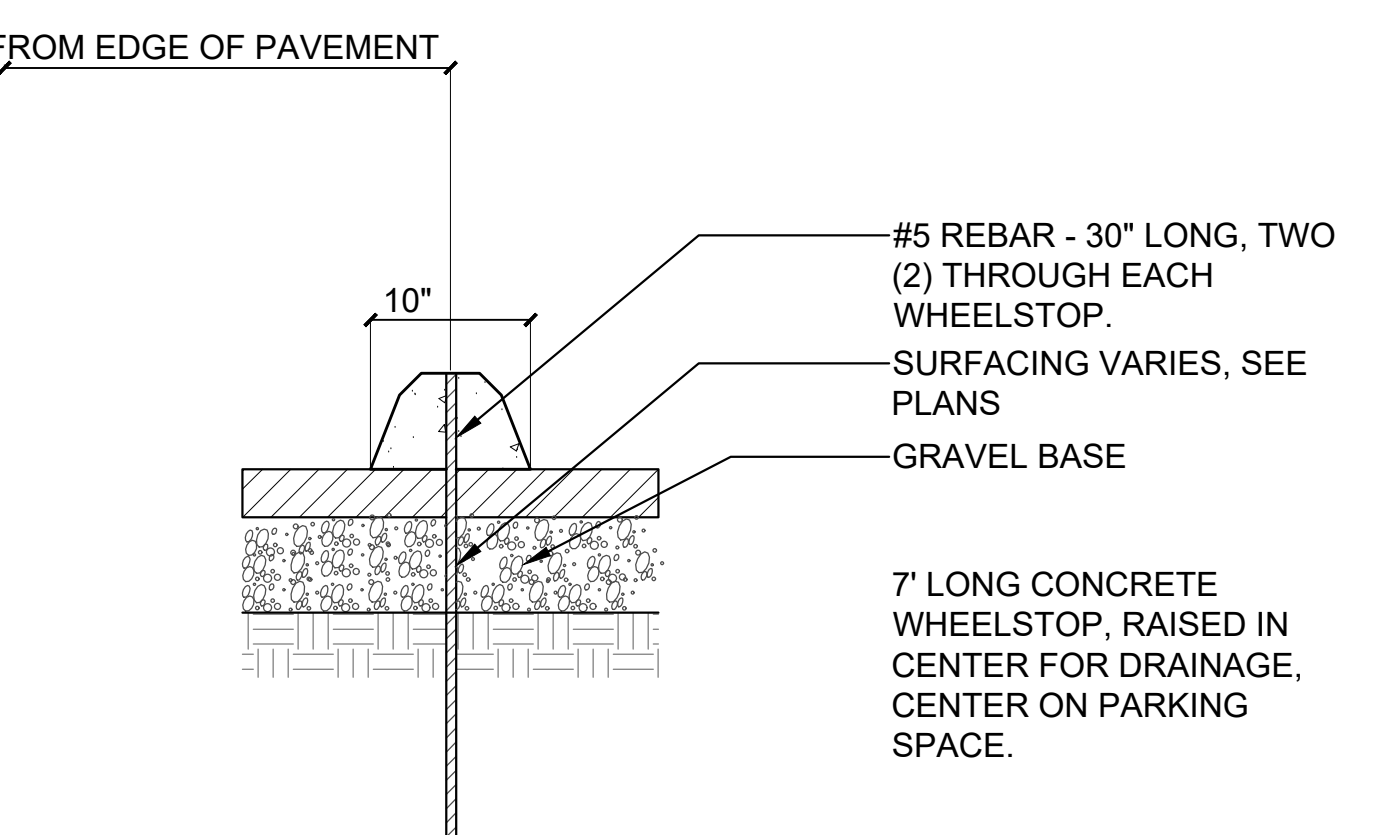


**13 Wheelstop**  
SCALE: 1"=1'-0"  
wheelstop\_1\_12

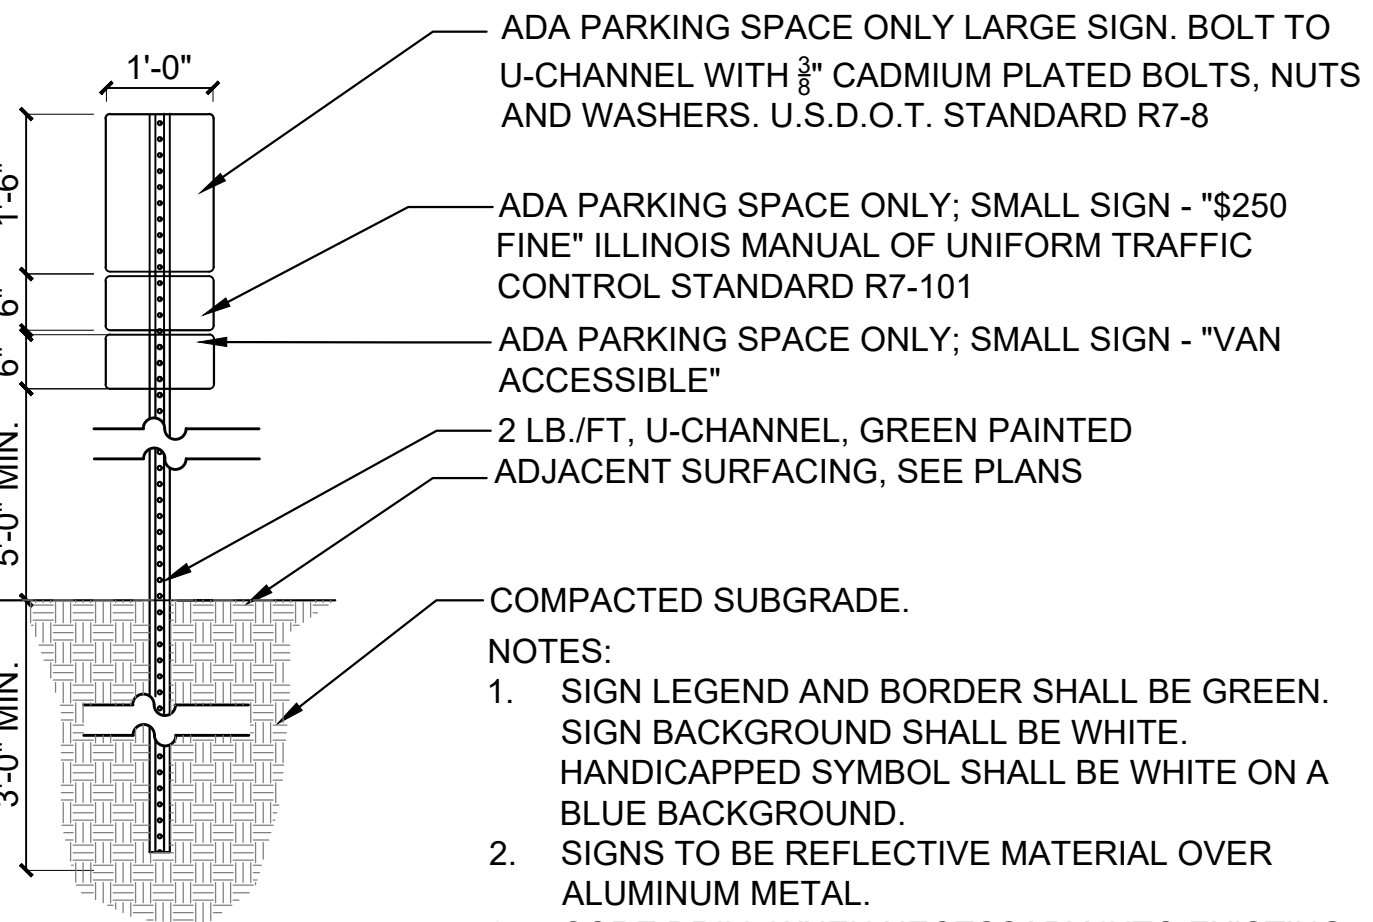


**14 ADA Van Sign**  
SCALE: N.T.S.  
d-sign\_ada\_van\_sign\_12.dwg

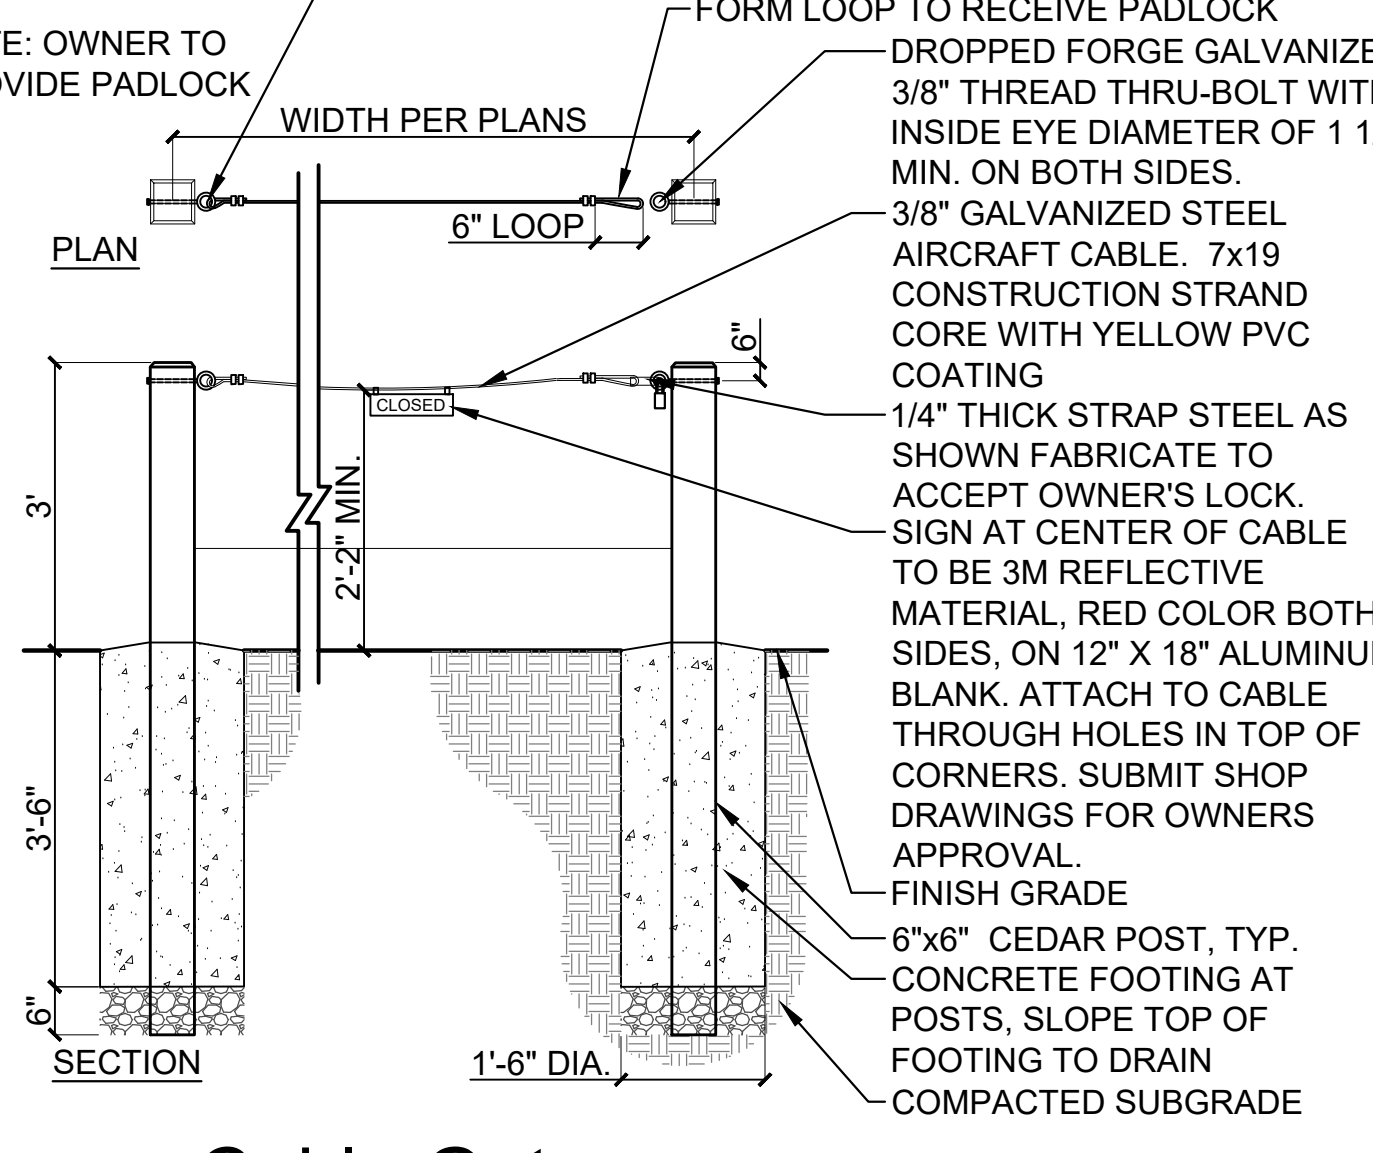


**15 Cable Gate**  
SCALE: 1/2"=1'-0"  
d-cable gate\_24

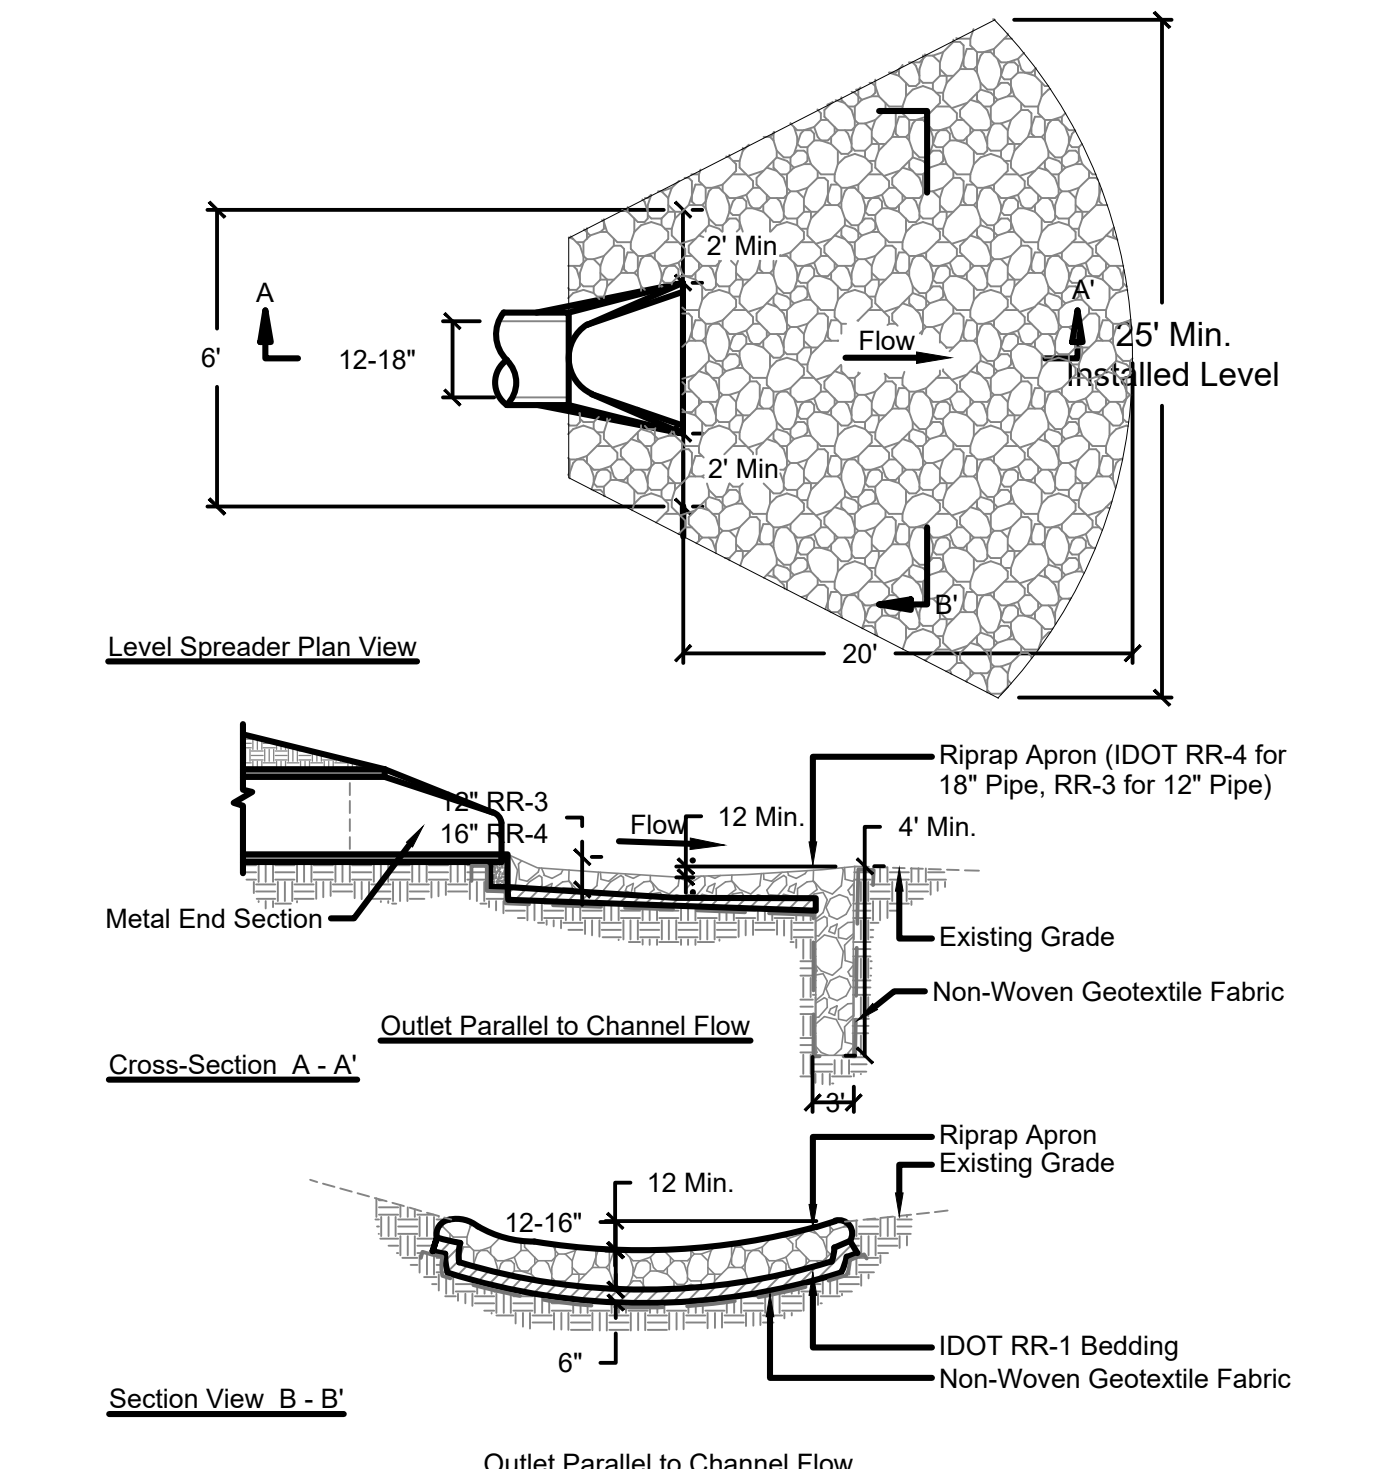


**16 Culvert Outlet Protection**  
(Not to Scale)

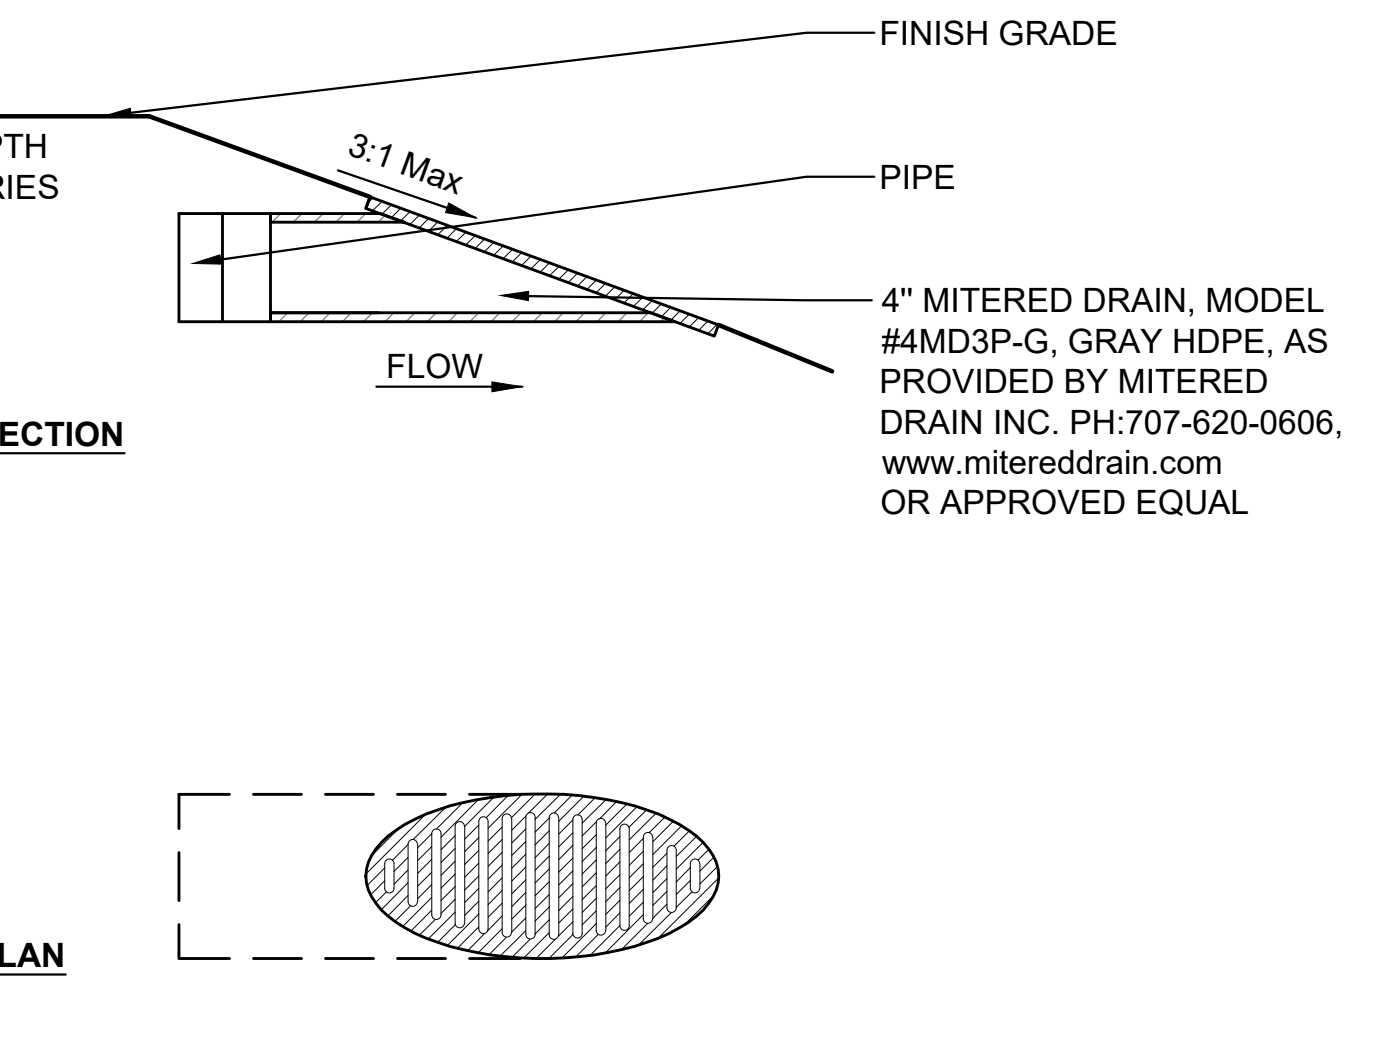


**17 Mitered Drain**  
SCALE: 1 1/2"=1'-0"  
d-mitered drain\_8

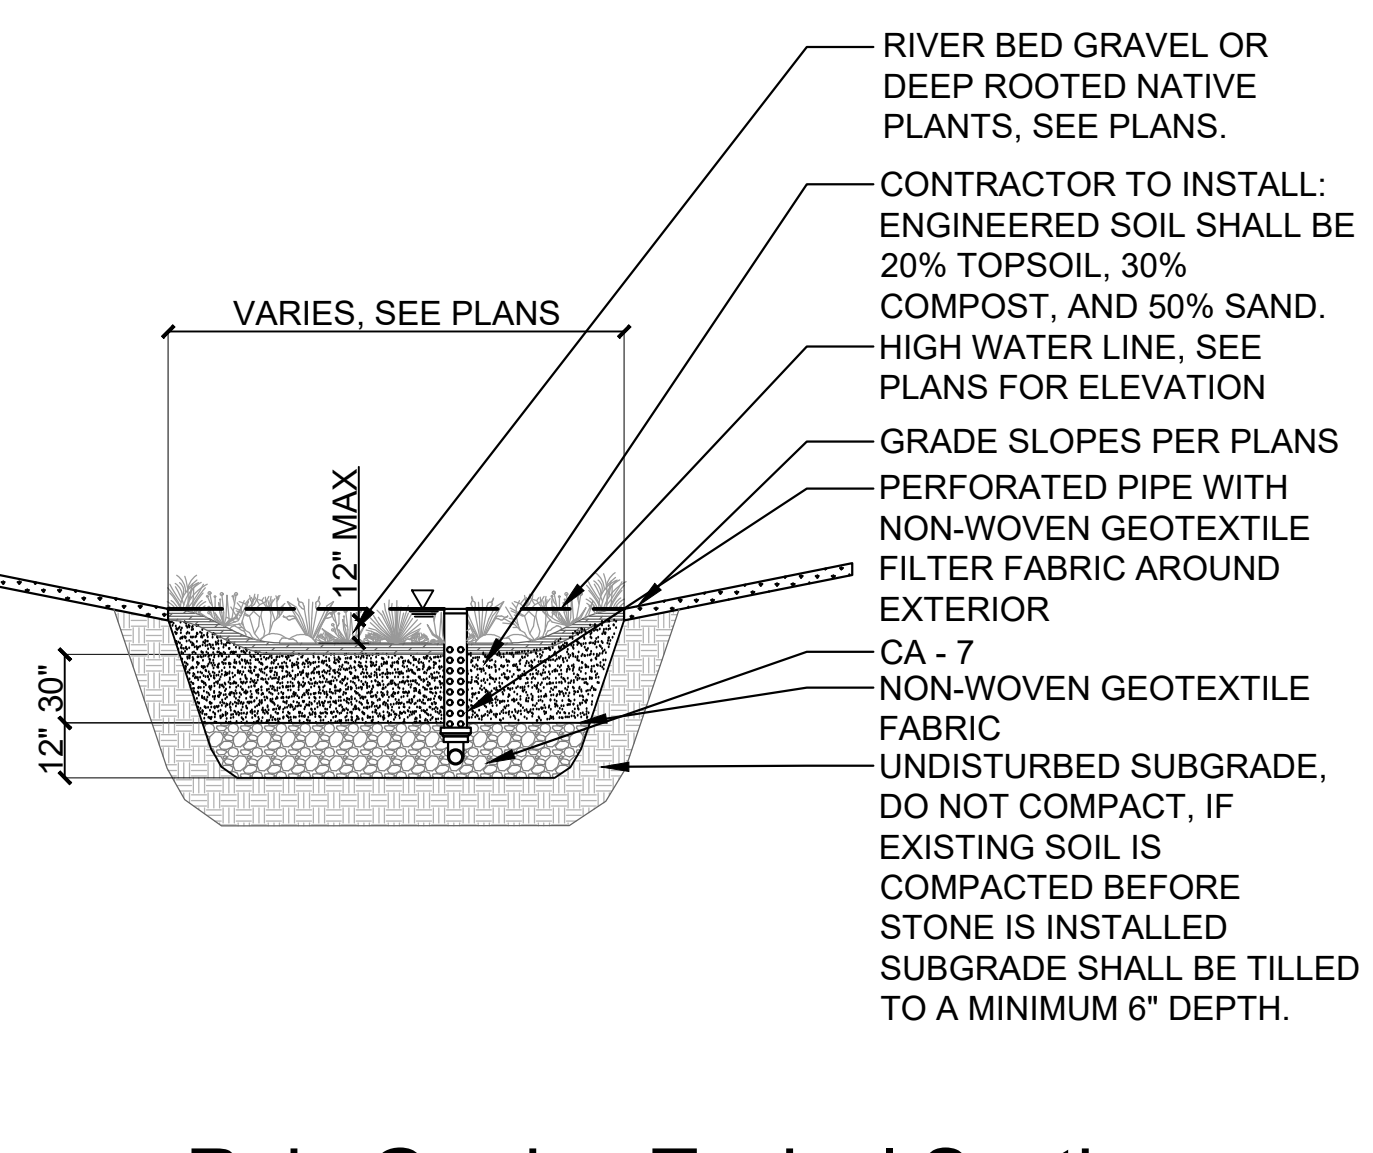


**18 Rain Garden Typical Section**  
SCALE: N.T.S.  
d-plant\_rain garden\_48.dwg

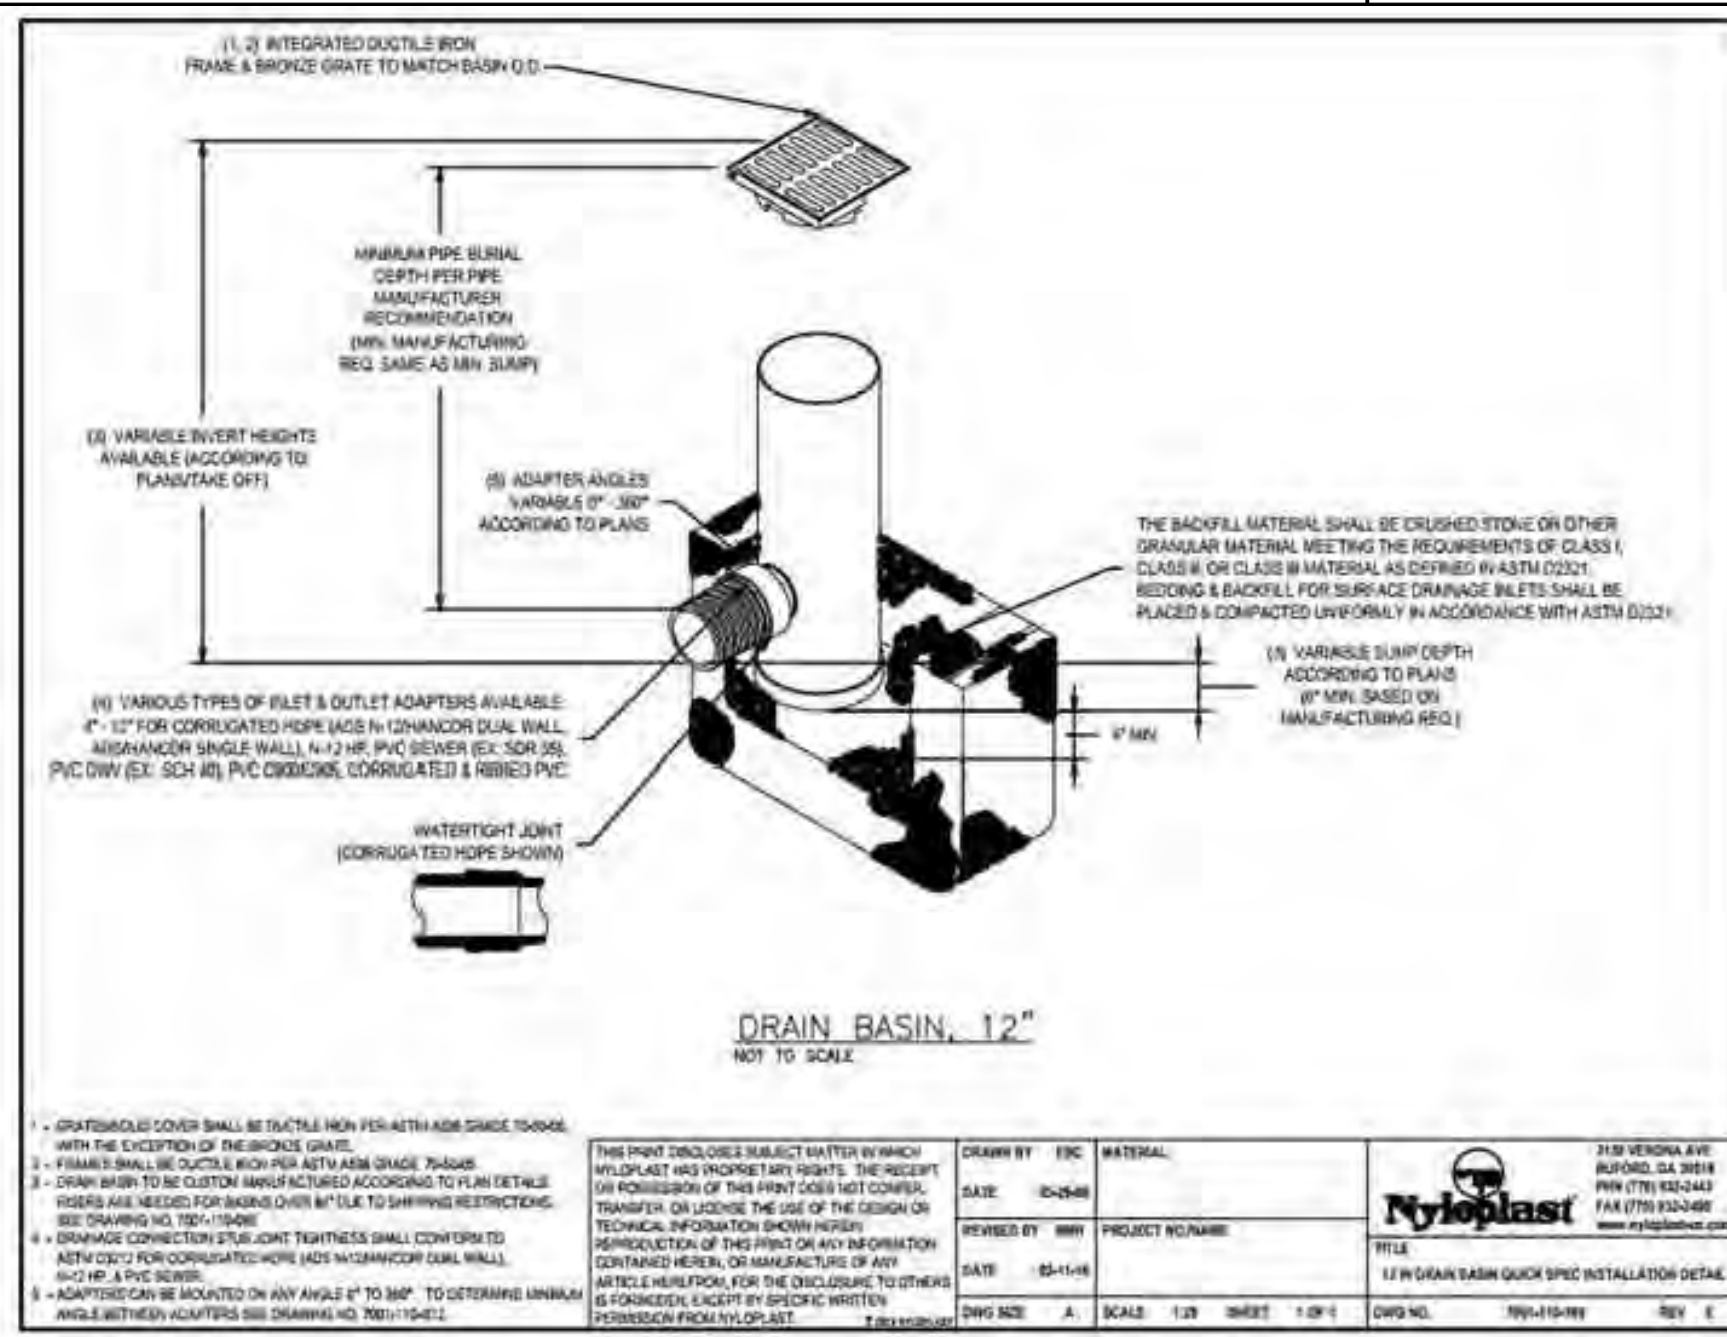

1 12" Nyooplast Yard Drain  
N.T.S.

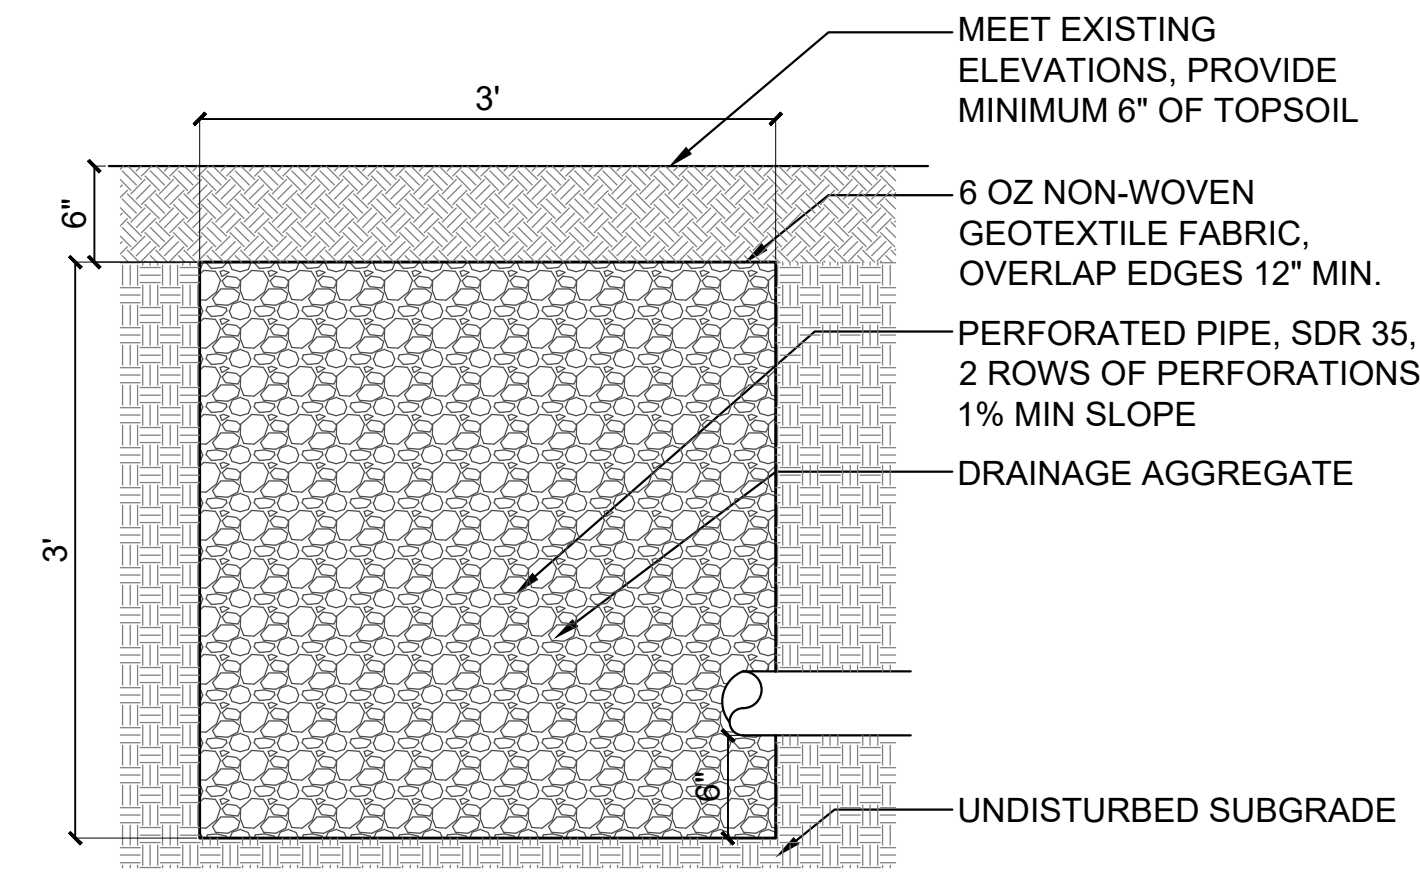

3 French Drain  
SCALE: 1" = 1'-0"  
d-util\_french\_drain\_12.dwg

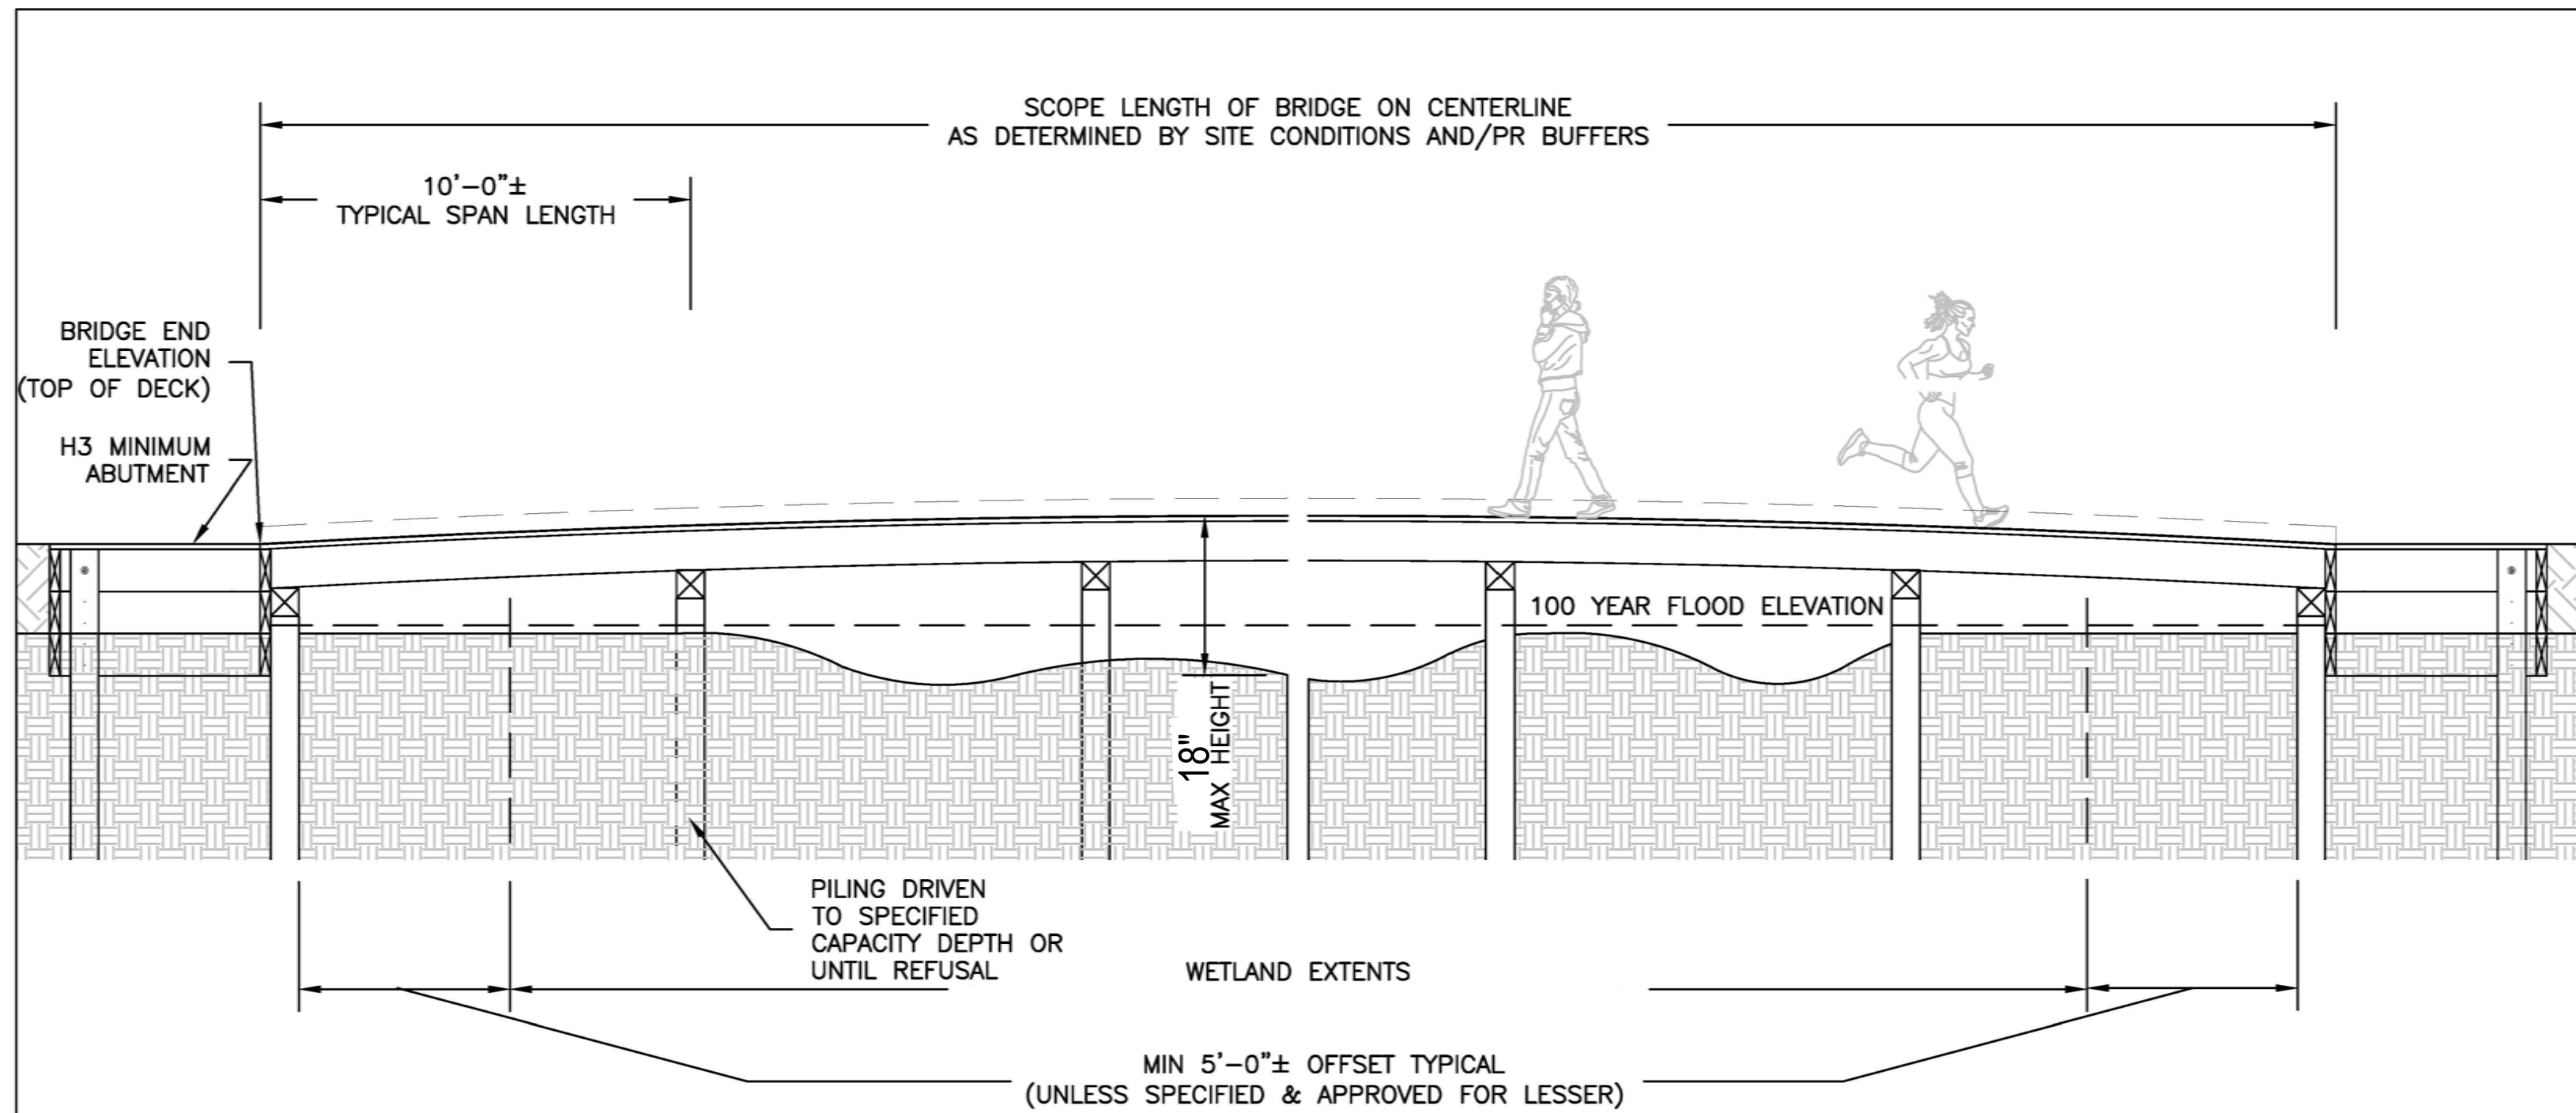

1 ELEVATION VIEW  
SCALE: N.T.S.


GENERAL NOTES

- DRAWING IS CONCEPTUAL IN NATURE AND IS NOT TO BE USED FOR CONSTRUCTION PURPOSES.
- SITE INFORMATION IS GENERIC TO ILLUSTRATE GENERALIZED CONDITIONS.
- LOW CHORD TO BE A MINIMUM OF 12 INCHES CLEAR OF 100 YEAR FLOOD ELEVATION REQUIRED.
- GRADING & RIP RAP DESIGN & INSTALLATION BY CONTRACTOR. STEEPER THAN 2:1 GRADING WITH AT LEAST 6" CLEAR OF THE BOTTOM OF PILE CAP IS PREFERRED.
- MINIMUM OF 5' OFFSET FROM EASEMENTS, FLOW, EXTENTS, ENVIRONMENTAL BUFFERS, OR SIMILAR RECOMMENDED.
- TIMBER PILING INSTALLED TO A DEPTH OF 10' OR UNTIL REFUSAL IS INCLUDED IN THE BASE BID. IF ALTERNATE

METHODS (DRILLING) OR ADDITIONAL DEPTH (PAST 10') ARE NEEDED, TIME AND EXPENSES WILL BE COVERED/ SEE SECTION 1.2 OF BRIDGE SPECIFICATIONS.

7. BRIDGE SLOPE NOT TO EXCEED 4.5% FOR A CONTINUOUS PATH OR 7.5% IN AN ADA RAMP & LANDING CONFIGURATION

2 Boardwalk  
SCALE: 1" = 1'-0"

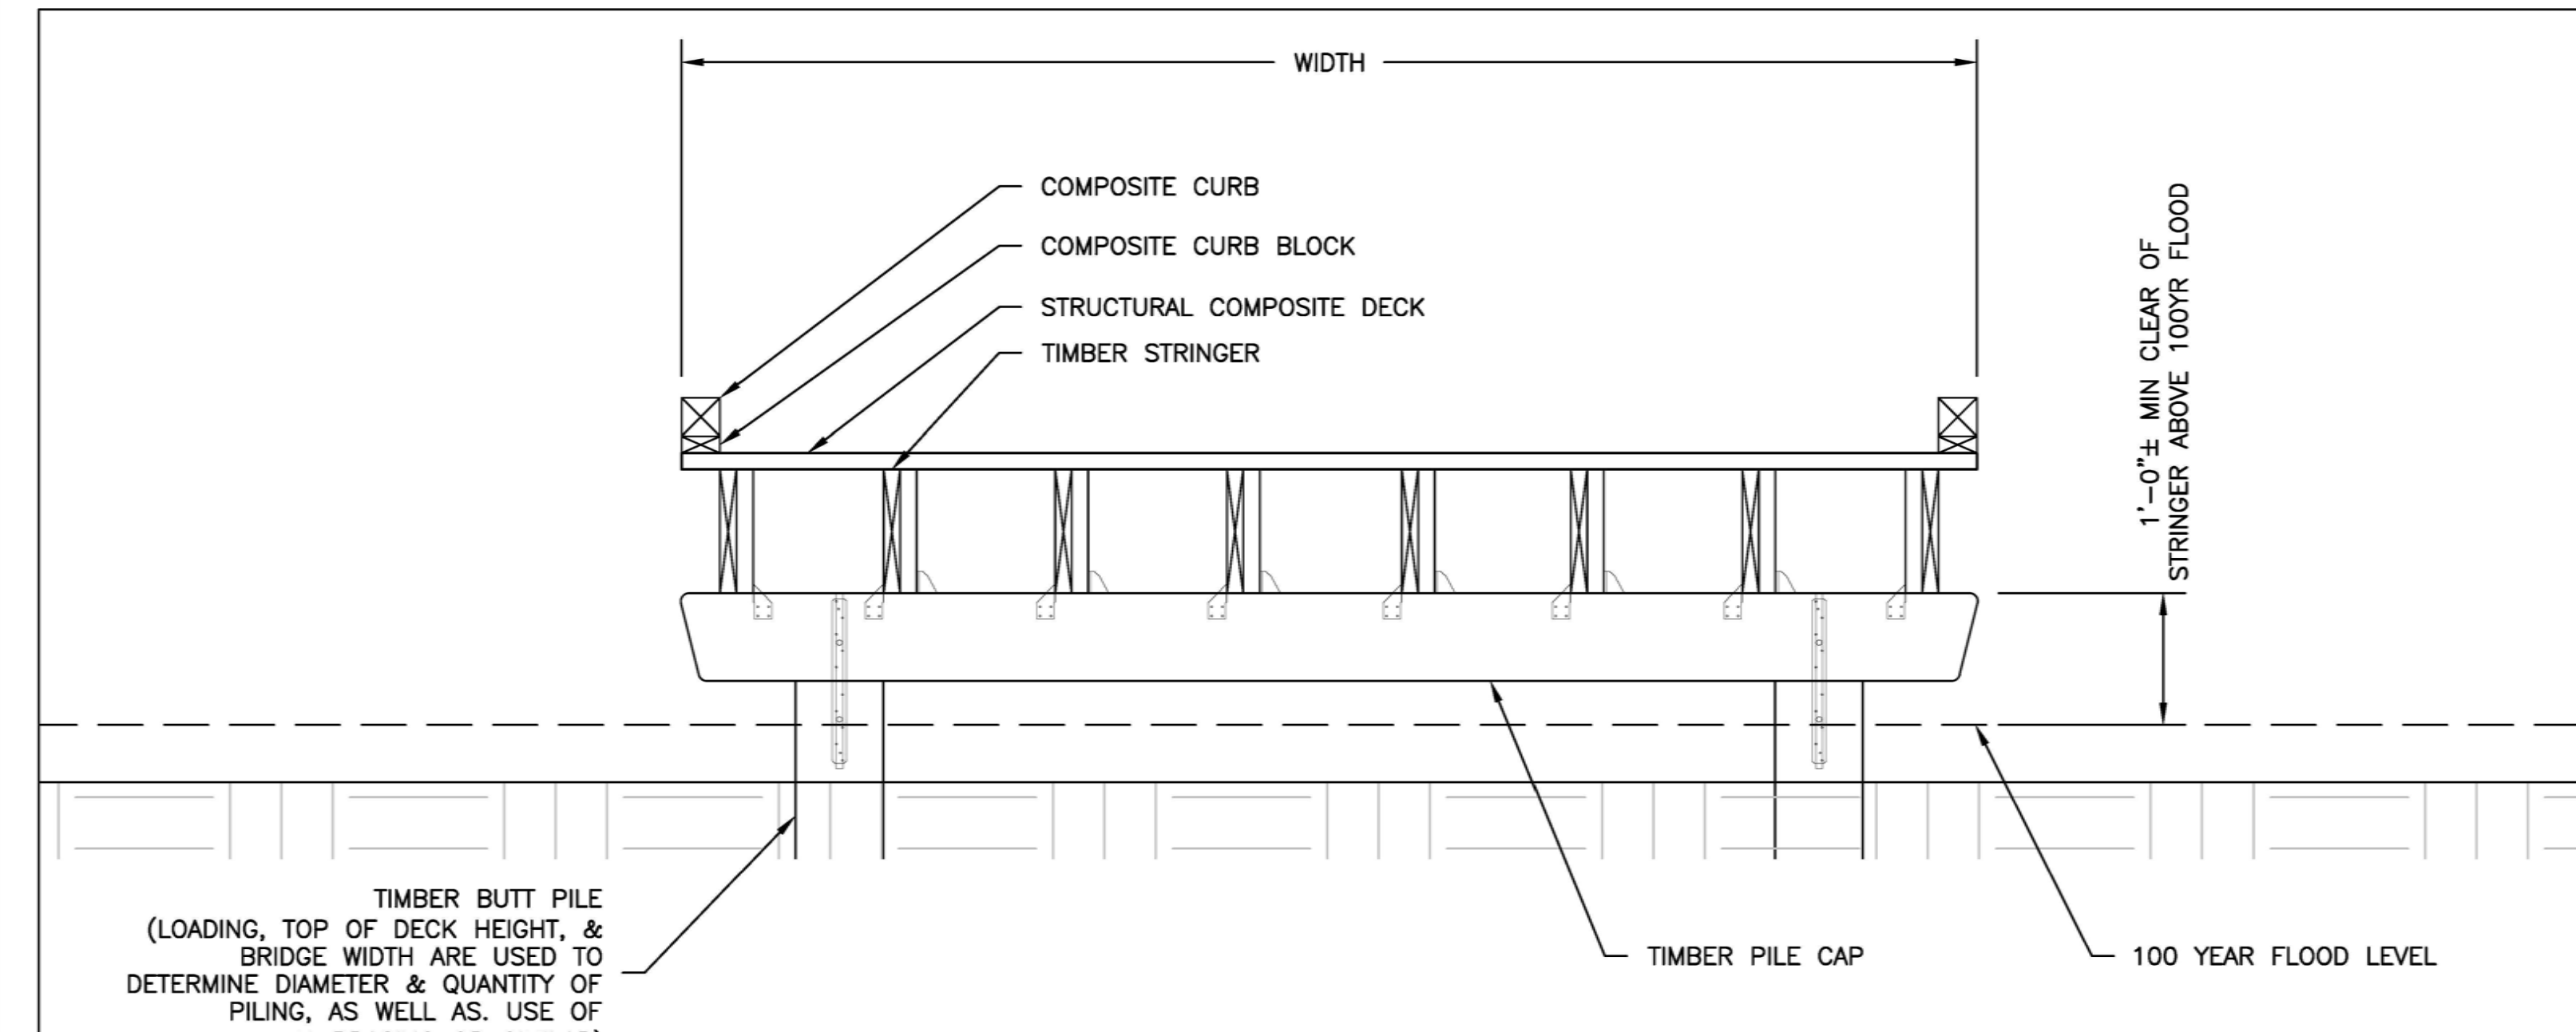

GENERAL NOTES

- DRAWING IS CONCEPTUAL IN NATURE AND IS NOT TO BE USED FOR CONSTRUCTION PURPOSES.
- SITE INFORMATION IS GENERIC TO ILLUSTRATE GENERALIZED CONDITIONS.
- TIMBER PILING INSTALLED TO A DEPTH OF 10' OR UNTIL REFUSAL IS INCLUDED IN THE BASE BID. IF ALTERNATE METHODS (DRILLING) OR ADDITIONAL DEPTH (PAST 10') ARE NEEDED, TIME AND EXPENSES WILL BE COVERED/ SEE SECTION 1.2 OF BRIDGE SPECIFICATIONS.
- LOW CHORD TO BE A MINIMUM OF 12 INCHES CLEAR OF 100 YEAR FLOOD ELEVATION REQUIRED.

1 SECTION- REPETITIVE BENT  
SCALE: N.T.S.

**YORK BRIDGE CONCEPTS**  
THE PREMIER TIMBER BRIDGE COMPANY  
1400 BRIDLE TRAIL LANE, PL. 1000  
MANNING, NC 28548  
803.226.4178

CLIENT/CONTRACTOR:  
ZEYN UZMAN, PE  
305 CHARLESTON GREENE, MALDEN, MA 02148  
ENGINEER OF RECORD


PROJECT INFORMATION:  
SUBBAT FOREST PRESERVE  
TIMBER PEDESTRIAN BRIDGE  
N/A  
90 PSF OR 2 TON (L/360)  
LUTZ, FLORIDA  
PROJECT NUMBER:  
P24-001A

REV #	DATE	BY

DRAWN BY: V.FALZONE  
DATE: 4/16/2024  
PAGE NAME: REPETITIVE BENT  
SHEET NO: 301

det-detail name

ISSUED	DATE	DESCRIPTION

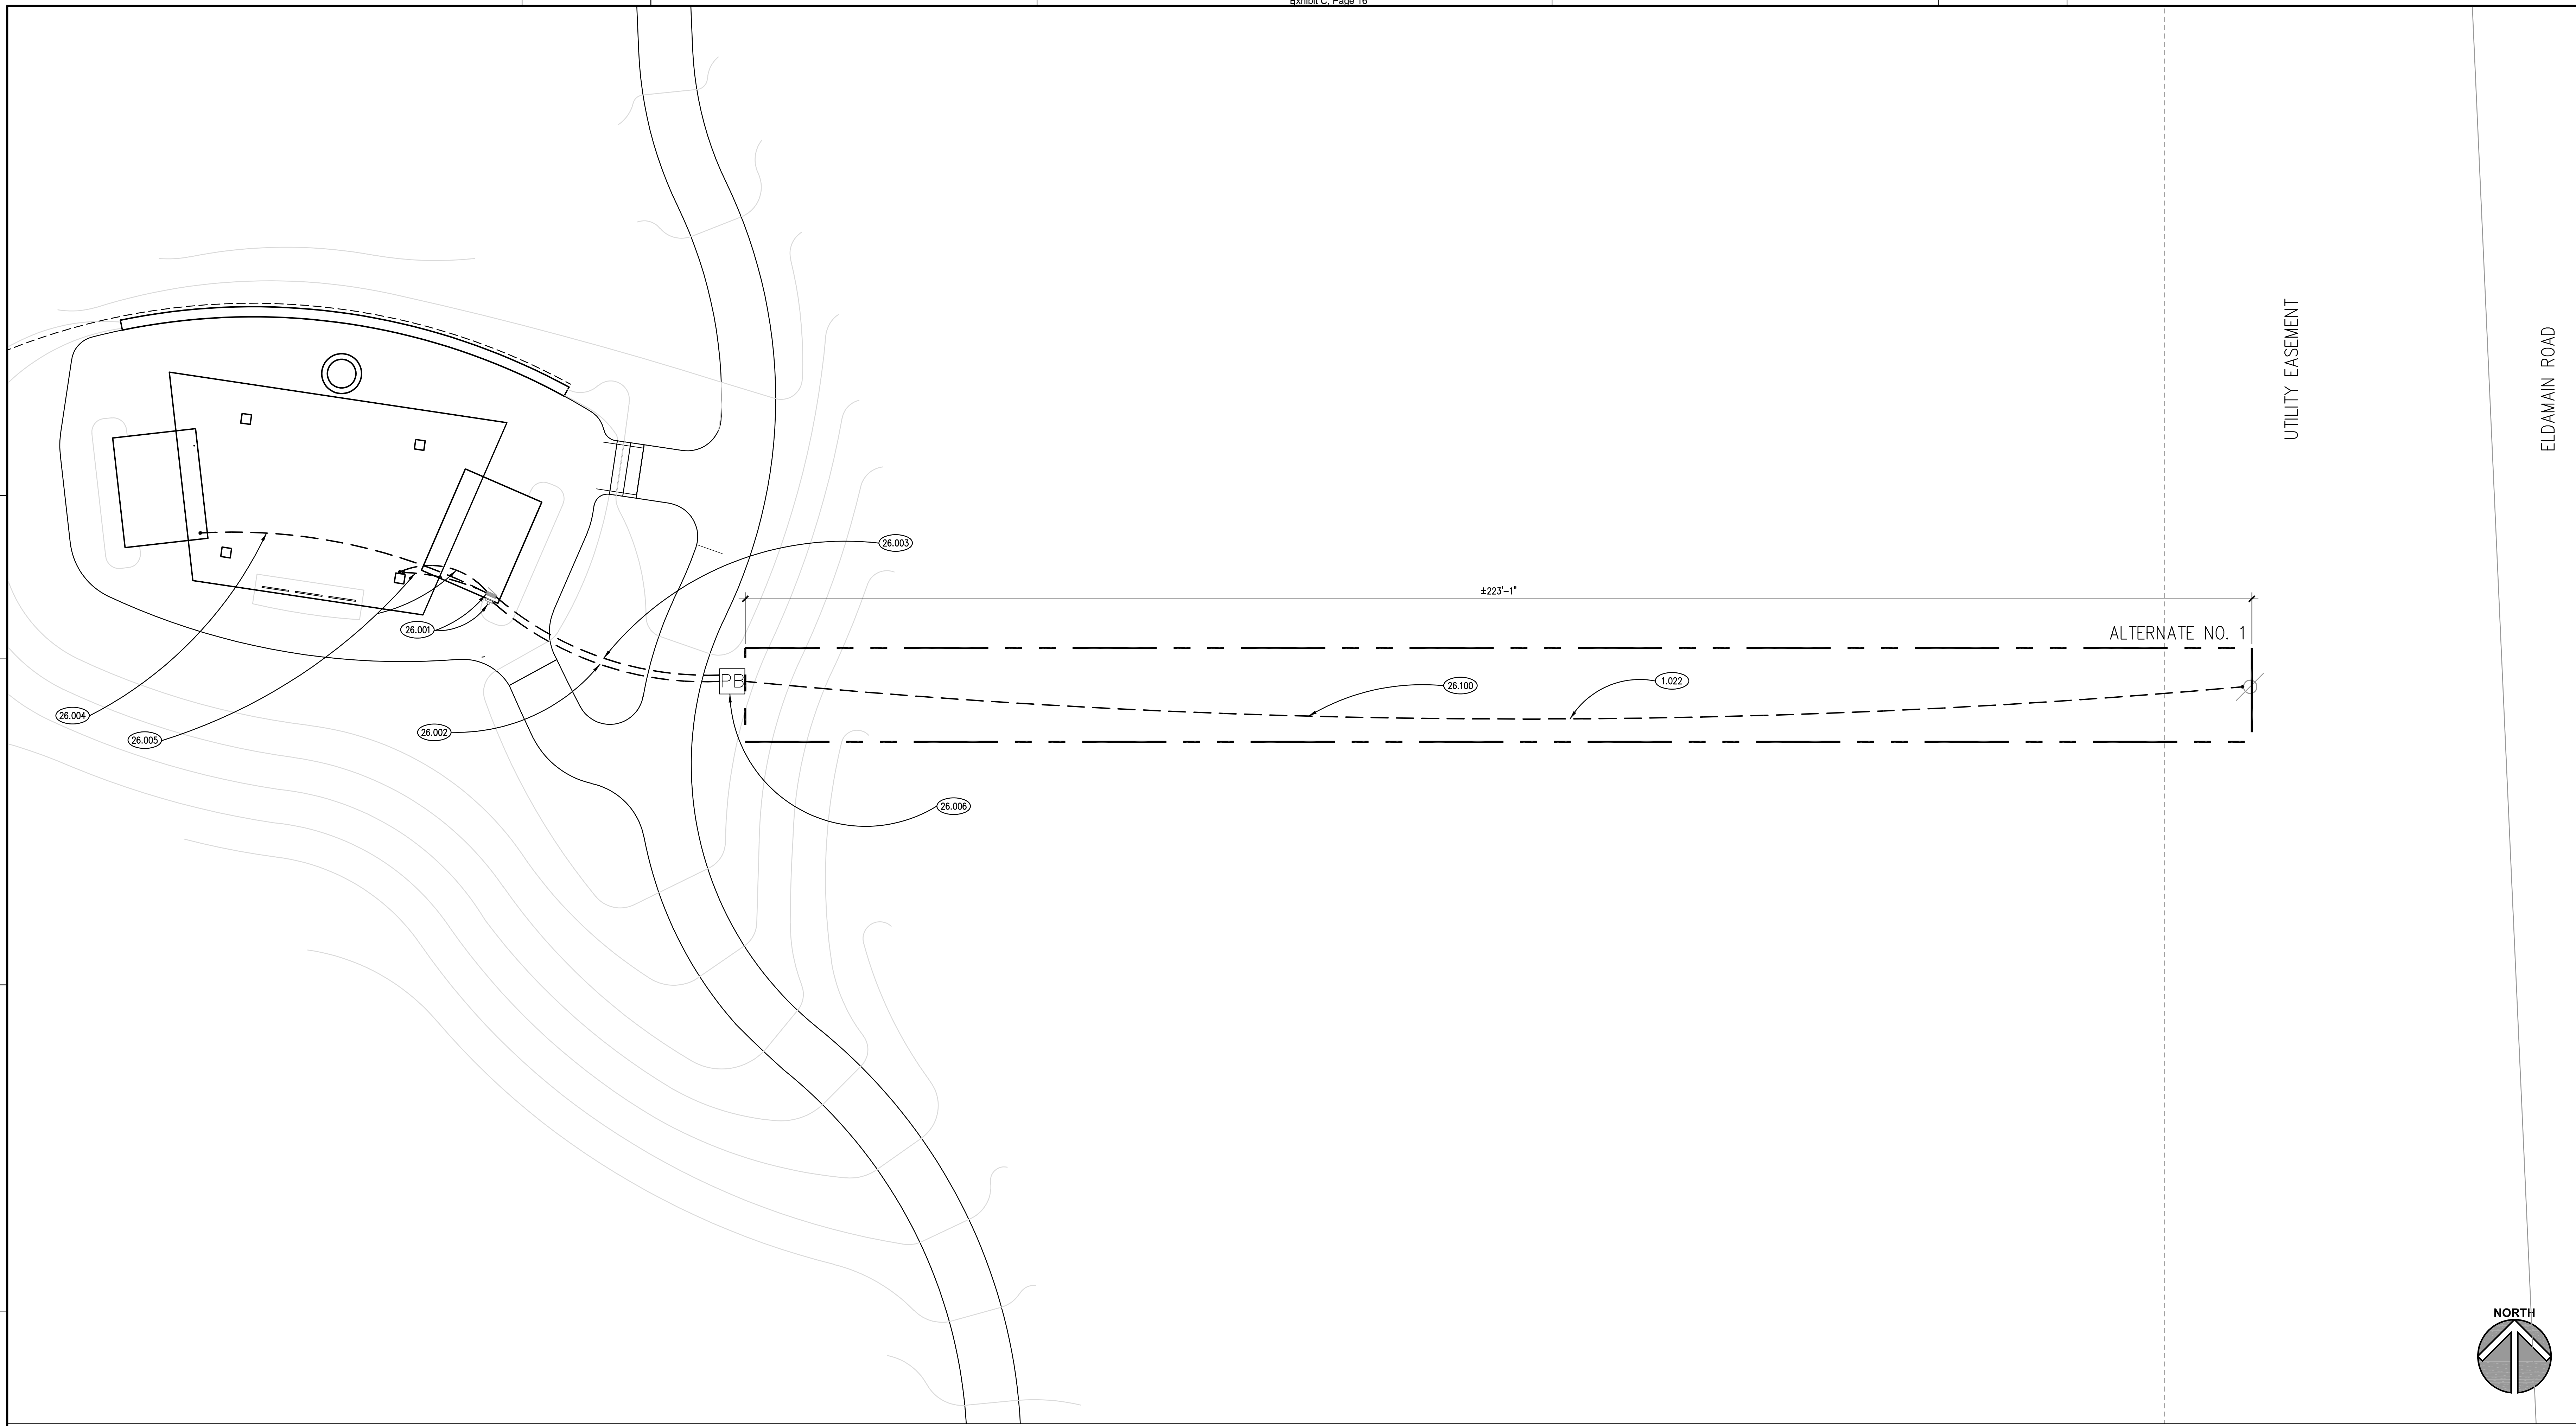

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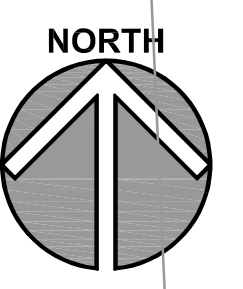
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PLANO, IL 60545

ELDAMAIN ROAD

UTILITY EASEMENT

ALTERNATE NO. 1

±223'-1"



**SITE PLAN** ①  
SCALE: 1" = 10'-0"

**KEYNOTES**

- 1.022 ALTERNATE NO. 1: DIG NECESSARY AREA TO INSTALL CONDUIT AND COORDINATE PRAIRIE GRASS RESTORATION BY OWNER.
- 26.001 FOR REFERENCE ONLY: FUTURE ELECTRICAL SERVICE AND PANELBOARD.
- 26.002 PROVIDE 1-1/2" EMPTY PVC CONDUIT FROM PULL BOX LOCATION, STUBBED AND CAPPED AT BUILDING EXTERIOR (FUTURE SERVICE/METER LOCATION). TRANSITION TO GALVANIZED RIGID STEEL CONDUIT ABOVE GRADE.
- 26.003 PROVIDE 1" EMPTY PVC CONDUIT FROM PULL BOX LOCATION, STUBBED AND CAPPED INTO BUILDING CORNER (FUTURE PANEL LOCATION).
- 26.004 PROVIDE 3/4" EMPTY PVC CONDUIT FROM FUTURE PANEL LOCATION TO SE CORNER OF WEST ROOM AS SHOWN. STUB AND CAP. TRANSITION TO GALVANIZED RIGID STEEL CONDUIT ABOVE GRADE.
- 26.005 PROVIDE 2--2" AND 2--3/4" EMPTY PVC CONDUIT FROM FUTURE PANEL LOCATION TO SE CORNER OF WEST ROOM AS SHOWN. STUB AND CAP. TRANSITION TO GALVANIZED RIGID STEEL CONDUIT ABOVE GRADE. ROUTE CONDUIT THROUGH COLUMN TO ACCESSIBLE CEILING LOCATION.
- 26.006 PROVIDE IN-GRADE PULL BOX. MINIMUM DIMENSION 11"x18". BASIS OF DESIGN: QUIAZITE PG STYLE.
- 26.100 ALTERNATE NO. 1: PROVIDE 1-1/2" EMPTY SCH 40 PVC CONDUIT FROM GROUND MOUNTED PULL BOX STUBBED AND CAPPED AT UTILITY POWER POLE LOCATION. TRANSITION TO GALVANIZED RIGID STEEL ABOVE GRADE.

KEYNOTES ARE TYPICALLY NOT DUPLICATED WITHIN A GIVEN DETAIL. AN UN-KEYNOTED ITEM IN A DETAIL IS THE SAME AS A KEYNOTED ITEM HAVING THE SAME APPEARANCE WITHIN THE SAME DETAIL.

**GENERAL NOTES**

- 1. REFER TO DRAWING G100 FOR PROJECT GENERAL NOTES.
- 2. COORDINATE INFORMATION ON THIS DRAWING WITH INFORMATION CONTAINED ON CIVIL AND LANDSCAPE DRAWINGS.

ISSUED	
OWNER REVIEW	
DATE	
BY	
REVISION	
NO.	
DATE	
BY	

JOB NO. 23-429-1495  
DRAWN SKF  
CHECKED CJH  
APPROVED CJH

SHEET TITLE  
**ARCHITECTURAL SITE PLAN**

SHEET NUMBER

**A010**

**BASE BID: BROOM FINISH CONCRETE SLAB WITH TOOLED JOINTS; REFER TO STRUCTURAL DRAWINGS.**

**ALTERNATE NO. 2: IN LIEU OF BROOMED EXTERIOR CONCRETE SLAB, PROVIDE STAMPED AND STAINED DECORATIVE CONCRETE PAVEMENT WITH DECORATIVE STAINING AND ANIMAL TRACK STAMPING AT NATURE CENTER. REFER TO KEY FOR TYPES OF ANIMALS, TRACK SIZE, AND SPACING.**

**KEYNOTES**


KEYNOTES ARE TYPICALLY NOT DUPLICATED WITHIN A GIVEN DETAIL. AN UN-KEYNOTED ITEM IN A DETAIL IS THE SAME AS A KEYNOTED ITEM HAVING THE SAME APPEARANCE WITHIN THE SAME DETAIL.

- 5.751 DECORATIVE METAL PANEL: 4'-0" WIDE X 8'-0" TALL X 1/4" THICK STEEL PLATE, CNC CUT AND POWDERCOATED, EASED EDGES AND 1" RADIUS CORNERS; REFER TO ALLOWANCES AND SPECIFICATIONS.
- 7.715 METAL DOWNSPOUT ACCESSORY: RAIN CHAIN: DOUBLE LOOPS RAIN CHAIN, BRONZE COLOR; REFER TO SPECIFICATIONS.
- 8.820 DISPLAY GLAZING SYSTEM: 11 SHELF CABLE SYSTEM; REFER TO SPECIFICATIONS.
- 10.140 SIGNAGE: INTREPRETIVE DISPLAY TYPE; REFER TO ALLOWANCES.
- 32.133 FUTURE RETAINING WALL.
- 32.310 PARK BENCH: 6' LONG; EMBED MOUNT; CEDAR FINISH.
- 32.311 STATIONARY BINOCULARS: MARK II DUAL ADA COMPLIANT BASE; REFER TO SPECIFICATIONS.


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Aurora, Illinois 60506  
Tel: 630.346.2213  
Bloomington, Illinois 61704  
Tel: 309.330.0400  
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PLANO, IL 60545



**ANIMAL TRACK KEY**

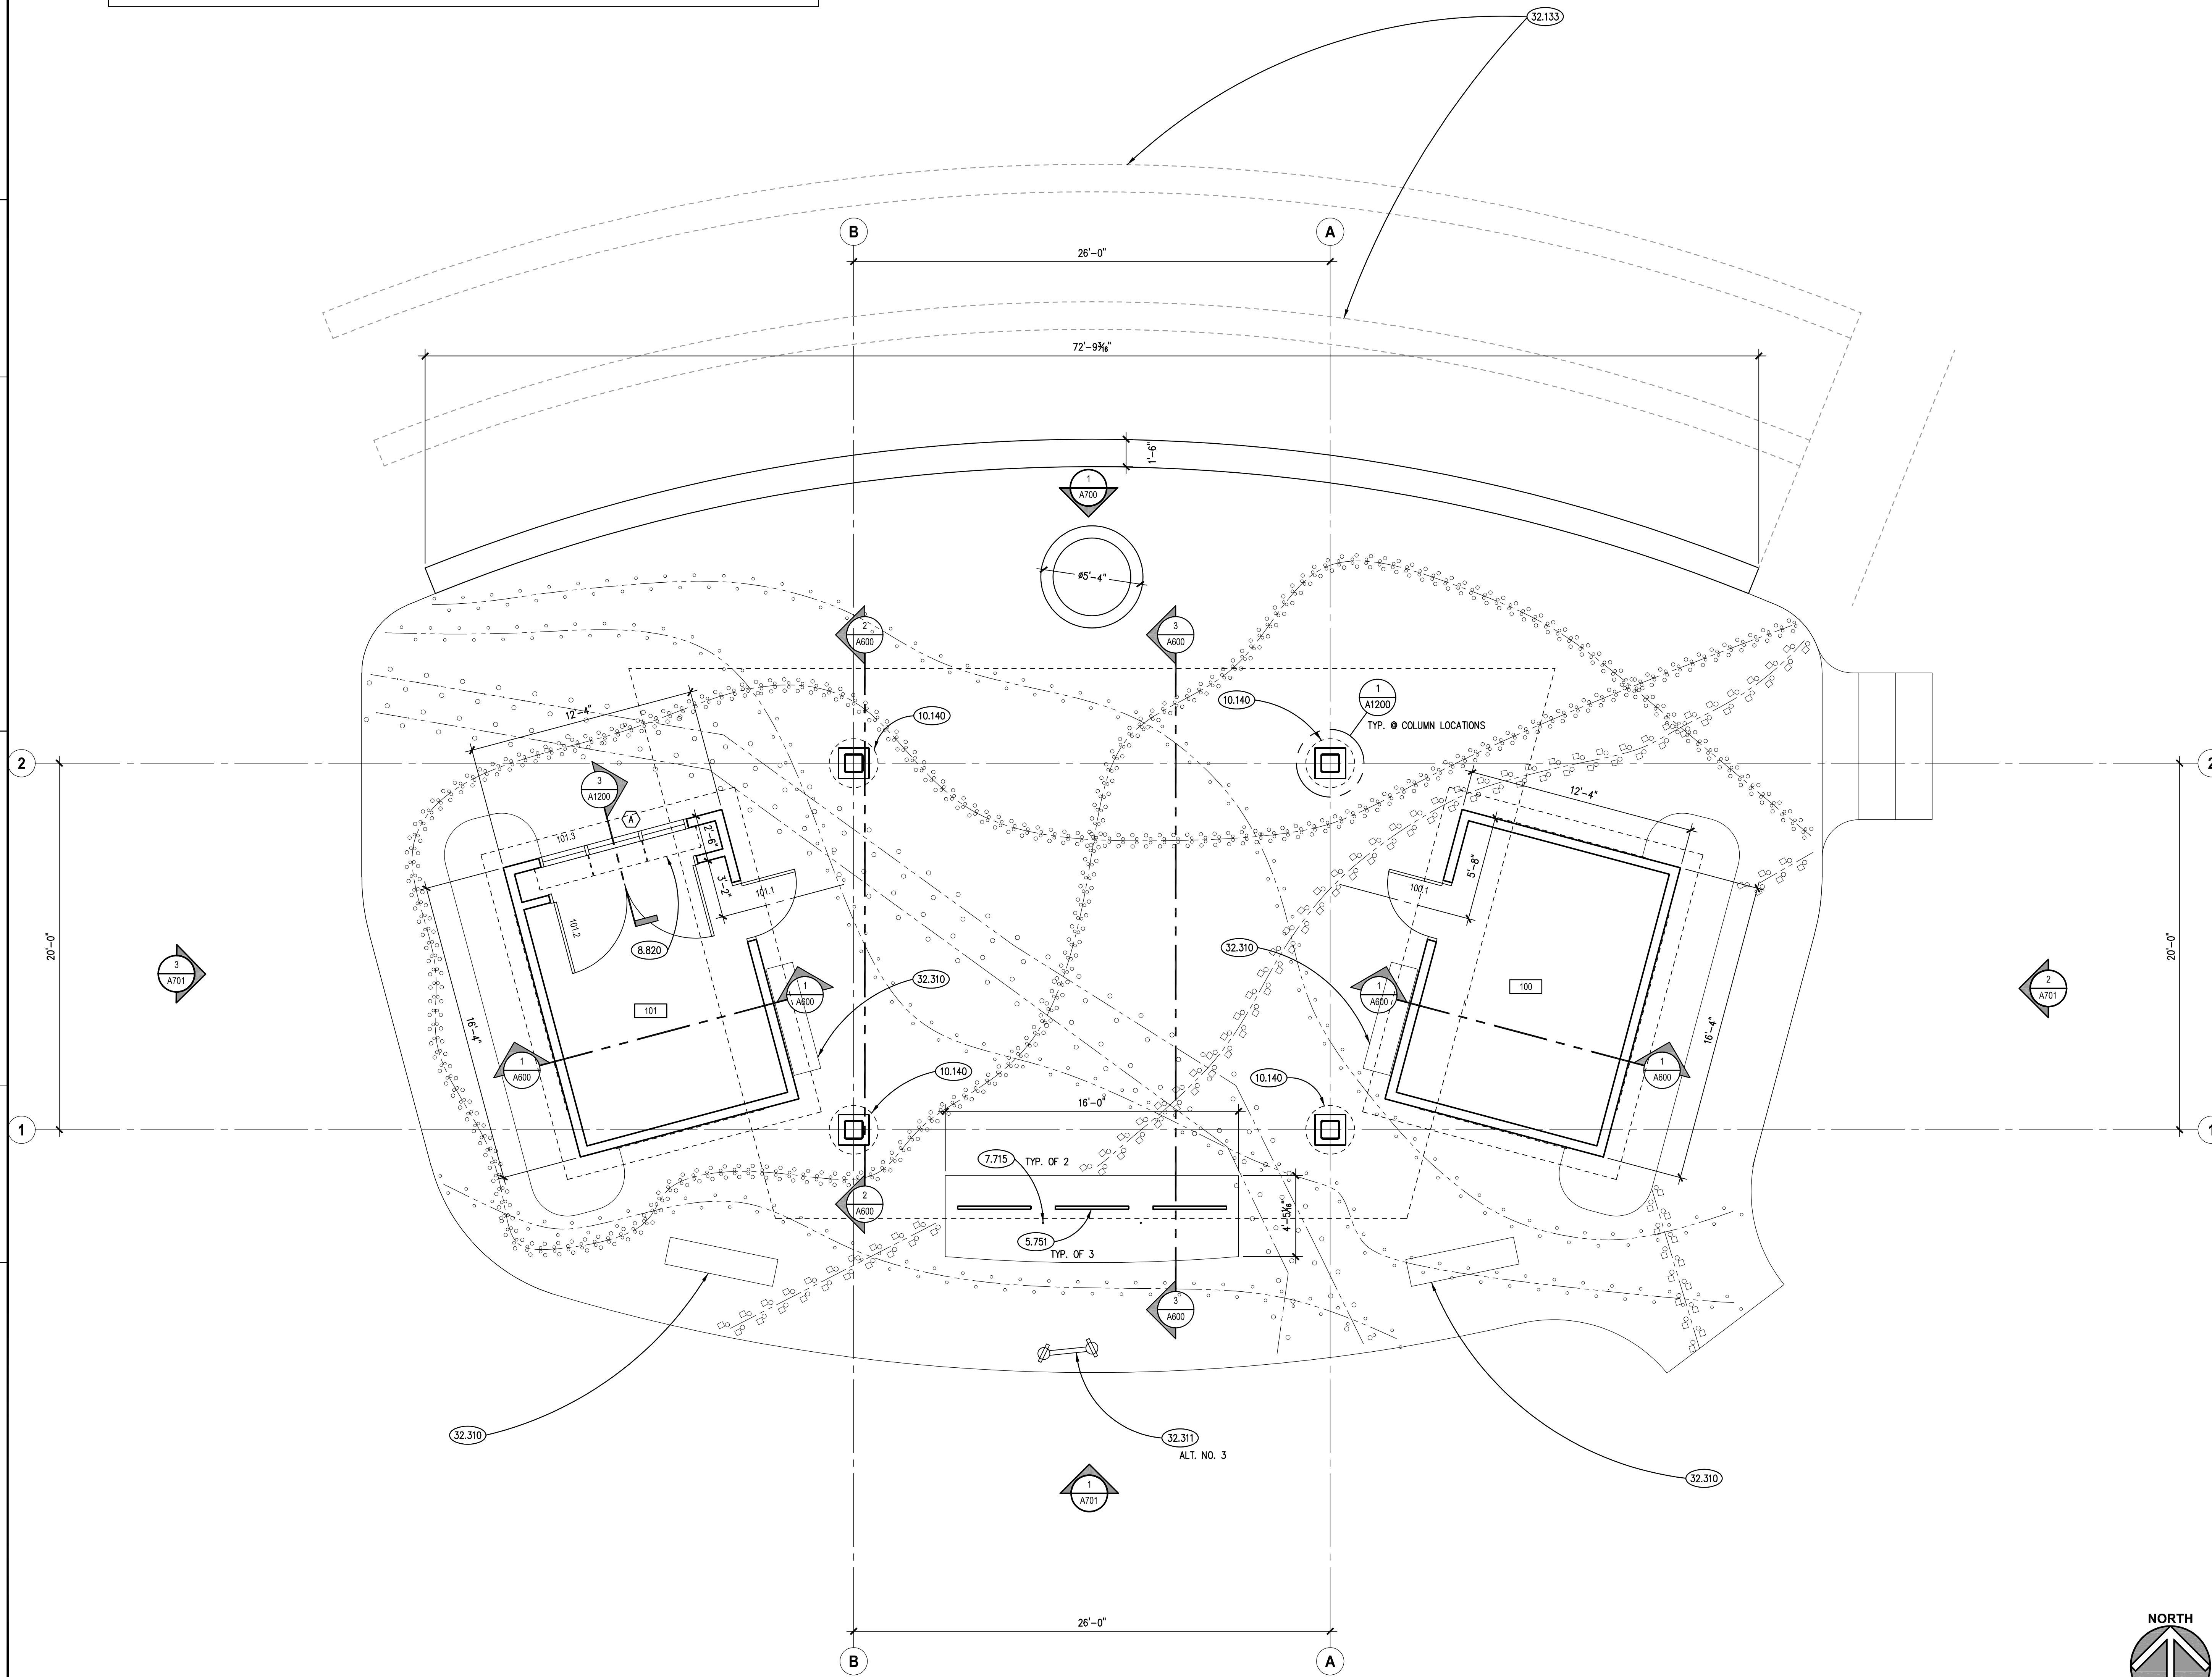

**ROOM SCHEDULE**

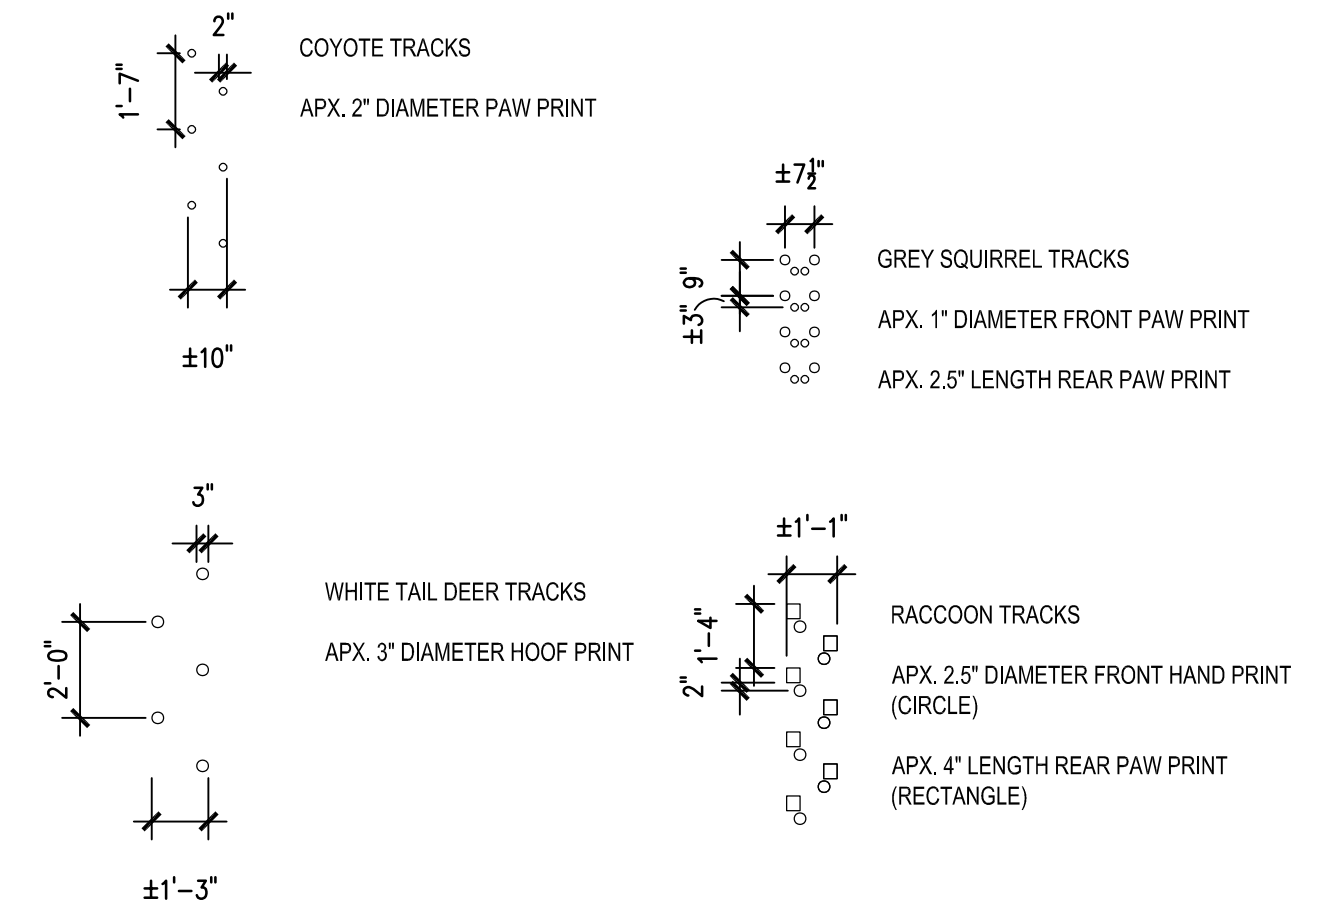RM. NO.	ROOM NAME	RM. NO.	ROOM NAME
100	EAST SHED		
101	WEST SHED		

**GENERAL NOTES**

1. REFER TO DRAWING G100 FOR PROJECT GENERAL NOTES.
2. REFER TO DRAWING A700 FOR ORTHOGONAL ELEVATIONS OF EAST AND WEST SHEDS.
3. REFER TO LANDSCAPE DRAWINGS FOR SLAB DIMENSIONS.

**FIRST FLOOR PLAN**  
SCALE: 1/4" = 1'-0" 1

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OWNER REVIEW	
DATE	
BID DOCUMENTS	

JOB NO. 23-429-1495  
DRAWN SKF/PJT  
CHECKED CJH  
APPROVED CJH

SHEET TITLE  
**ARCHITECTURAL  
FIRST FLOOR PLAN**

SHEET NUMBER


**A310**

NOTE: SCALES DEPICTED ON THIS DRAWING ARE NOT CORRECT UNLESS PLOTTED SHEET SIZE IS 30 X 42 INCHES.

### KEYNOTES

KEYNOTES ARE TYPICALLY NOT DUPLICATED WITHIN A GIVEN DETAIL. AN UN-KEYNOTED ITEM IN A DETAIL IS THE SAME AS A KEYNOTED ITEM HAVING THE SAME APPEARANCE WITHIN THE SAME DETAIL.

- 7.310 ASPHALT SHINGLE ROOFING SYSTEM; REFER TO SPECIFICATIONS.
- 7.712 METAL GUTTER; MATERIAL, 6 INCH K-OGEE PROFILE; THICKNESS AND FINISH AS SPECIFIED.
- 7.713 METAL DOWNSPOUT; MATERIAL, 3 INCH X 4 INCH RIBBED; THICKNESS AND FINISH AS SPECIFIED.
- 7.716 METAL DOWNSPOUT ACCESSORY; RAIN CHAIN ACCESSORY; INSTALLATION KIT; REFER TO SPECIFICATIONS.

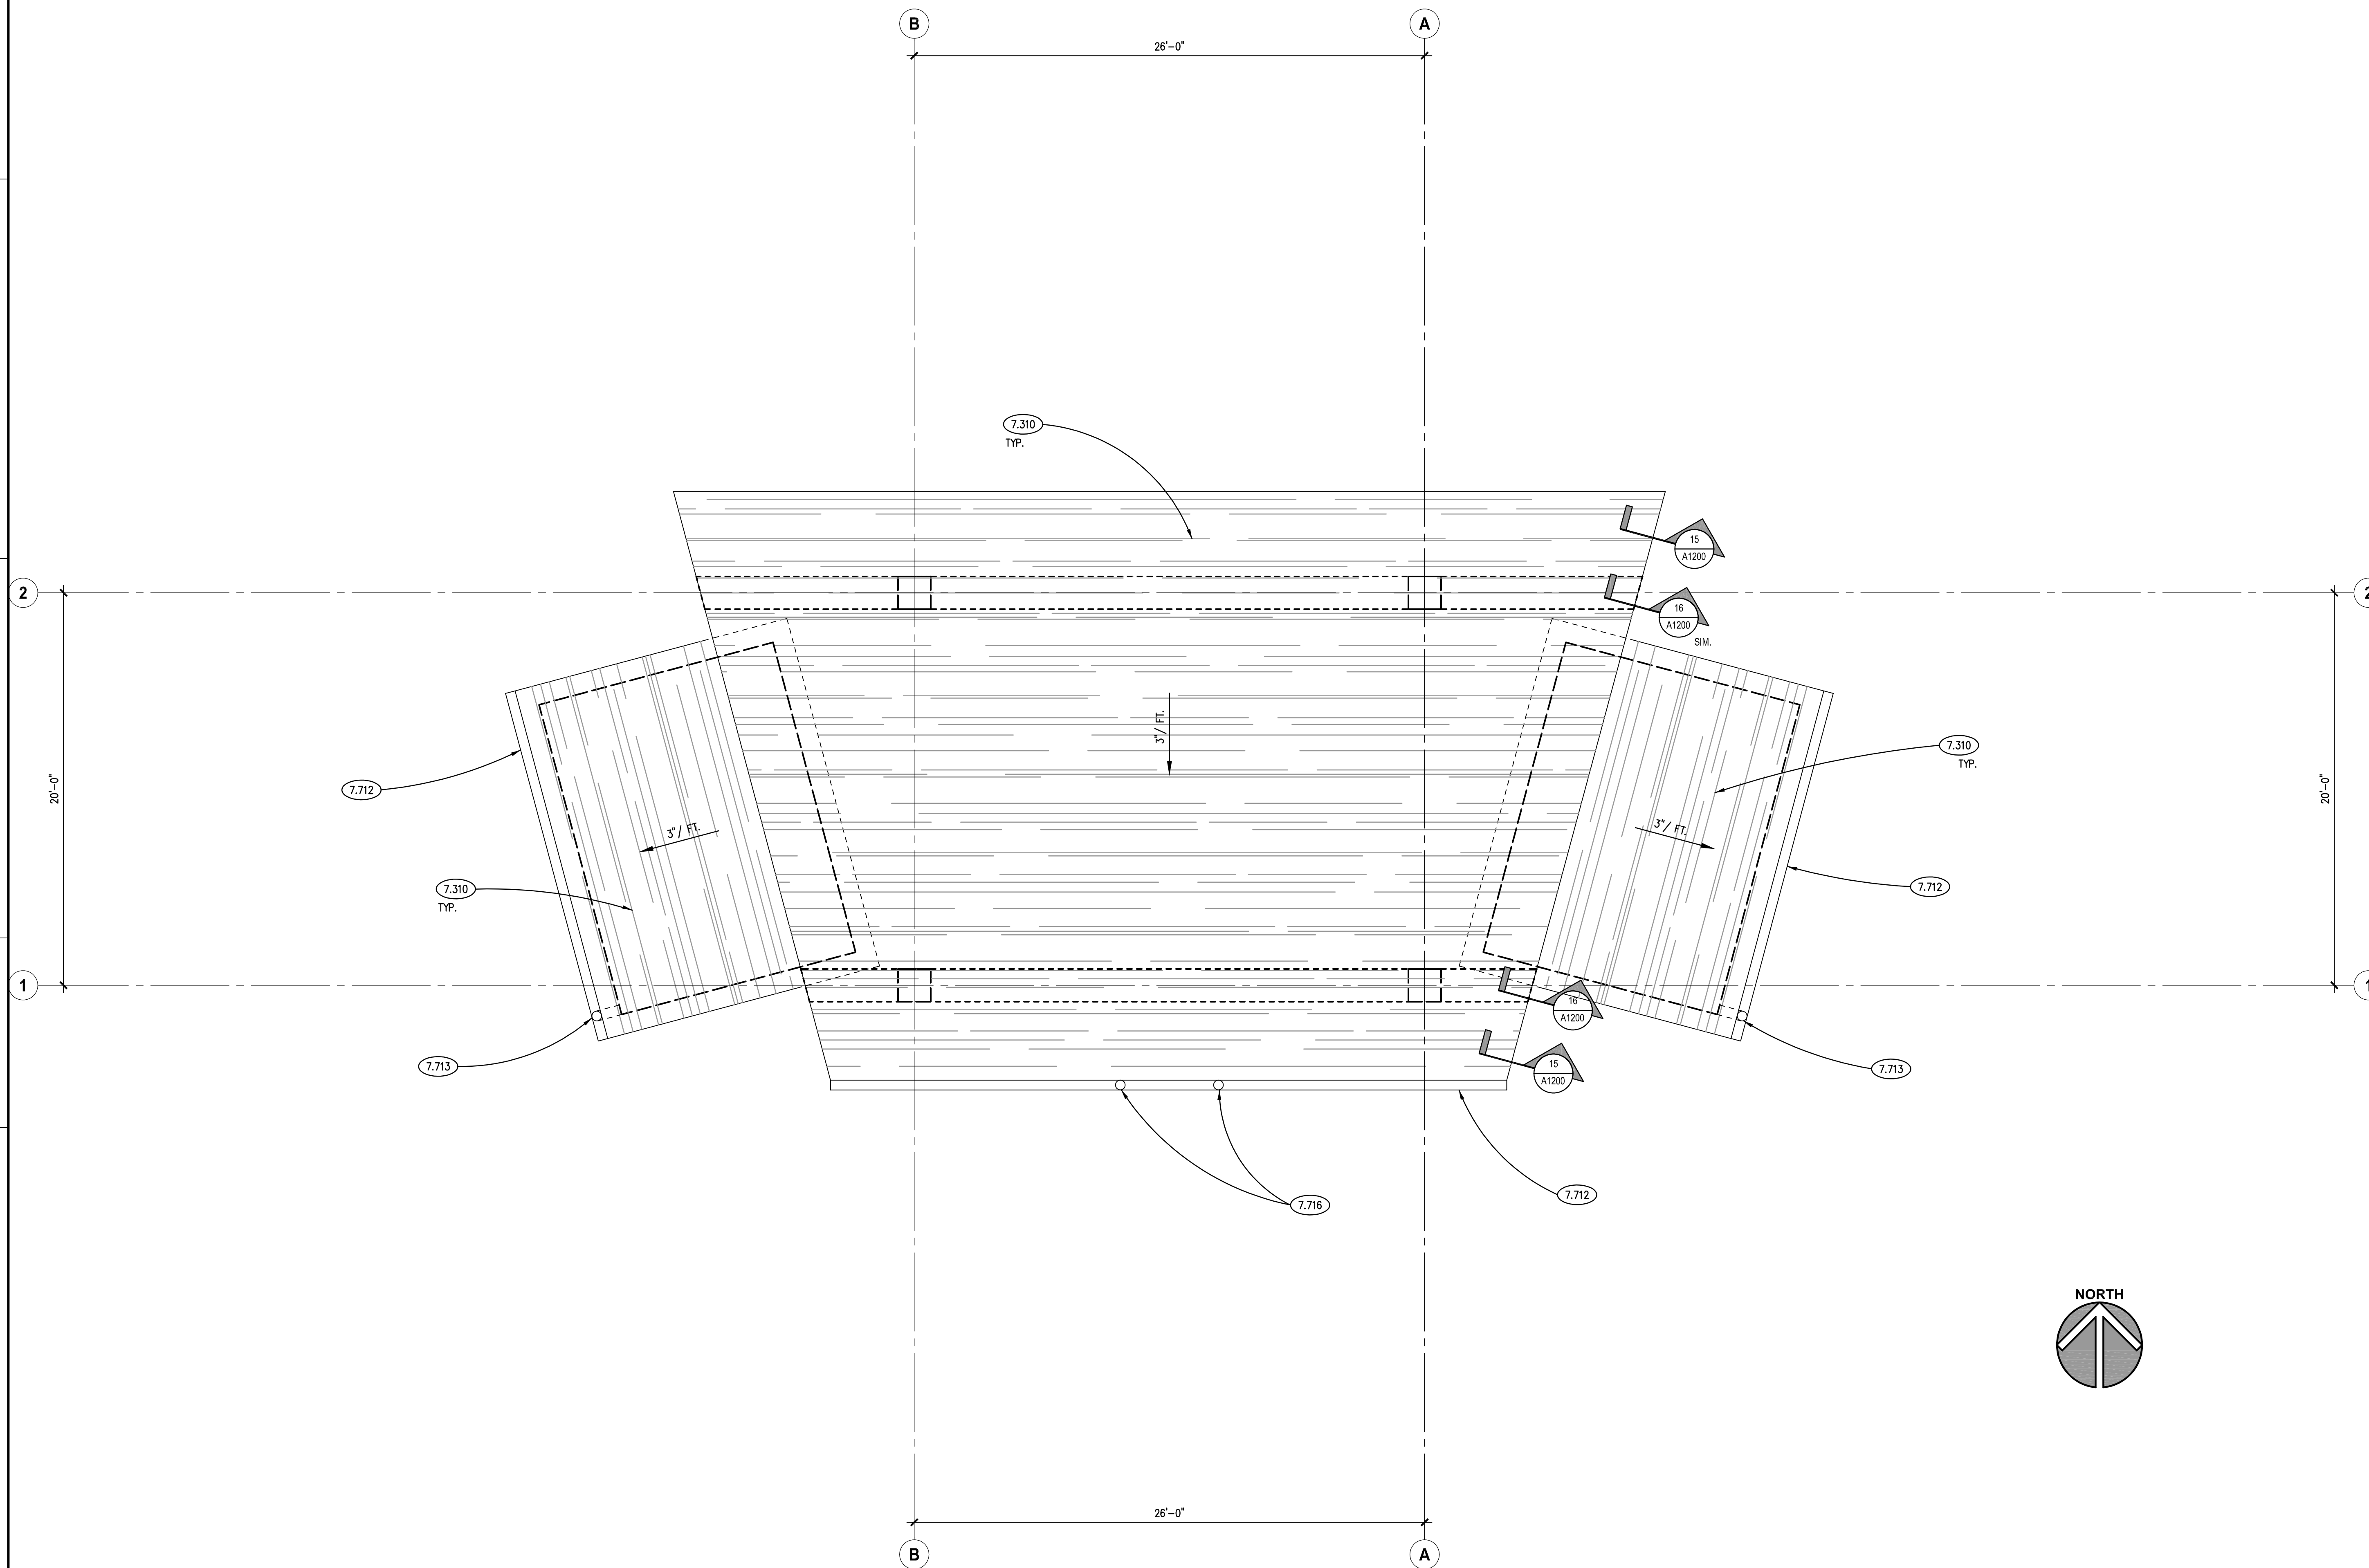

### ROOF PLAN

SCALE: 1/16" = 1'-0" 1

### GENERAL NOTES

1. REFER TO DRAWING G100 FOR PROJECT GENERAL NOTES.

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REVISION	


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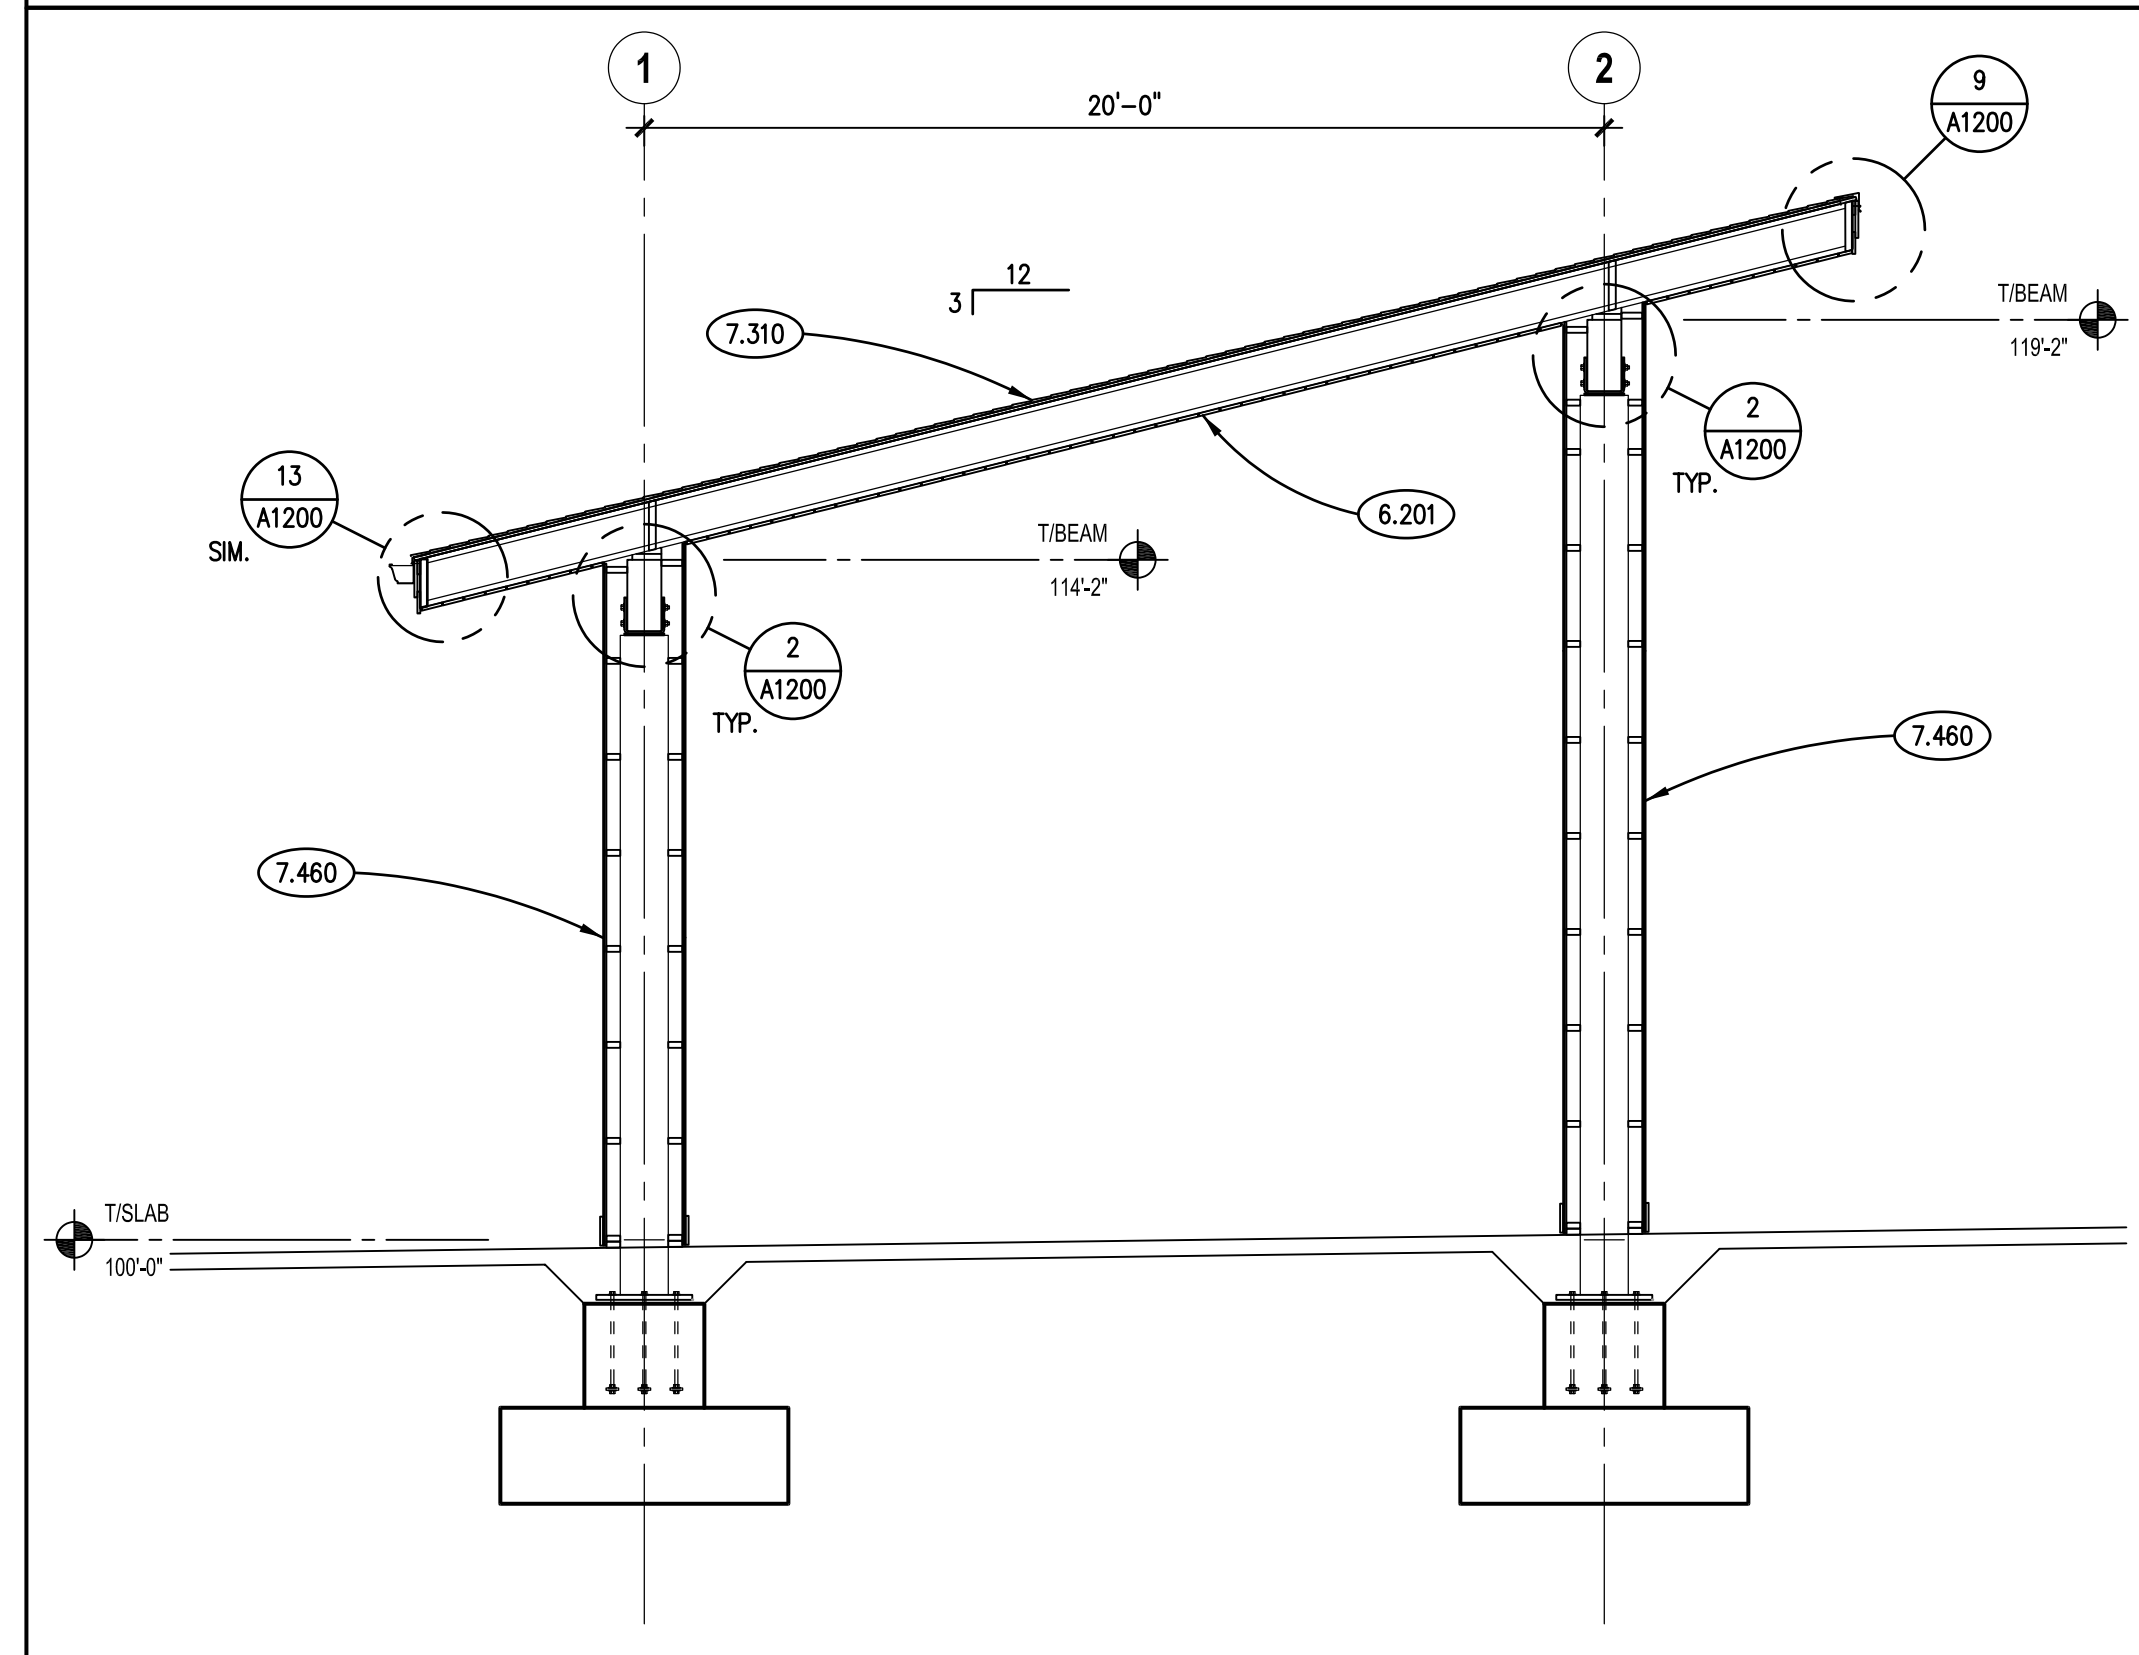
ROOF PLAN

SHEET NUMBER


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**CANOPY BUILDING SECTION 3**  
SCALE: 1/4" = 1'-0"



**CANOPY BUILDING SECTION 2**  
SCALE: 1/4" = 1'-0"

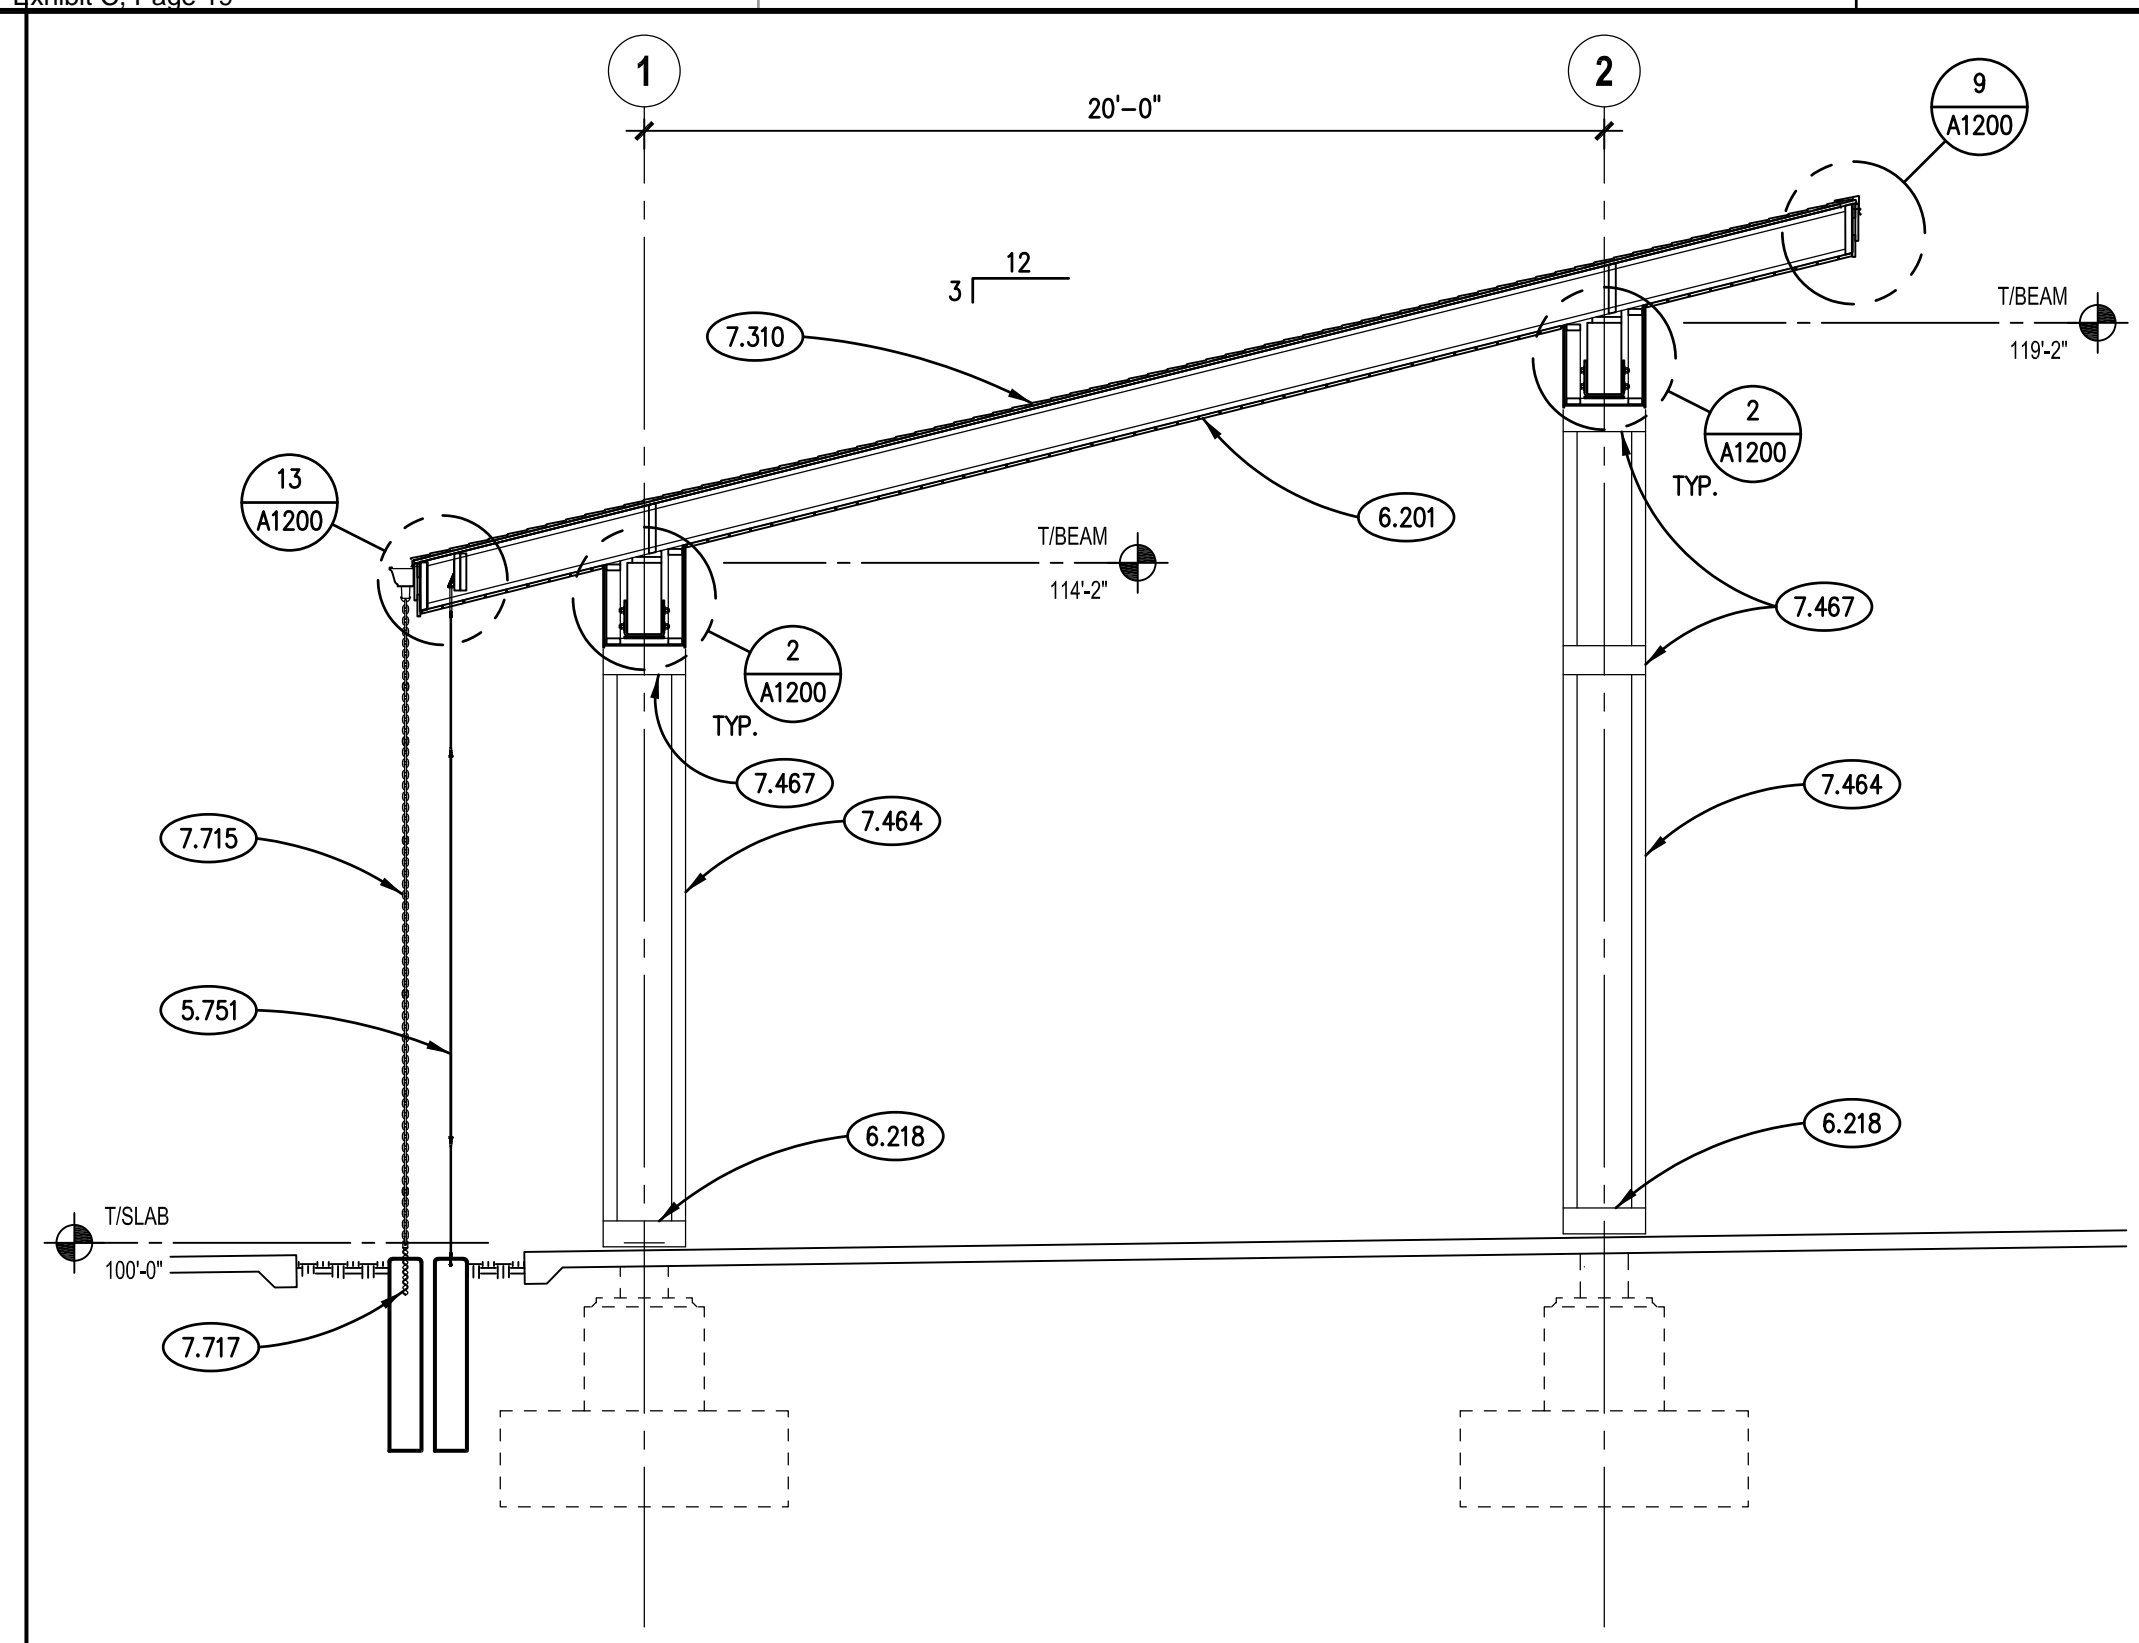

**SHED BUILDING SECTION 1**  
SCALE: 1/4" = 1'-0"

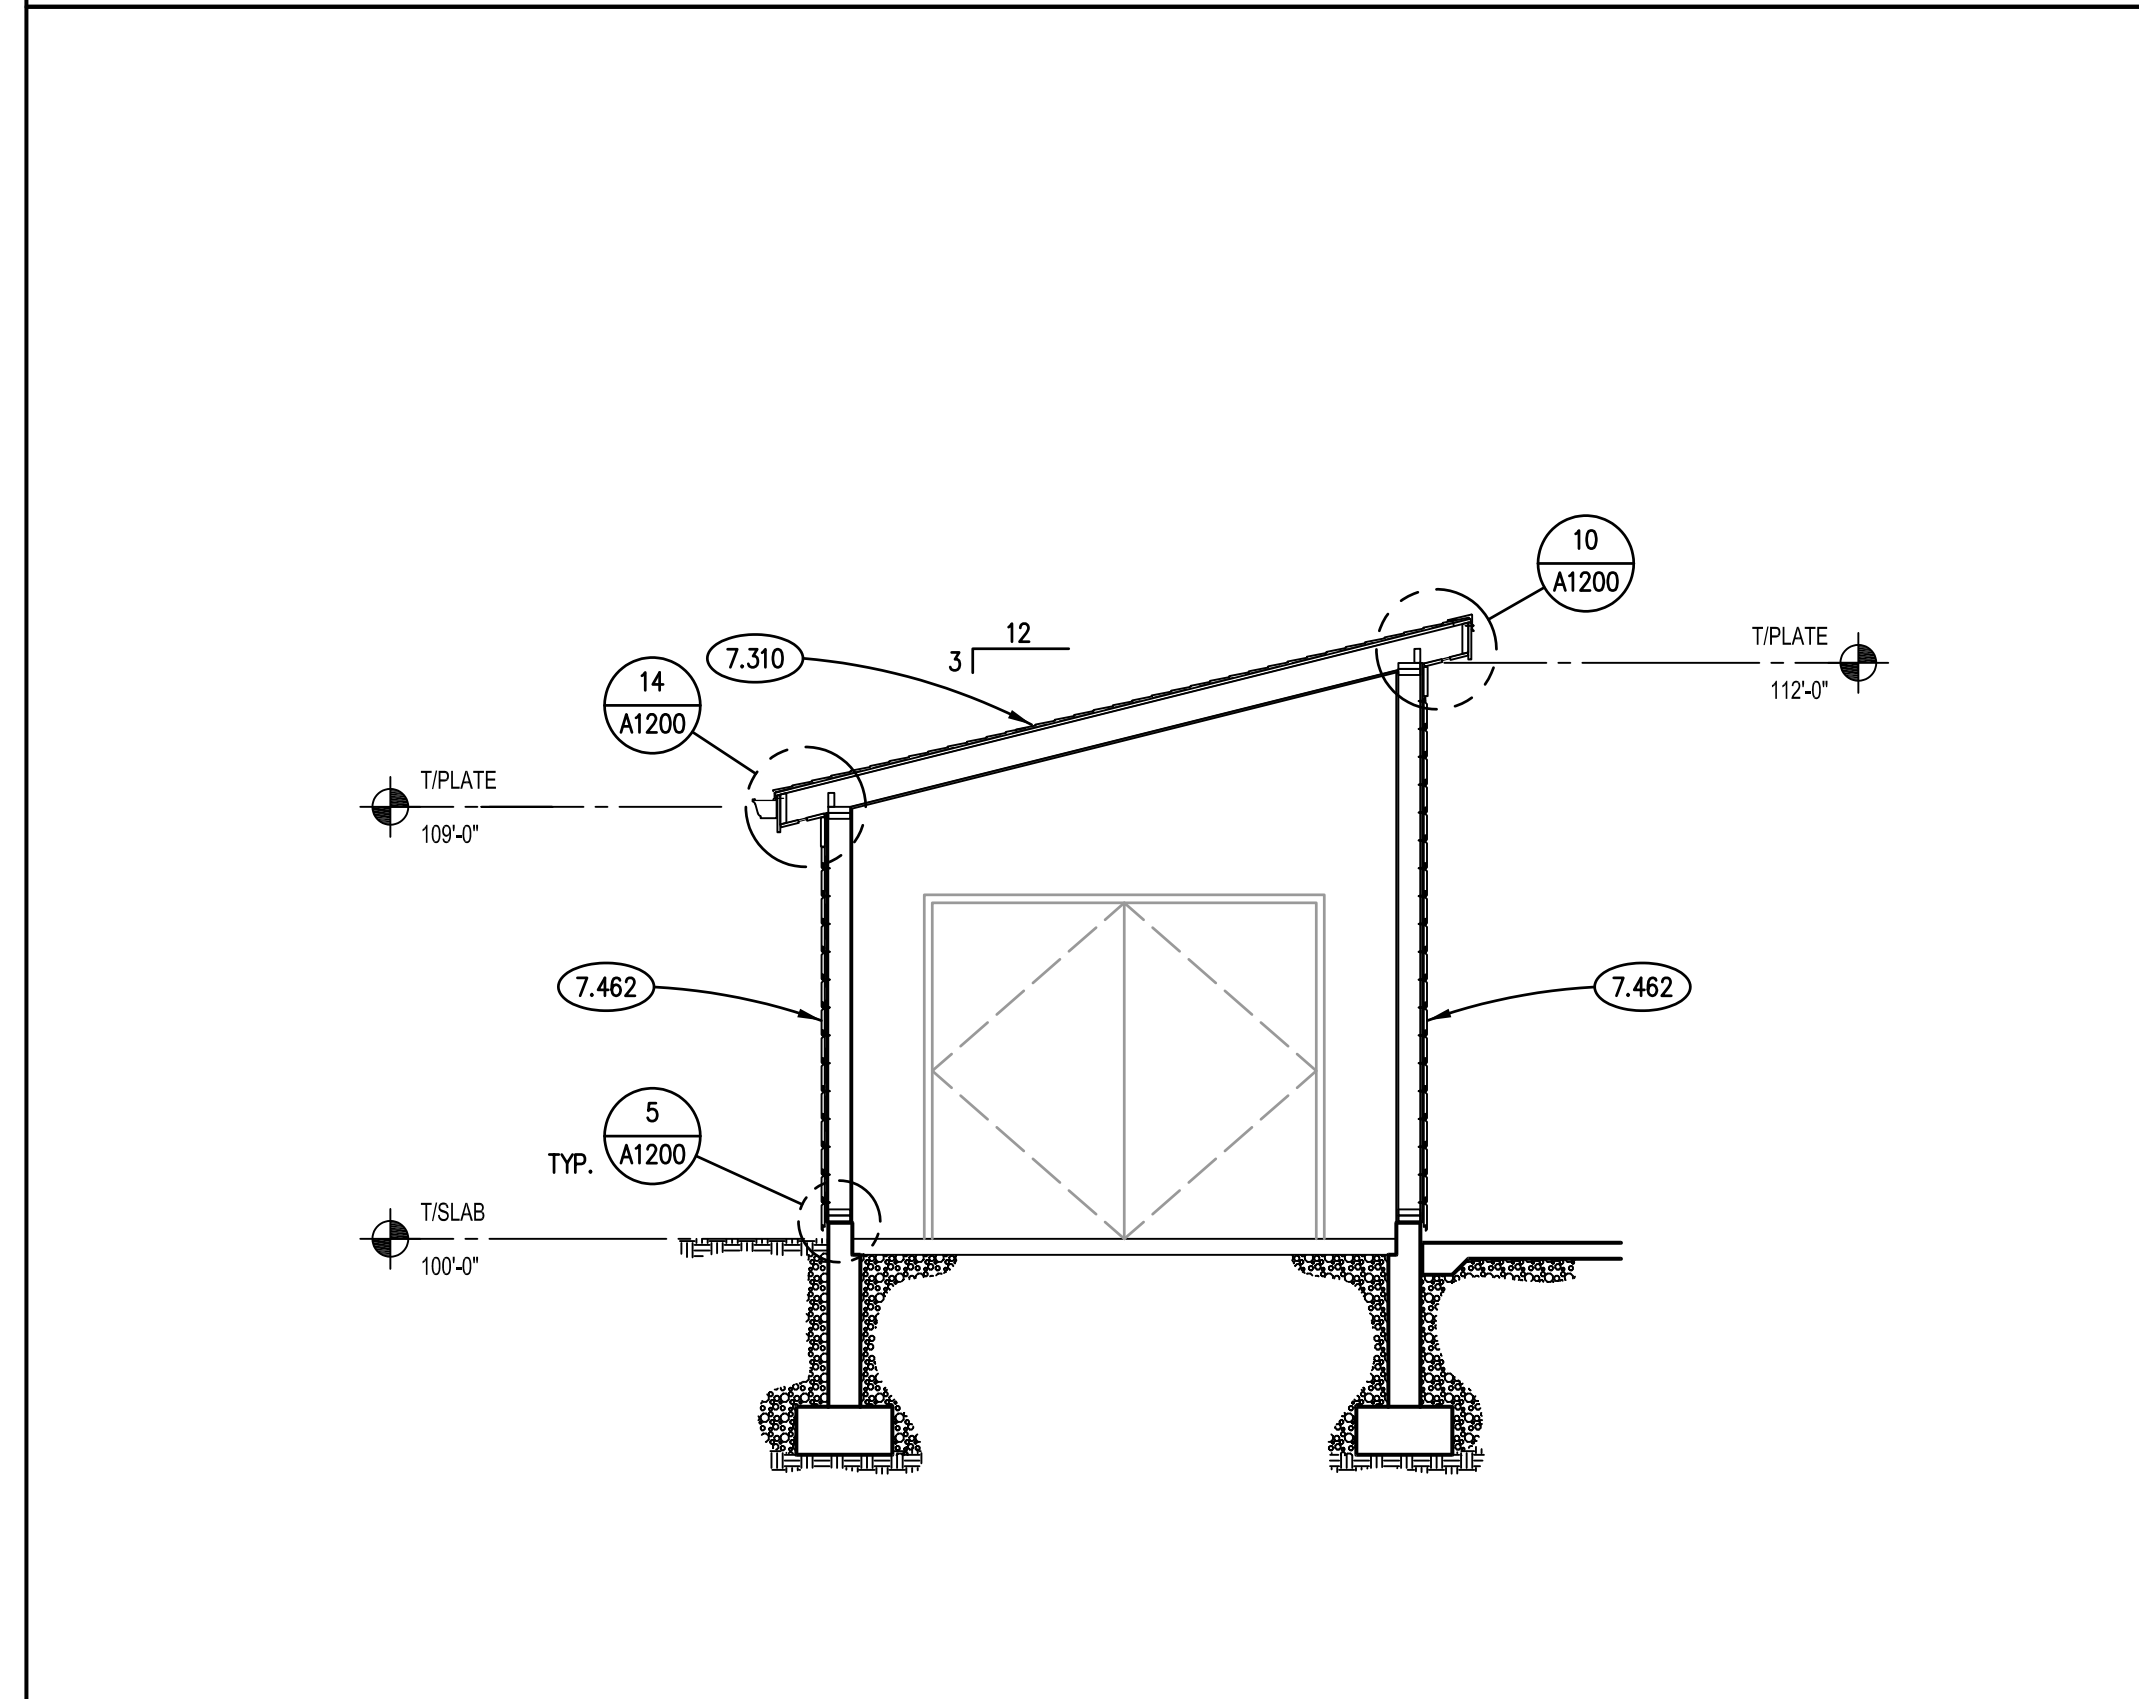**KEYNOTES**

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- 5.751 DECORATIVE METAL PANEL: 4'-0" WIDE X 8'-0" TALL X 1/2" THICK STEEL PLATE, CNC CUT AND POWDERCOATED, EASED EDGES AND 1" RADIUS CORNERS; REFER TO ALLOWANCES AND SPECIFICATIONS.
- 6.201 FINISH CARPENTRY: EXTERIOR SOFFIT LUMBER; 1 X 6 TONGUE AND GROOVE.
- 6.218 FINISH CARPENTRY: CELLULAR PVC TRIM: 1/2" X 7.25" (ACTUAL); REFER TO SPECIFICATIONS.
- 7.310 ASPHALT SHINGLE ROOFING SYSTEM; REFER TO SPECIFICATIONS.
- 7.460 FIBER CEMENT SIDING; REFER TO SPECIFICATIONS.
- 7.462 FIBER CEMENT SIDING: 5/8" THK. HORIZONTAL V-GROOVE LAP SIDING, 7" EXPOSURE; PRIMED. REFER TO SPECIFICATIONS.
- 7.464 FIBER CEMENT SIDING: 3.5" X 5/4" TRIM BOARD; PRIMED.
- 7.467 FIBER CEMENT SIDING: 7.25" X 5/4" TRIM BOARD; PRIMED.
- 7.715 METAL DOWNSPOUT ACCESSORY: RAIN CHAIN: DOUBLE LOOPS RAIN CHAIN, BRONZE COLOR; REFER TO SPECIFICATIONS.
- 7.717 METAL DOWNSPOUT ACCESSORY: RAIN CHAIN ACCESSORY: ANCHOR STAKE CAST INTO CONCRETE PIER; REFER TO SPECIFICATIONS.

**GENERAL NOTES**

- 1. REFER TO DRAWING G100 FOR PROJECT GENERAL NOTES.

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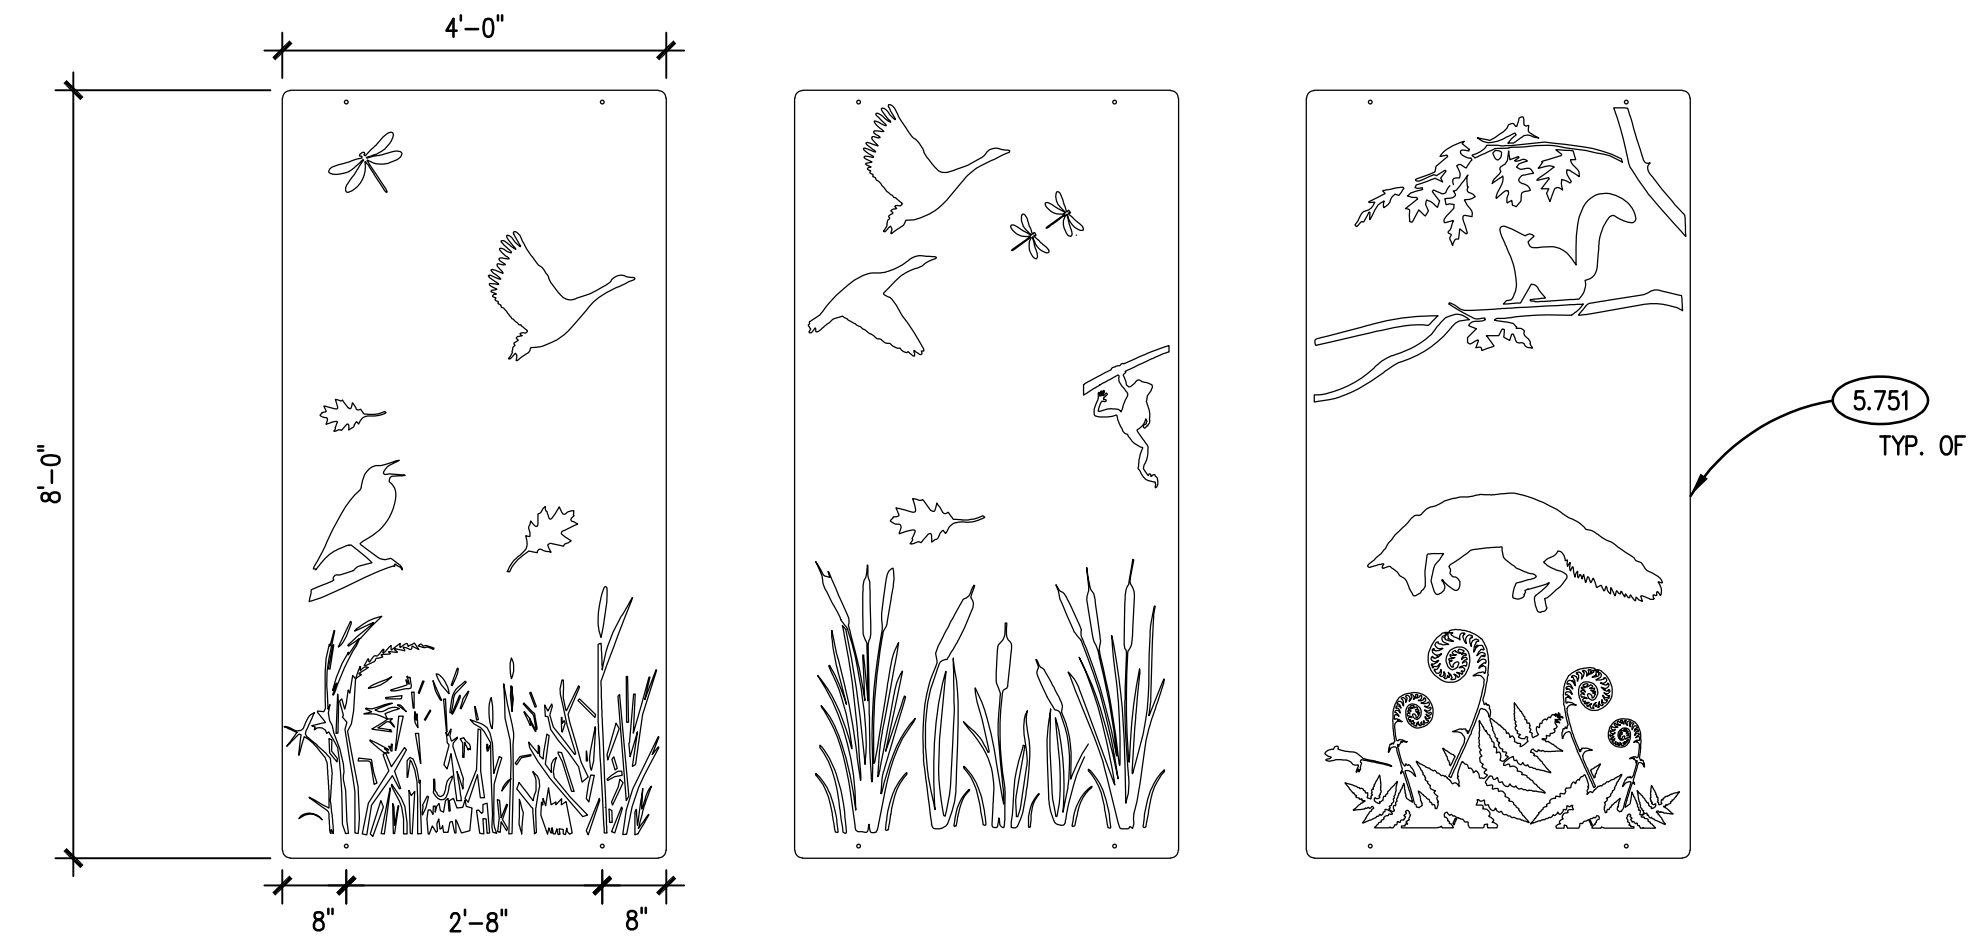
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BUILDING SECTIONS

SHEET NUMBER

**A600**





**KEYNOTES**


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- 6.201 FINISH CARPENTRY: EXTERIOR SOFFIT LUMBER; 1 X 6 TONGUE AND GROOVE.
- 6.218 FINISH CARPENTRY: CELLULAR PVC TRIM: 1/2" X 7.25" (ACTUAL); REFER TO SPECIFICATIONS.
- 7.310 ASPHALT SHINGLE ROOFING SYSTEM; REFER TO SPECIFICATIONS.
- 7.462 FIBER CEMENT SIDING: 5/8" THK. HORIZONTAL V-GROOVE LAP SIDING; 7" EXPOSURE; PRIMED. REFER TO SPECIFICATIONS.
- 7.464 FIBER CEMENT SIDING: 3.5" X 5/4" TRIM BOARD; PRIMED.
- 7.467 FIBER CEMENT SIDING: 5.5" X 5/4" TRIM BOARD; PRIMED.
- 7.467 FIBER CEMENT SIDING: 7.25" X 5/4" TRIM BOARD; PRIMED.
- 7.468 FIBER CEMENT SIDING: 9.25" X 3/4" TRIM BOARD; PRIMED.
- 7.712 METAL GUTTER: MATERIAL, 6 INCH K-OGEE PROFILE; THICKNESS AND FINISH AS SPECIFIED.
- 7.713 METAL DOWNSPOUT: MATERIAL, 3 INCH X 4 INCH RIBBED; THICKNESS AND FINISH AS SPECIFIED.
- 7.715 METAL DOWNSPOUT ACCESSORY: RAIN CHAIN: DOUBLE LOOPS RAIN CHAIN, BRONZE COLOR; REFER TO SPECIFICATIONS.
- 8.110 STEEL DOOR FRAME: REFER TO DOOR, FRAME AND BORROWED LIGHT SCHEDULE.
- 8.111 STEEL WINDOW FRAME: REFER TO DOOR, FRAME AND BORROWED LIGHT SCHEDULE.
- 10.140 SIGNAGE: INTREPRETIVE DISPLAY TYPE; REFER TO ALLOWANCES.

**DECORATIVE METAL PANEL ELEVATIONS**

SCALE: 1/2" = 1'-0"


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**EAST SHED ELEVATIONS**

SCALE: 1/4" = 1'-0"

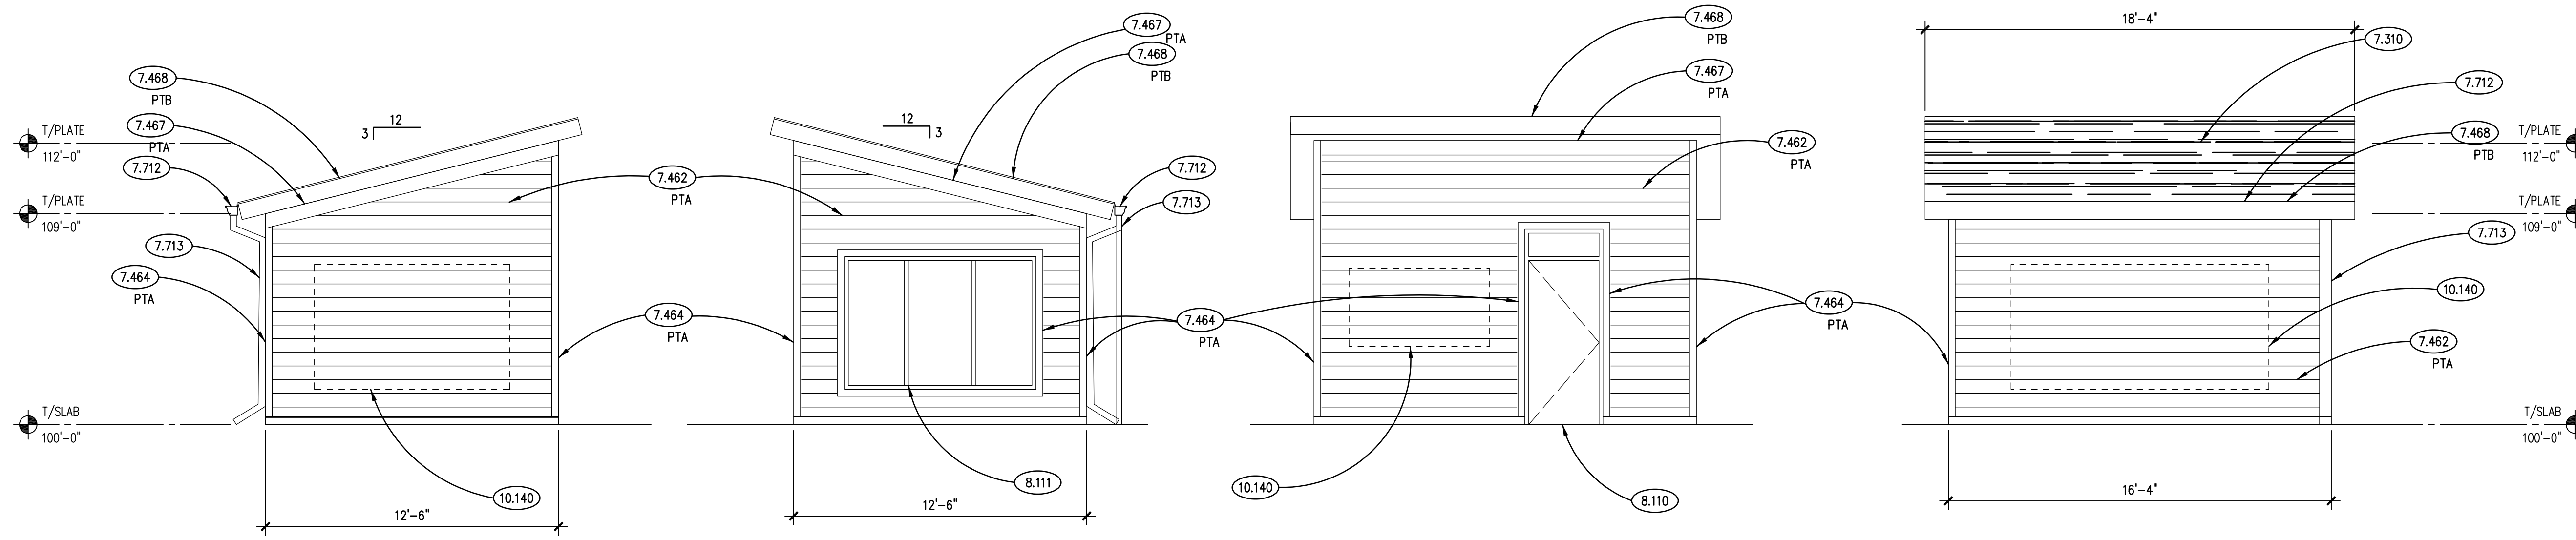
3



**WEST SHED ELEVATIONS**

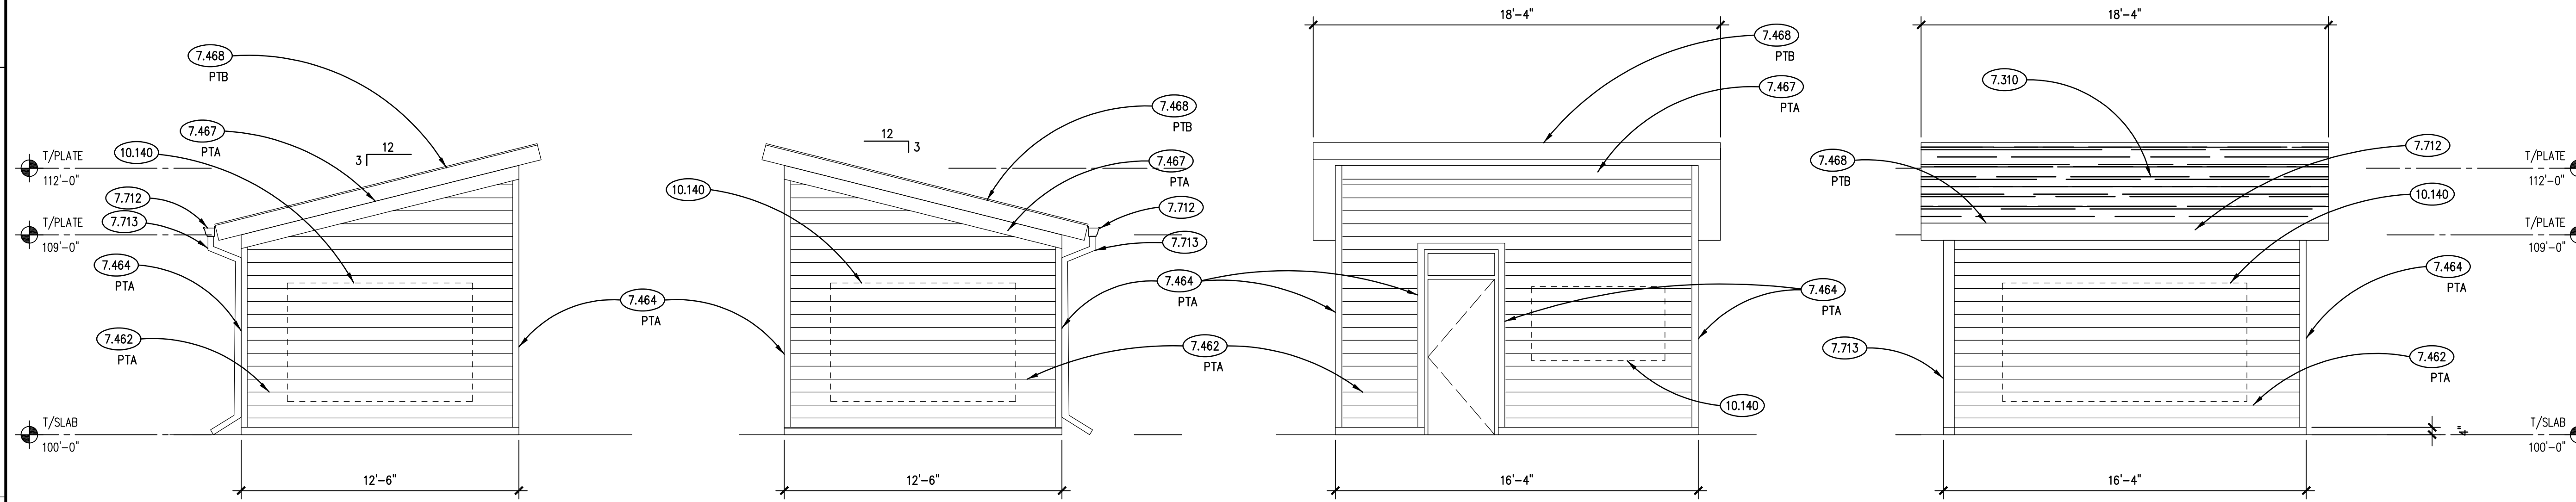SCALE: 1/4" = 1'-0"

2

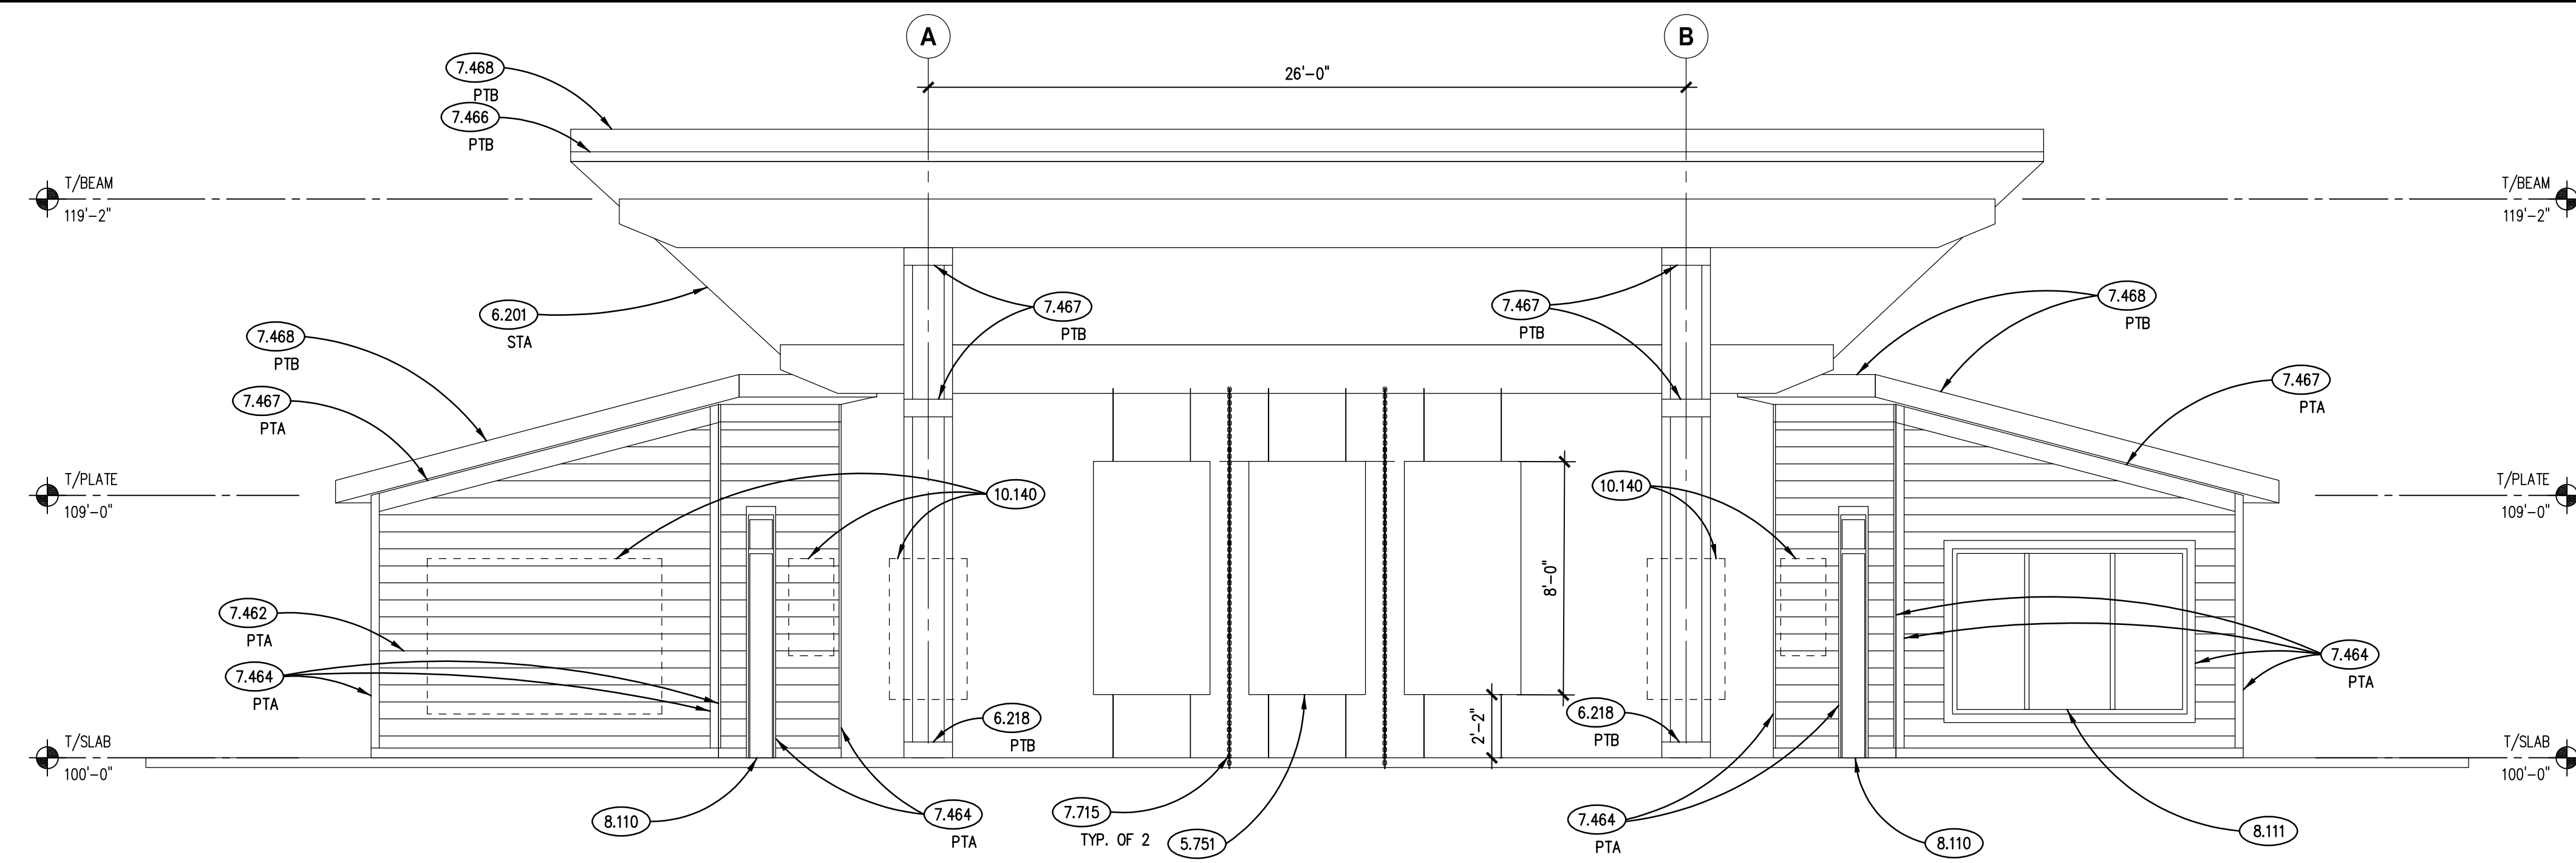

**NORTH ELEVATION**

SCALE: 1/4" = 1'-0"

1

**GENERAL NOTES**

- 1. REFER TO DRAWING G100 FOR PROJECT GENERAL NOTES.

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CHECKED	CJH
APPROVED	CJH

SHEET TITLE

EXTERIOR BUILDING ELEVATIONS


SHEET NUMBER

**A700**


### KEYNOTES

KEYNOTES ARE TYPICALLY NOT DUPLICATED WITHIN A GIVEN DETAIL. AN UNKEYNOTED ITEM IN A DETAIL IS THE SAME AS A KEYNOTED ITEM HAVING THE SAME APPEARANCE WITHIN THE SAME DETAIL.


- 5.751 DECORATIVE METAL PANEL: 4'-0" WIDE X 8'-0" TALL X 1/4" THICK STEEL PLATE, CNC CUT AND POWDERCOATED. EASED EDGES AND 1" RADIUS CORNERS; REFER TO ALLOWANCES AND SPECIFICATIONS.
- 5.752 DECORATIVE METAL PANEL ACCESSORY: 1/2" DIA. STUD-END PLUG-LOCK WIRE ROPE END FITTING CONNECTED TO SIMPSON HANGER OR CAST INTO CONCRETE PIER, STAINLESS STEEL; REFER ALLOWANCES AND SPECIFICATIONS.
- 5.753 DECORATIVE METAL PANEL ACCESSORY: CLOSED BODY CLEVIS-TO-WIRE TURNBUCKLE END FITTING; SLEEVE GRIP, STAINLESS STEEL; REFER TO ALLOWANCES AND SPECIFICATIONS.
- 5.754 DECORATIVE METAL PANEL ACCESSORY: REINFORCED CABLE: 3/8" DIA. - 7 X 19 STRAND CORE WIRE ROPE ACCESSORY; REFER TO ALLOWANCES AND SPECIFICATIONS.
- 6.218 FINISH CARPENTRY: CELLULAR PVC TRIM: 1/2" x 7.25" (ACTUAL); REFER TO SPECIFICATIONS.
- 7.310 ASPHALT SHINGLE ROOFING SYSTEM; REFER TO SPECIFICATIONS.
- 7.462 FIBER CEMENT SIDING: 5/8" THK. HORIZONTAL V-GROOVE LAP SIDING; 7" EXPOSURE; PRIMED. REFER TO SPECIFICATIONS.
- 7.464 FIBER CEMENT SIDING: 3.5" X 5/4" TRIM BOARD; PRIMED.
- 7.467 FIBER CEMENT SIDING: 7.25" X 5/4" TRIM BOARD; PRIMED.
- 7.468 FIBER CEMENT SIDING: 9.25" X 5/4" TRIM BOARD; PRIMED.
- 7.712 METAL GUTTER: MATERIAL: 6 INCH K-OSEE PROFILE; THICKNESS AND FINISH AS SPECIFIED.
- 7.713 METAL DOWNSPOUT: MATERIAL: 3 INCH X 4 INCH RIBBED; THICKNESS AND FINISH AS SPECIFIED.
- 7.715 METAL DOWNSPOUT ACCESSORY: RAIN CHAIN: DOUBLE LOOPS RAIN CHAIN, BRONZE COLOR; REFER TO SPECIFICATIONS.
- 8.111 STEEL WINDOW FRAME: REFER TO DOOR, FRAME AND BORROWED LIGHT SCHEDULE.
- 10.140 SIGNAGE: INTERPRETIVE DISPLAY TYPE; REFER TO ALLOWANCES.

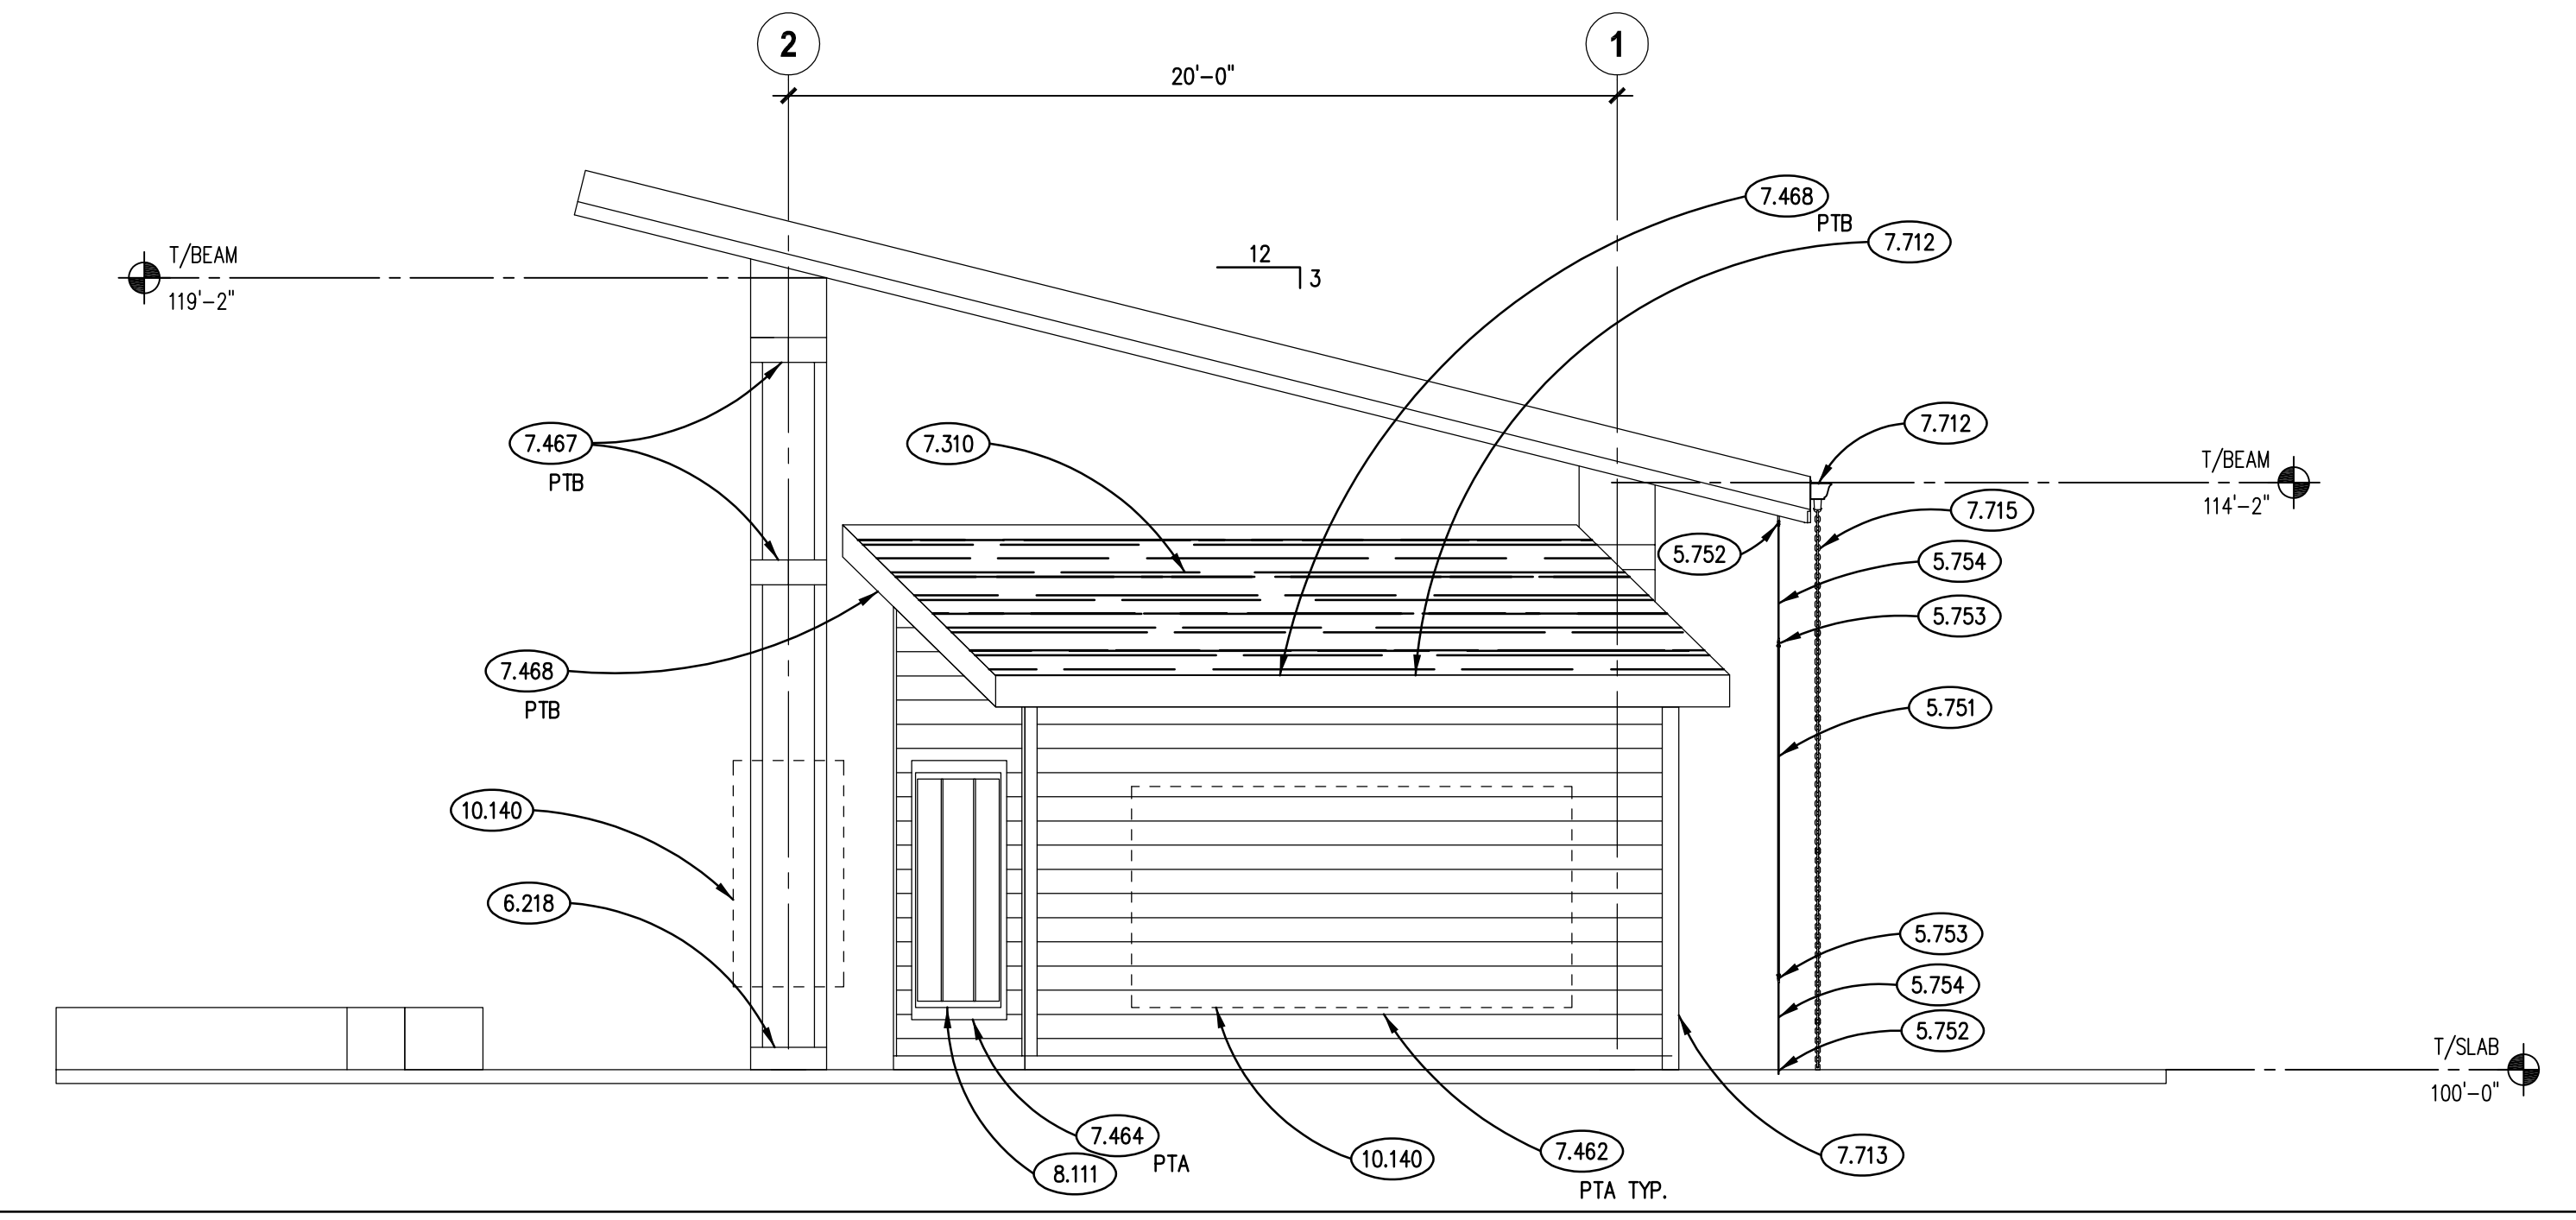

**WEST ELEVATION** ③  
SCALE: 1/4" = 1'-0"

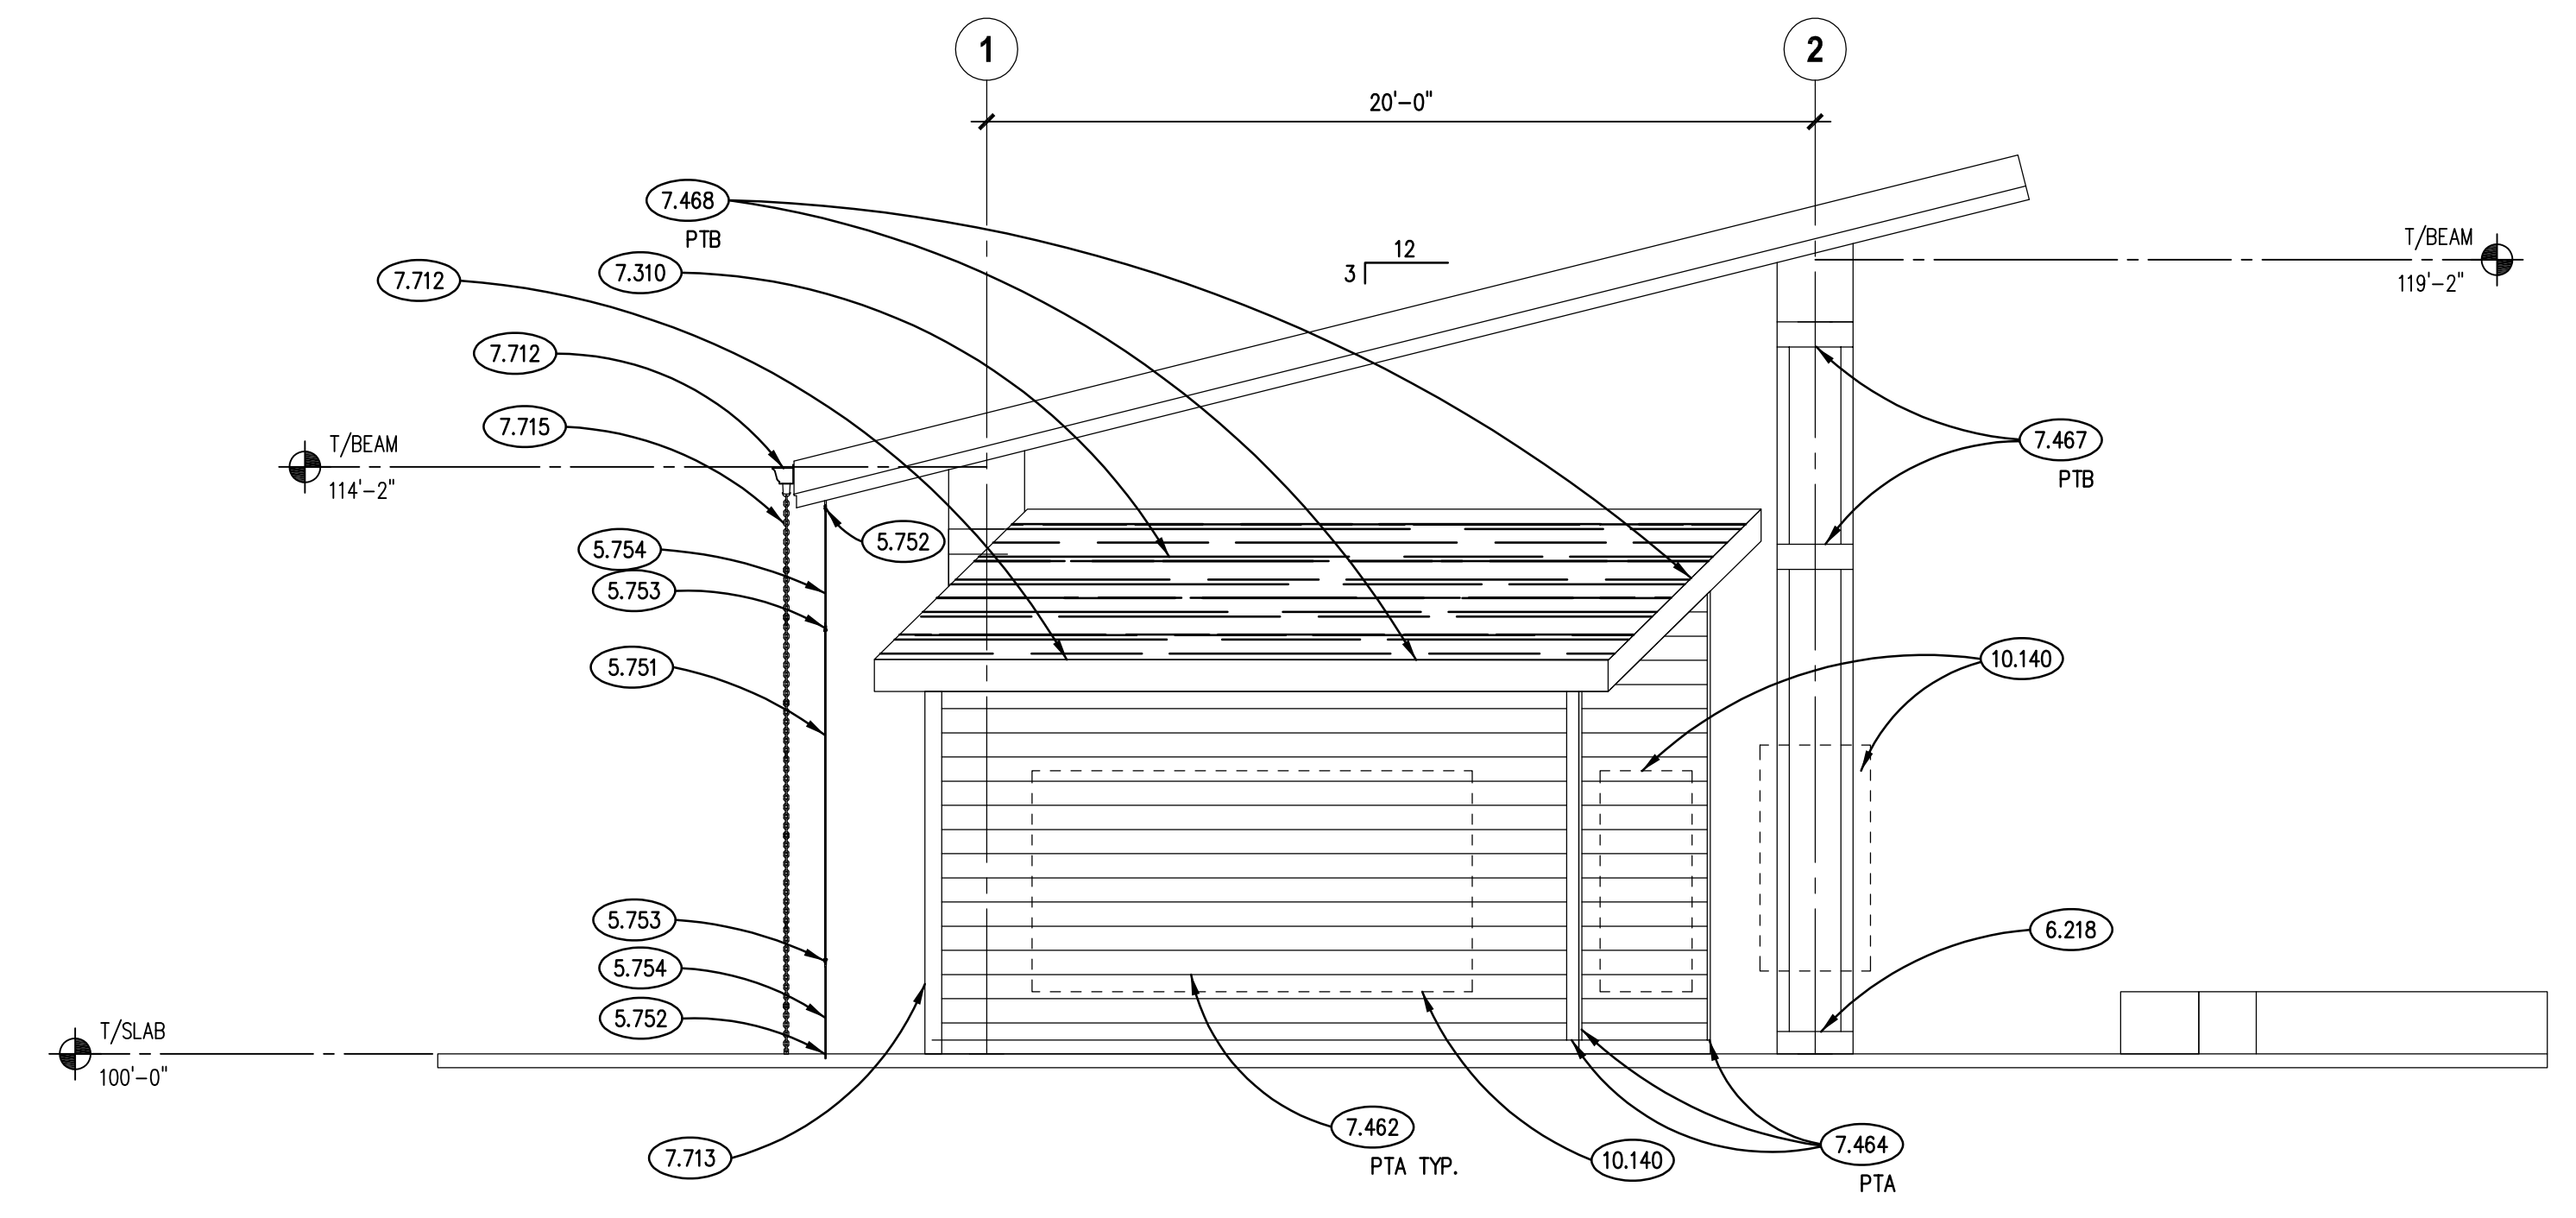

**EAST ELEVATION** ②  
SCALE: 1/4" = 1'-0"

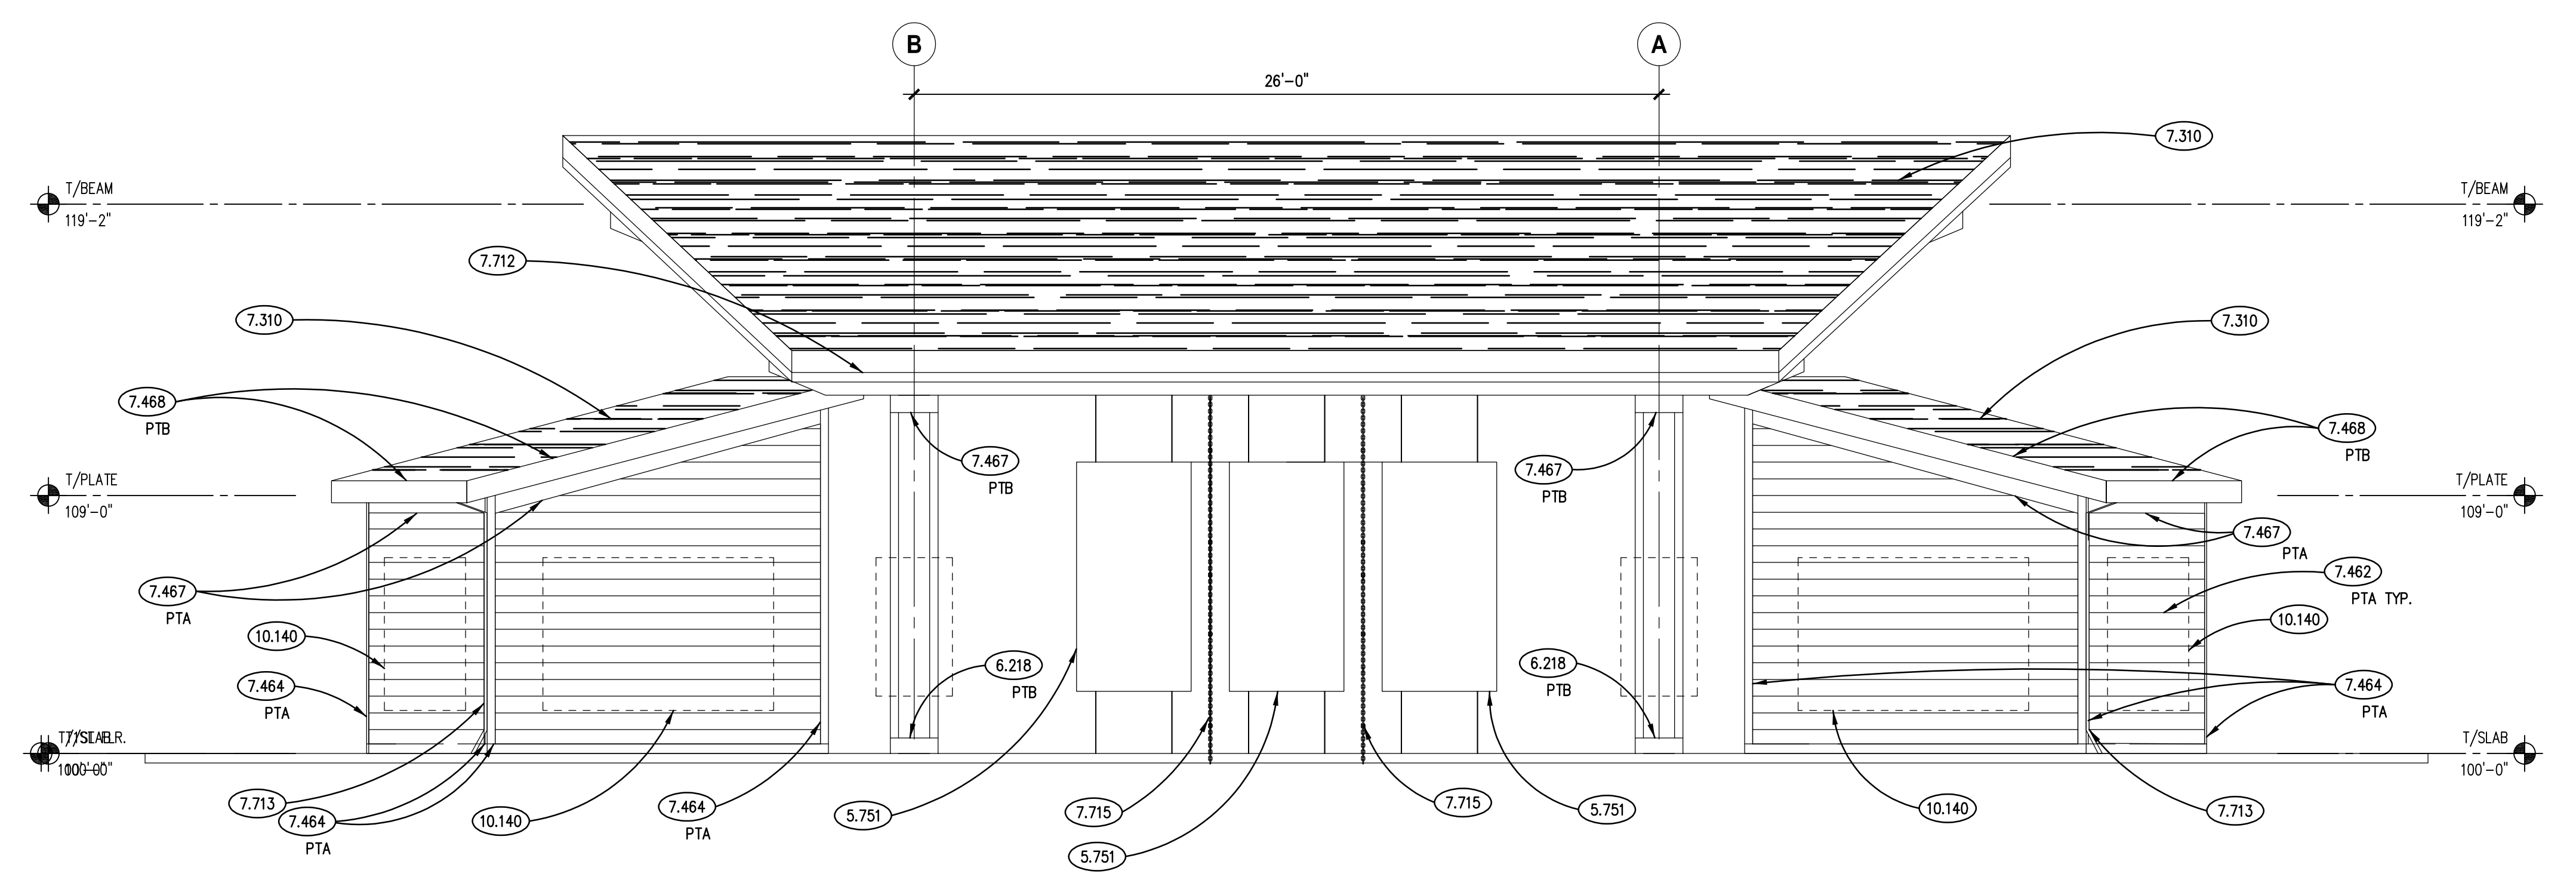

**SOUTH ELEVATION** ①  
SCALE: 1/4" = 1'-0"

### GENERAL NOTES

1. REFER TO DRAWING G100 FOR PROJECT GENERAL NOTES.

**Kluber**  
Architects + Engineers

Kluber, Inc.  
Aurora, Illinois 60506  
Tel: 630.346.5213  
Bloomington, Illinois 61714  
Tel: 309.330.6400  
www.kluberinc.com


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PLANO, IL 60545

ISSUED	
OWNER REVIEW	
INITIAL BID DOCUMENTS	
JOB NO.	23-429-1495
DRAWN	SKF
CHECKED	CJH
APPROVED	CJH
SHEET TITLE	EXTERIOR BUILDING ELEVATIONS
SHEET NUMBER	<b>A701</b>

NOTE: SCALES DEPICTED ON THIS DRAWING ARE NOT CORRECT UNLESS PLOTTED SHEET SIZE IS 30 X 42 INCHES.

### DOOR AND FRAME SCHEDULE

ROOM NO.	ROOM NAME	DOOR NO.	QTY.	DOOR										FRAME				DETAILS			HDWR SET	FIRE RATING (MIN.)	REMARKS								
				W	H	THK.	TYPE	HAND	MAT.	STEEL DOORS		WOOD DOORS				FINISH	GLASS	TYPE	MAT.	GA.				FINISH	GLASS	HEAD	JAMB	SILL			
										GA.	MDL.	CORE	GRD.	CORE	VENEER														CUT	MATCH	
100	EAST SHED	100.1	1	3'-0"	7'-0"	1-3/4"	F	LHR	STL	16	2	PU	-	-	-	-	-	-	P2/P1B	-	1	STL	16	P2/P1B	L66	8/A1200	11/A1200	-	1	-	-
101	WEST SHED	101.1	1	3'-0"	7'-0"	1-3/4"	F	RHR	STL	16	2	PU	-	-	-	-	-	-	P2/P1B	-	1	STL	16	P2/P1B	L66	8/A1200	11/A1200	-	1	-	-
		101.2	2	4'-0"	7'-0"	1-3/4"	F	RHR	STL	16	1	HC	-	-	-	-	-	-	P2/P1B	-	2	STL	16	P2/P1B	-	-	12/A1200	-	2	-	-
		101.3	1	8'-2"	5'-8"	-	-	-	-	-	-	-	-	-	-	-	-	-	P2/P1B	-	3	STL	16	P2/P1B	L66	8/A1200	7/A1200	6/A1200	-	-	-

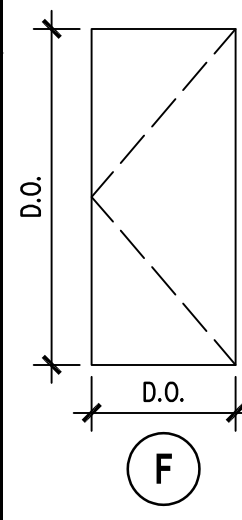

### DOOR TYPES


### DOOR HARDWARE SCHEDULE

SET NO.	HINGES	LOCK SET	EXIT DEVICE	CLOSER	HOLDER	STOP	THRES-HOLD	KICK-PLATE	MOP PLATE	WEATHER STRIPPING	SWEEP	PUSH/PULL	REMOV. MULLION	REMARKS
1	BUTT	YES	-	YES	W/CLOSER	W/CLOSER	YES	YES	-	YES	YES	-	-	1
2	BUTT	YES	-	-	-	WALL	-	-	-	-	-	-	-	2

### DOOR SCHEDULE REMARKS

1. PREP DOOR AND FRAME FOR ELECTRIC STRIKE.

### FRAME TYPES

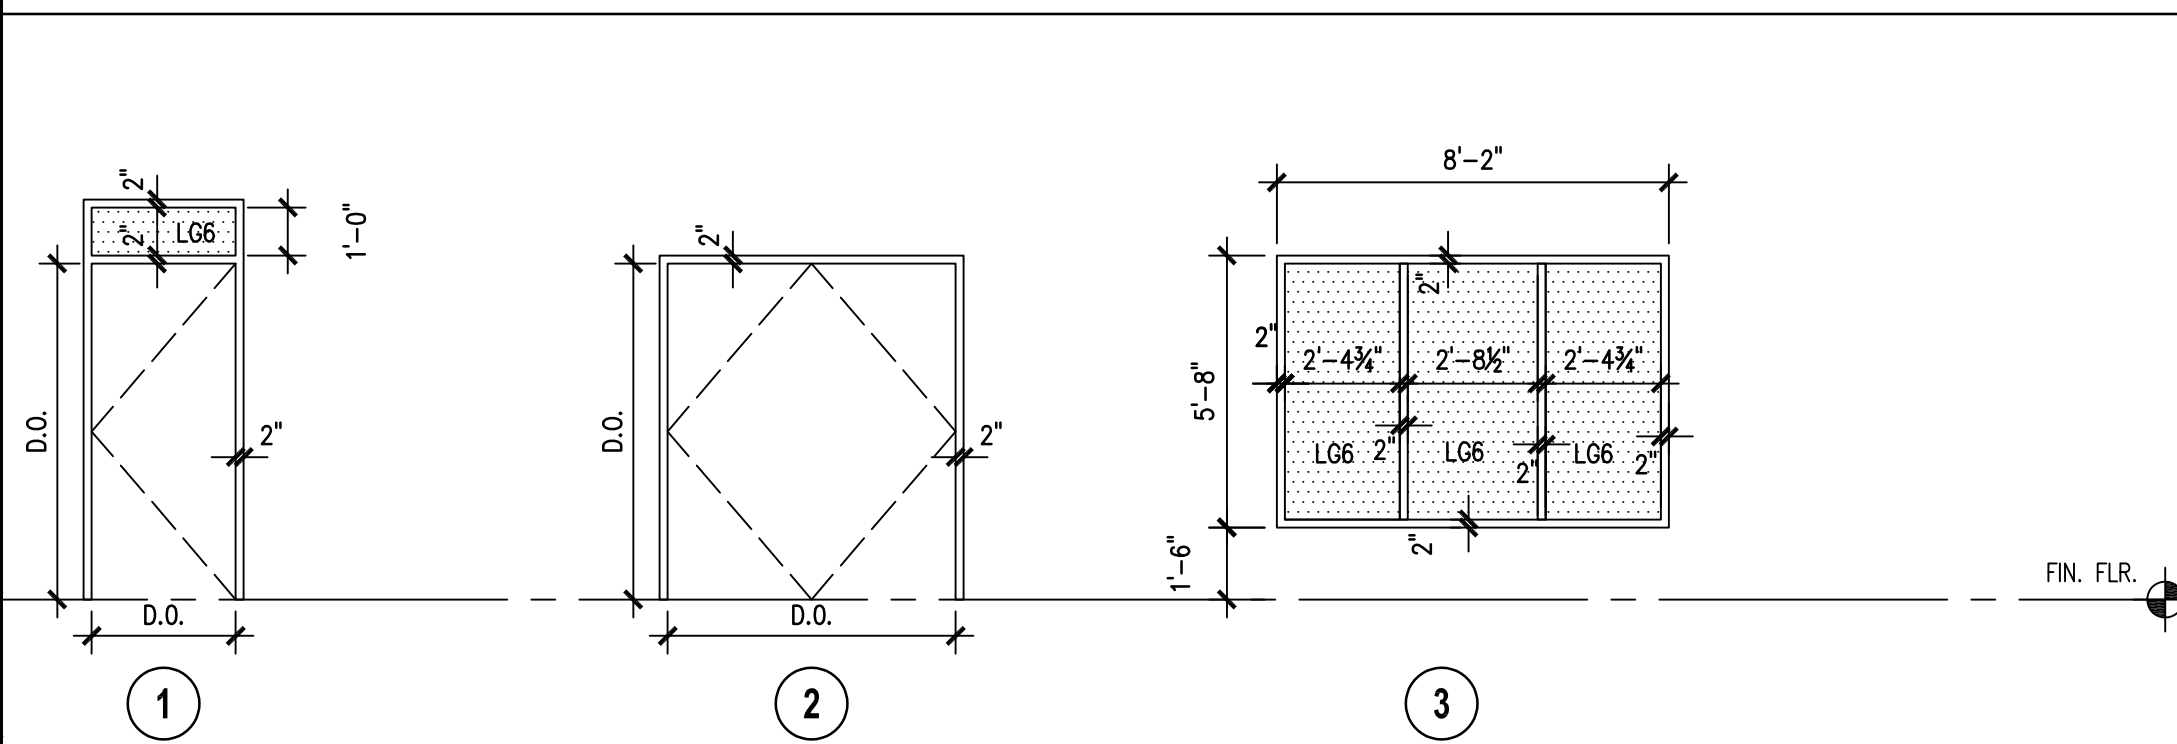

### HARDWARE SCHEDULE REMARKS

1. TYPICAL EXTERIOR SHED DOOR HARDWARE, STOREROOM FUNCTION LOCKSET.  
 2. DISPLAY CASE DOUBLE DOOR HARDWARE, DUMMY LEVER TRIM ON PULL SIDE OF EACH DOOR LEAF; ROLLER LATCH FOR EACH LEAF; PROVIDE WALL STOPS FOR BOTH LEAVES, MOUNT RHR LEAF WALL STOP TO INSIDE FACE OF EXTERIOR DOOR.

### DOOR SCHEDULE ABBREVIATIONS

DOOR / FRAME MATERIAL	STEEL DOOR GAGE	WOOD DOOR GRADE	WOOD DOOR VENEER CUTS
AL ALUMINUM	20 LEVEL 1 - STD. DUTY	P PREMIUM	PS PLAIN SLICED
STL STEEL	18 LEVEL 2 - HEAVY DUTY	C CUSTOM	QS QUARTER SLICED
WD WOOD	16 LEVEL 3 - EXTRA HVY. DUTY	E ECONOMY	RC RIFT CUT
SPECIAL DOOR TYPES	14 LEVEL 4 - MAXIMUM DUTY	WOOD DOOR CORE	R ROTARY CUT
AC ACCESSORY	STEEL DOOR MODEL	HC HONEYCOMB	
AP ACCESS PANEL	1 FULL FLUSH	MB MINERAL BOARD	WOOD DOOR VENEER MATCHING
DK DARKROOM REVOLVING	2 SEAMLESS	PCS 5-PLY PARTICLE BOARD	BK BOOK MATCH
HS OVERHEAD HIGH-SPEED	3 STILE & RAIL	SC SOUND-RATED	SL SLIP MATCH
OR OVERHEAD ROLLING	STEEL DOOR CORE		RAN RANDOM MATCH
OS OVERHEAD SECTIONAL	HC HONEYCOMB	WOOD DOOR VENEER	E END MATCH
RV REVOLVING	MB MINERAL BOARD	BW BIRCH - WHITE (SAPWOOD)	CON CONTINUOUS MATCH
SG OVERHEAD SECURITY GRILLE	PS POLYSTYRENE	HB PRIMED HARDBOARD	RUN RUNNING MATCH
DOOR / FRAME FINISHES	PU POLYURETHANE	HPLI DECORATIVE LAMINATE	BAL BALANCE MATCH
A ANODIZED	SS STEEL STIFFENERS	MW MAPLE - WHITE (SAPWOOD)	CB CENTER BALANCE MATCH
P PAINTED - SEE FIN. SCHED.		OR RED OAK	P PAIR MATCH
S STAINED - SEE FIN. SCHED.		OW WHITE OAK	S SET MATCH
		PO POPLAR	

### HARDWARE MOUNTING HEIGHTS

HARDWARE COMPONENT	PREFERRED MOUNTING HEIGHT FROM BOTTOM OF DOOR FRAME	ACCEPTABLE RANGE IF PREFERRED MOUNTING HEIGHT NOT POSSIBLE
LOCKSETS, LATCHSETS	39" TO CENTERLINE OF LEVER	38" TO 42"
EXIT DEVICES	39" TO CENTERLINE OF PUSH PAD	38" TO 42"
DEADBOLT LOCKS	46" TO CENTERLINE OF CYLINDER	30" TO 48"
PUSH PLATES	45" TO CENTERLINE OF PUSH PLATE	N/A
PULLS, COMBINATION PUSH/PULL BARS	42" TO CENTERLINE OF PULL/BAR	N/A
ROLLER LATCHES	45" TO CENTERLINE OF LATCH STRIKE	N/A

### COLOR CODE SCHEDULE

AREA	FINISH CODE	MATERIAL	MANUFACTURER	DESCRIPTION
WALLS	PTA	PAINT	SHERWIN WILLIAMS	COLOR: SW2803 ROOKWOOD TERRA COTTA
	PTB	PAINT	SHERWIN WILLIAMS	COLOR: SW6067 TURKISH COFFEE
CEILING	STA	STAIN/SEALER	PPG	CLEAR SATIN POLYURETHANE VARNISH REFER TO SPECIFICATIONS

### FINISH TYPES

AREA	FIN.	DESCRIPTION	AREA	FIN.	DESCRIPTION
FLOOR	F1	NOT USED	CEILING	C1	NOT USED
BASE	B1	NOT USED	WALLS	P1	LATEX - "EGGSHELL"
				P2	LATEX - "SEMI-GLOSS"
GLASS	L66	SECURITY GLAZING LAMINATED GLASS	P3	LATEX - "SATIN"	
			P4	NOT USED	
			P5	PREFINISHED: REFER TO SPECS.	

### GENERAL NOTES

1. REFER TO DRAWING G100 FOR PROJECT GENERAL NOTES.  
 2. REFER TO ELEVATIONS AND DETAILS FOR SPECIFIC FINISH LOCATIONS.

**Kluber**  
Architects + Engineers

Kluber, Inc.  
Aurora, Illinois 60506  
Tel: 630.346.1213  
Bloomington, Illinois 61704  
Tel: 309.330.0400  
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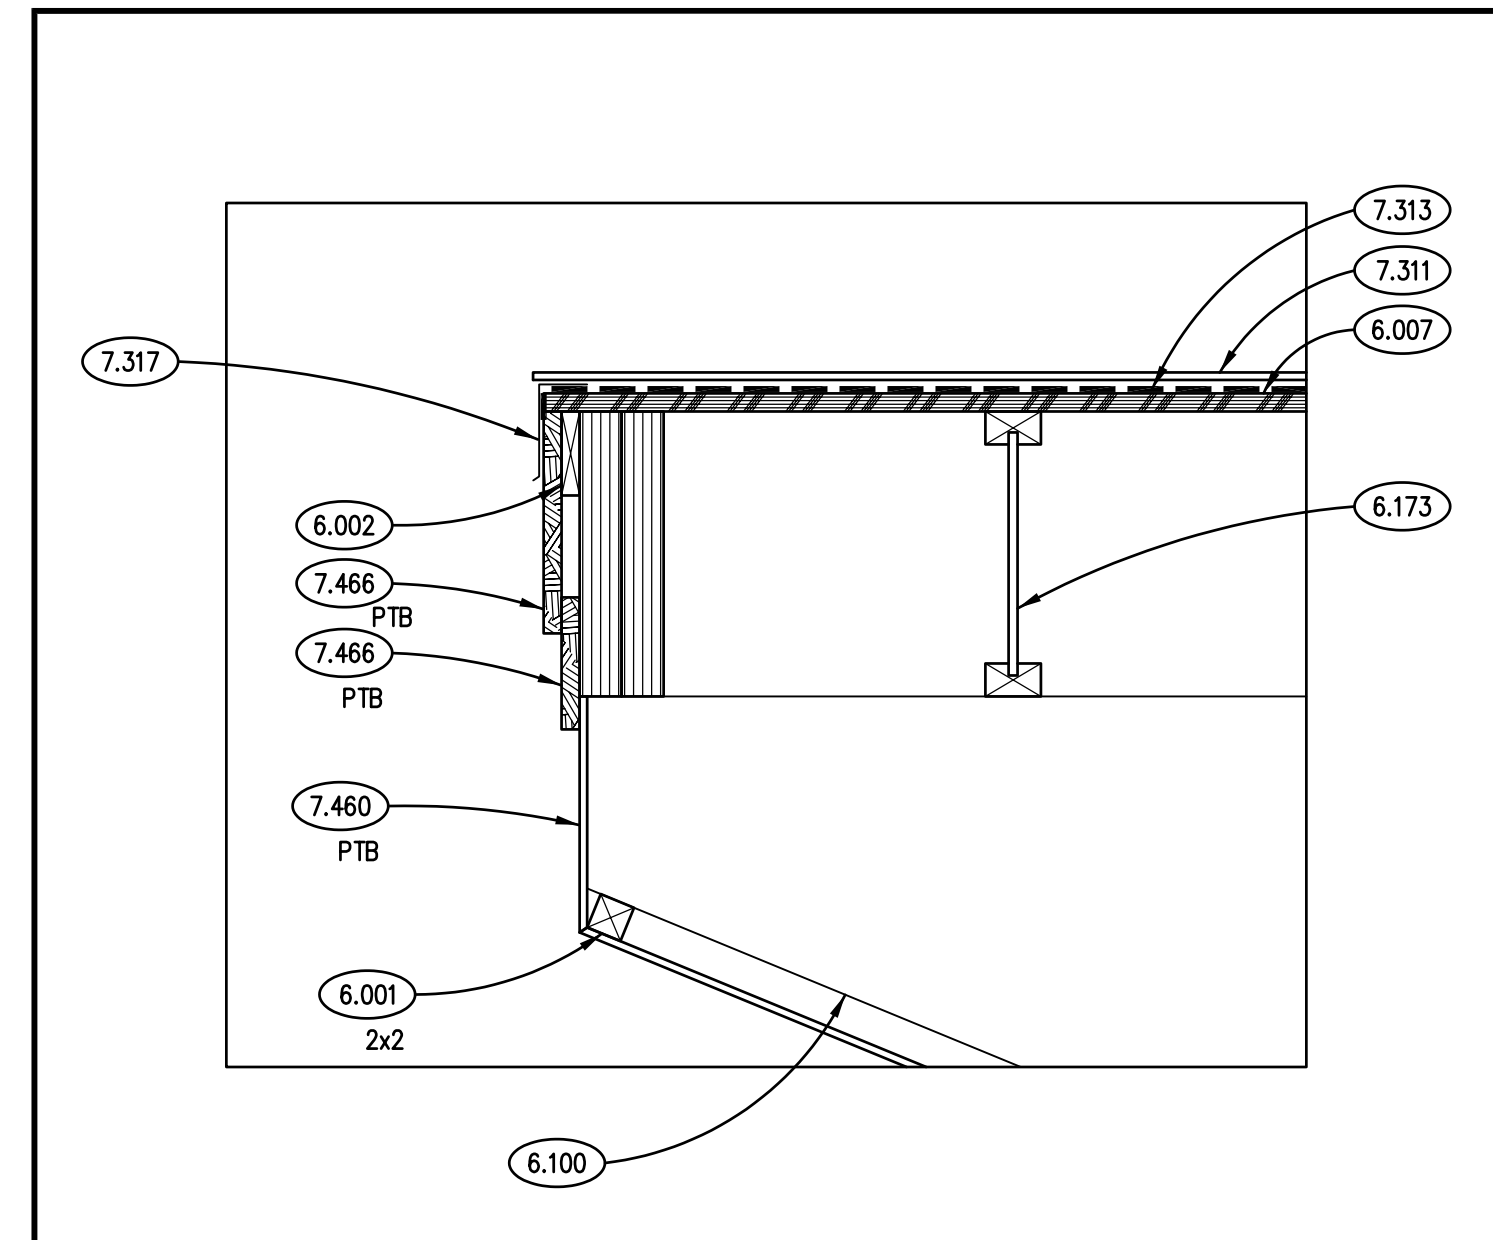
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DATE/24  
OWNER REVIEW  
DATE/24  
BID DOCUMENTS

JOB NO. 23-429-1495  
DRAWN SKF  
CHECKED CDH  
APPROVED CJH


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**DOOR, FRAME & HARDWARE SCHEDULES**

SHEET NUMBER


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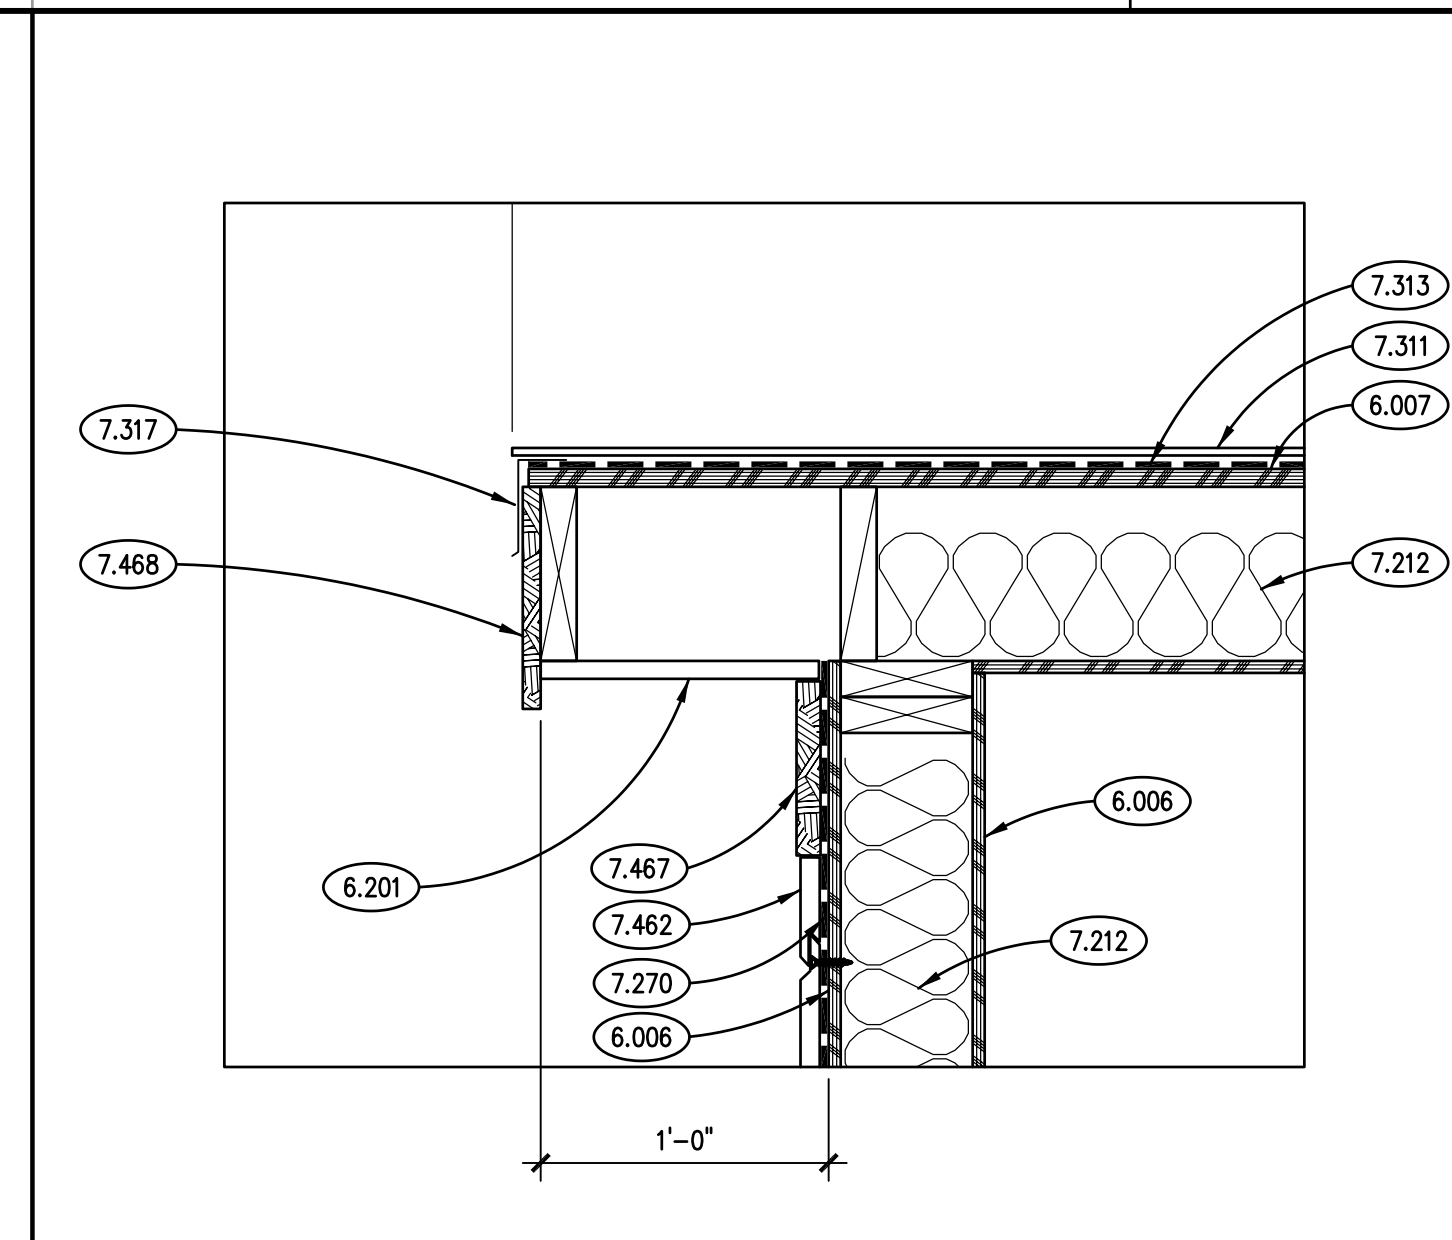
**CANOPY RAKE DETAIL**  
SCALE: 3" = 1'-0" **16**




**DOOR JAMB DETAIL**  
SCALE: 3" = 1'-0" **12**

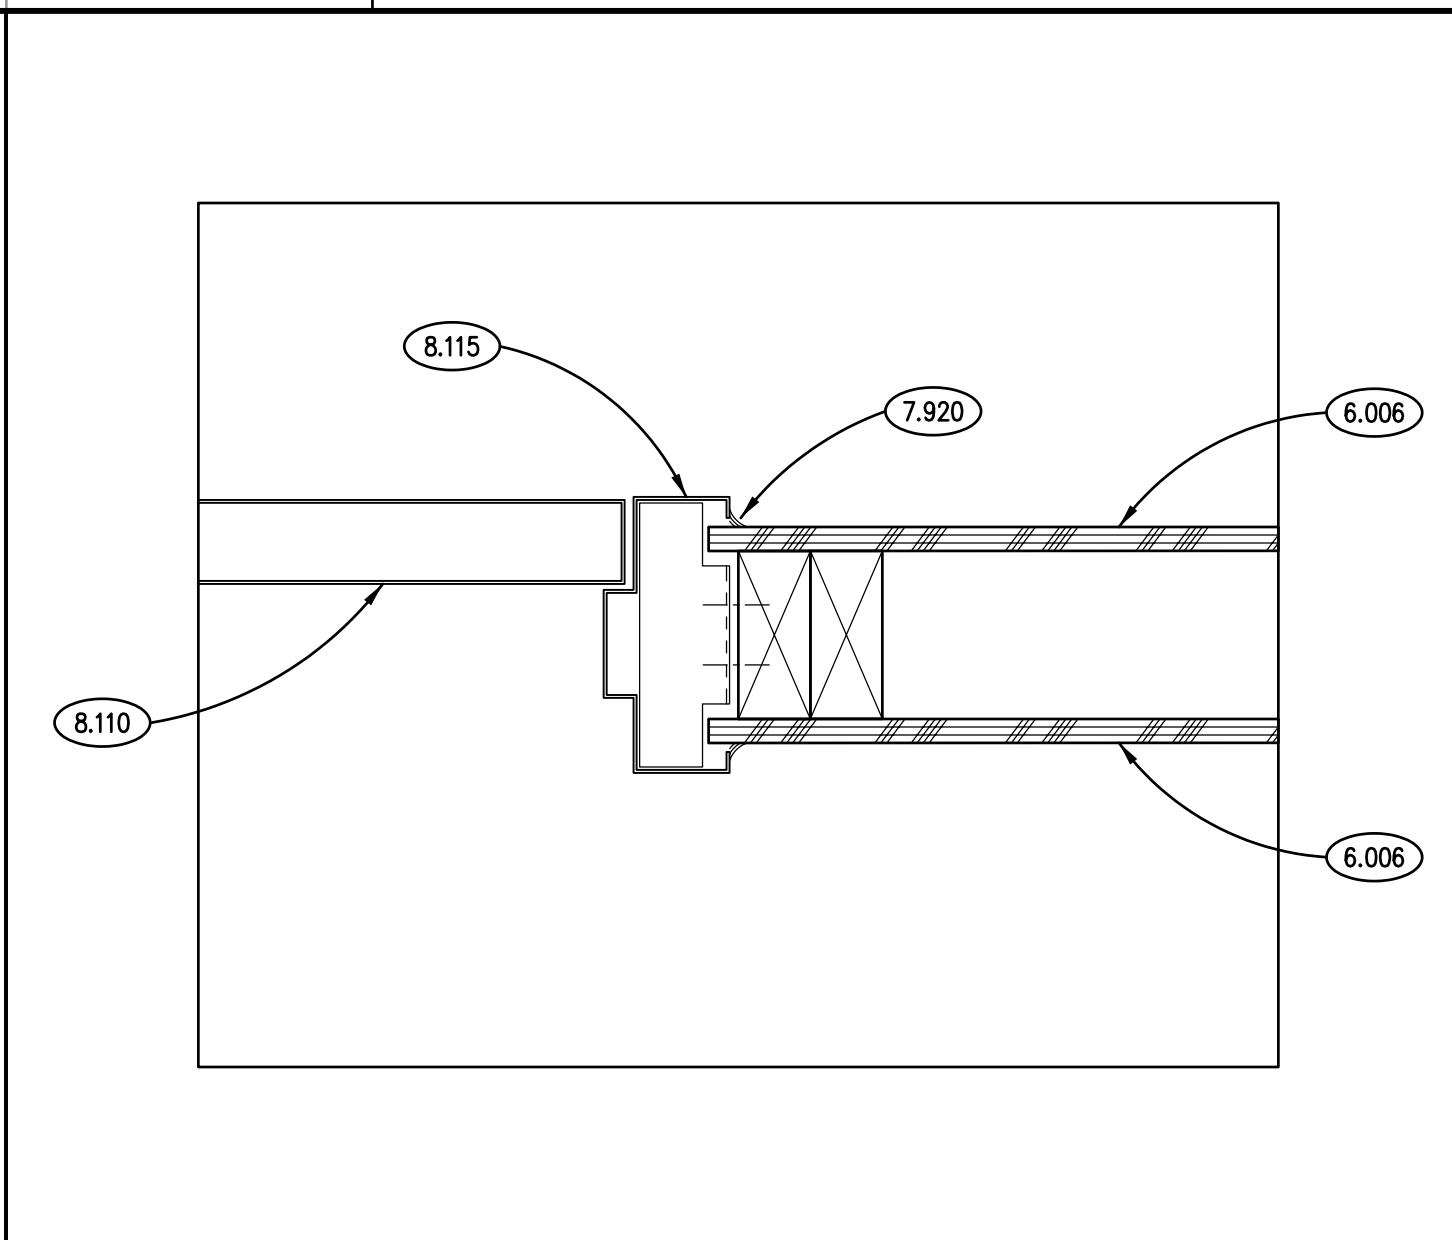


**TYPICAL HEAD DETAIL**  
SCALE: 3" = 1'-0" **8**

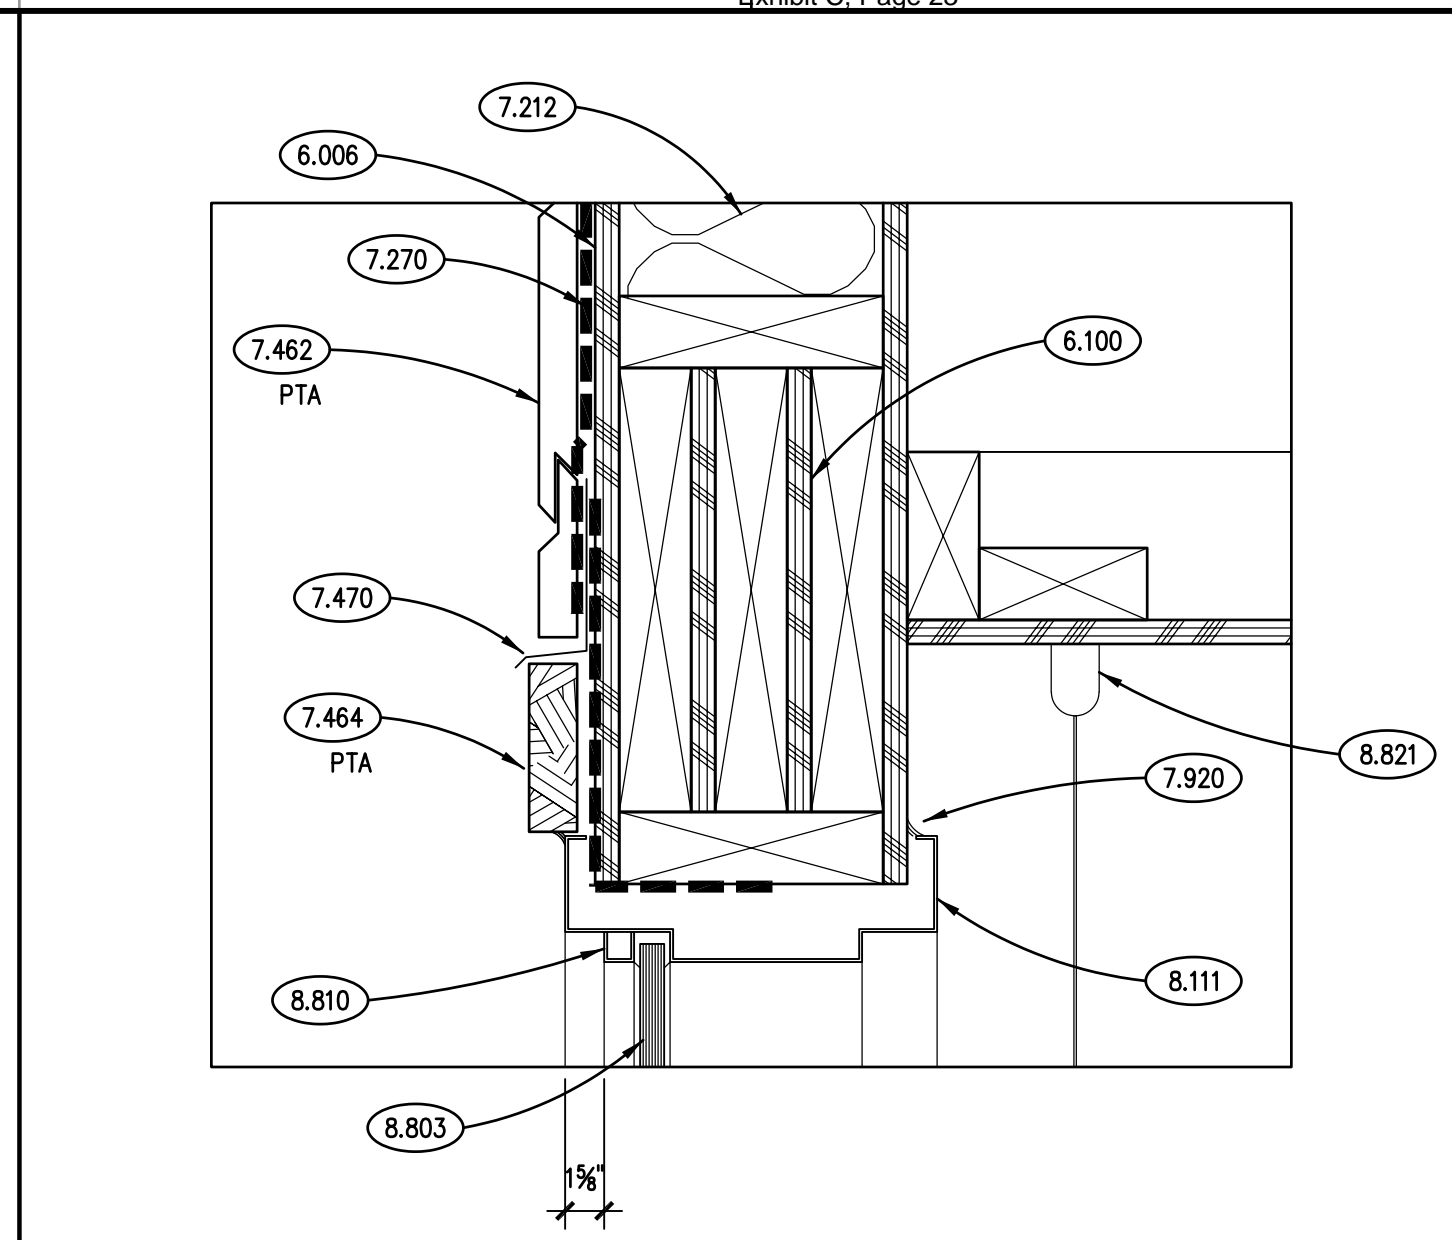


**ROOF RAKE DETAIL**  
SCALE: 1 1/2" = 1'-0" **4**

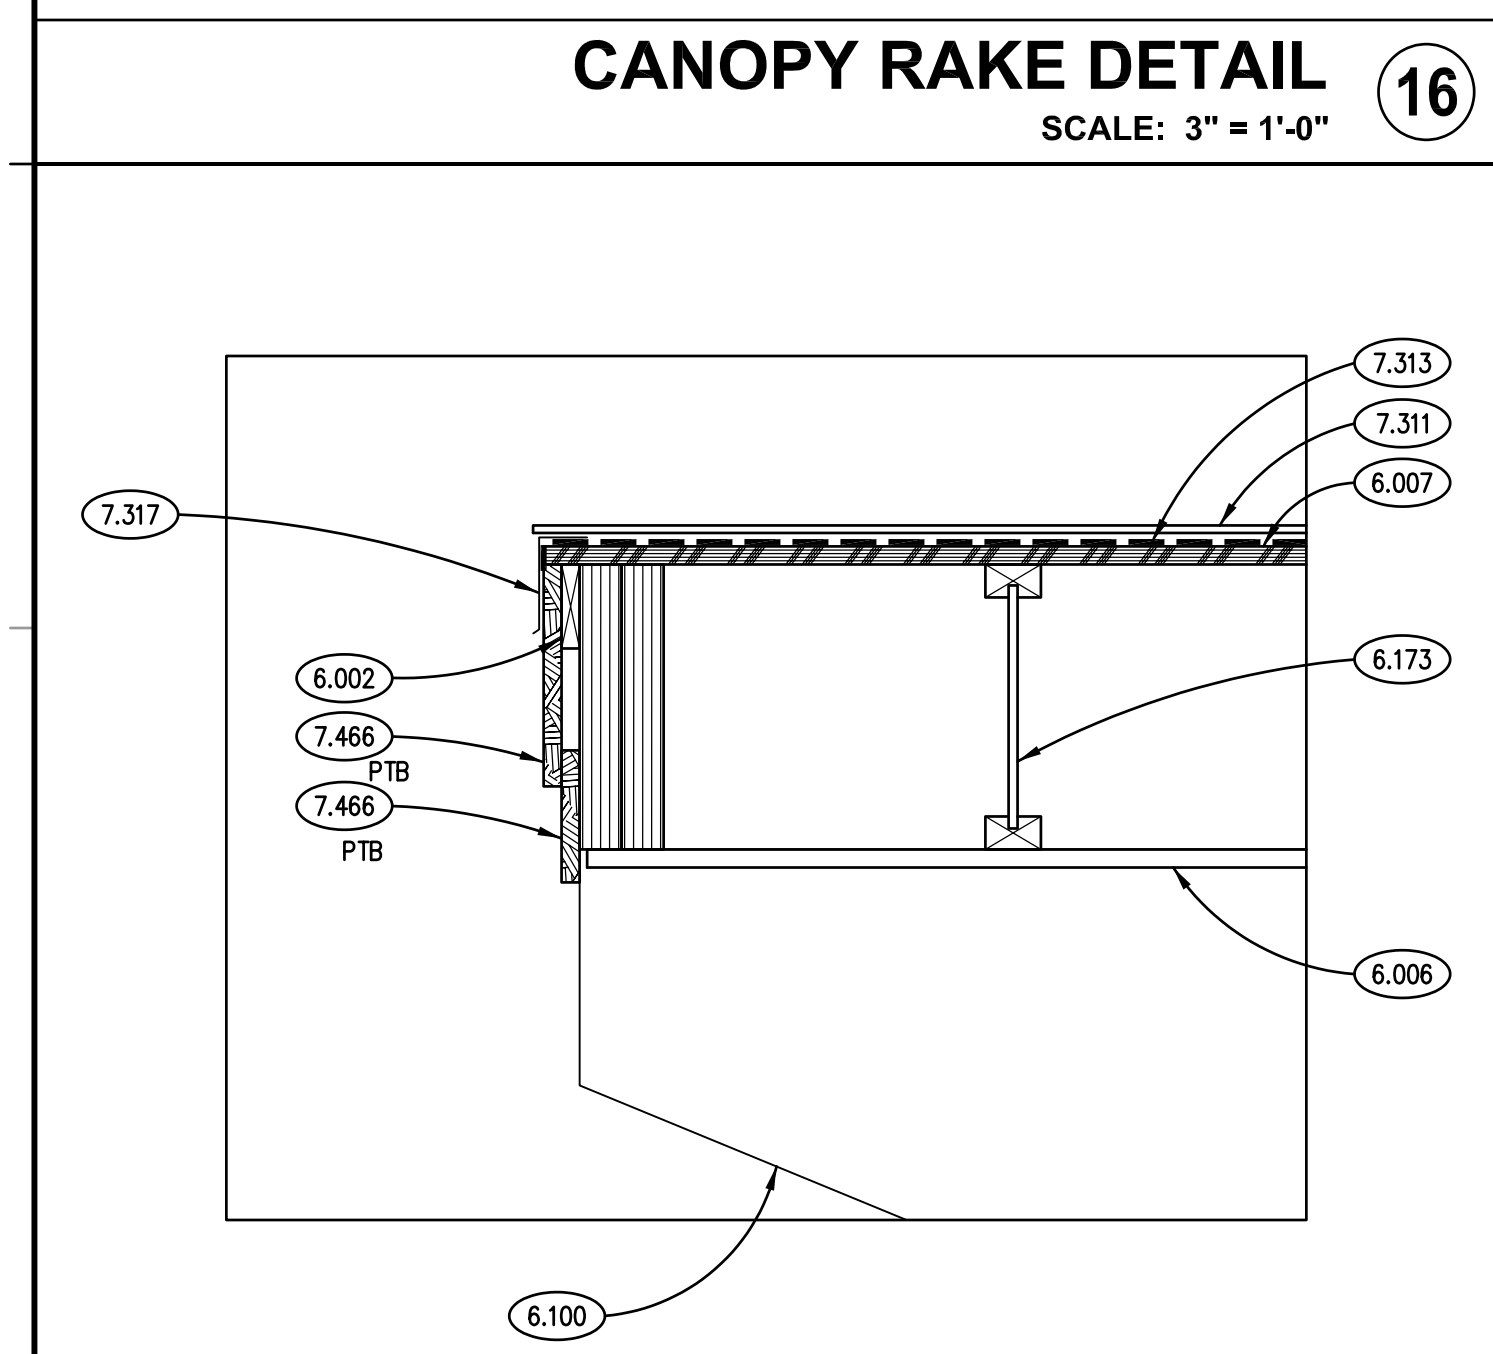


**CANOPY RAKE DETAIL**  
SCALE: 1 1/2" = 1'-0" **15**

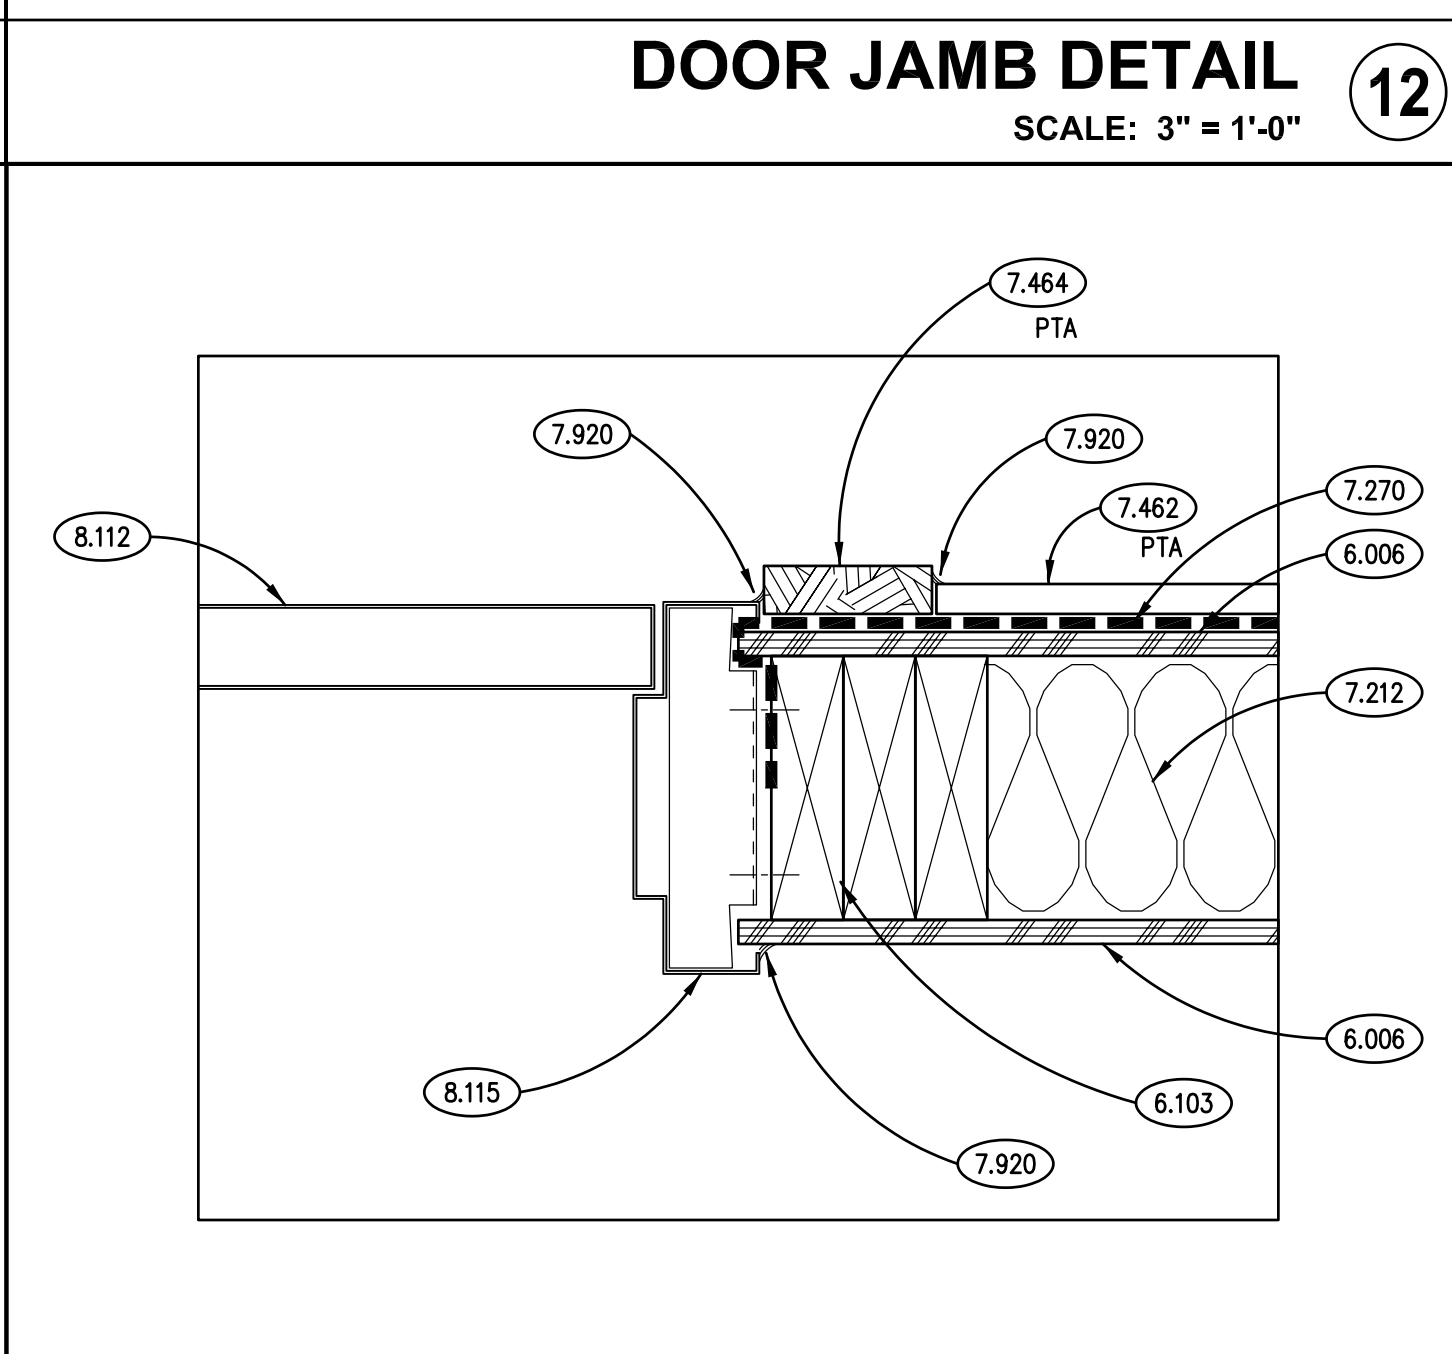


**DOOR JAMB DETAIL**  
SCALE: 3" = 1'-0" **11**

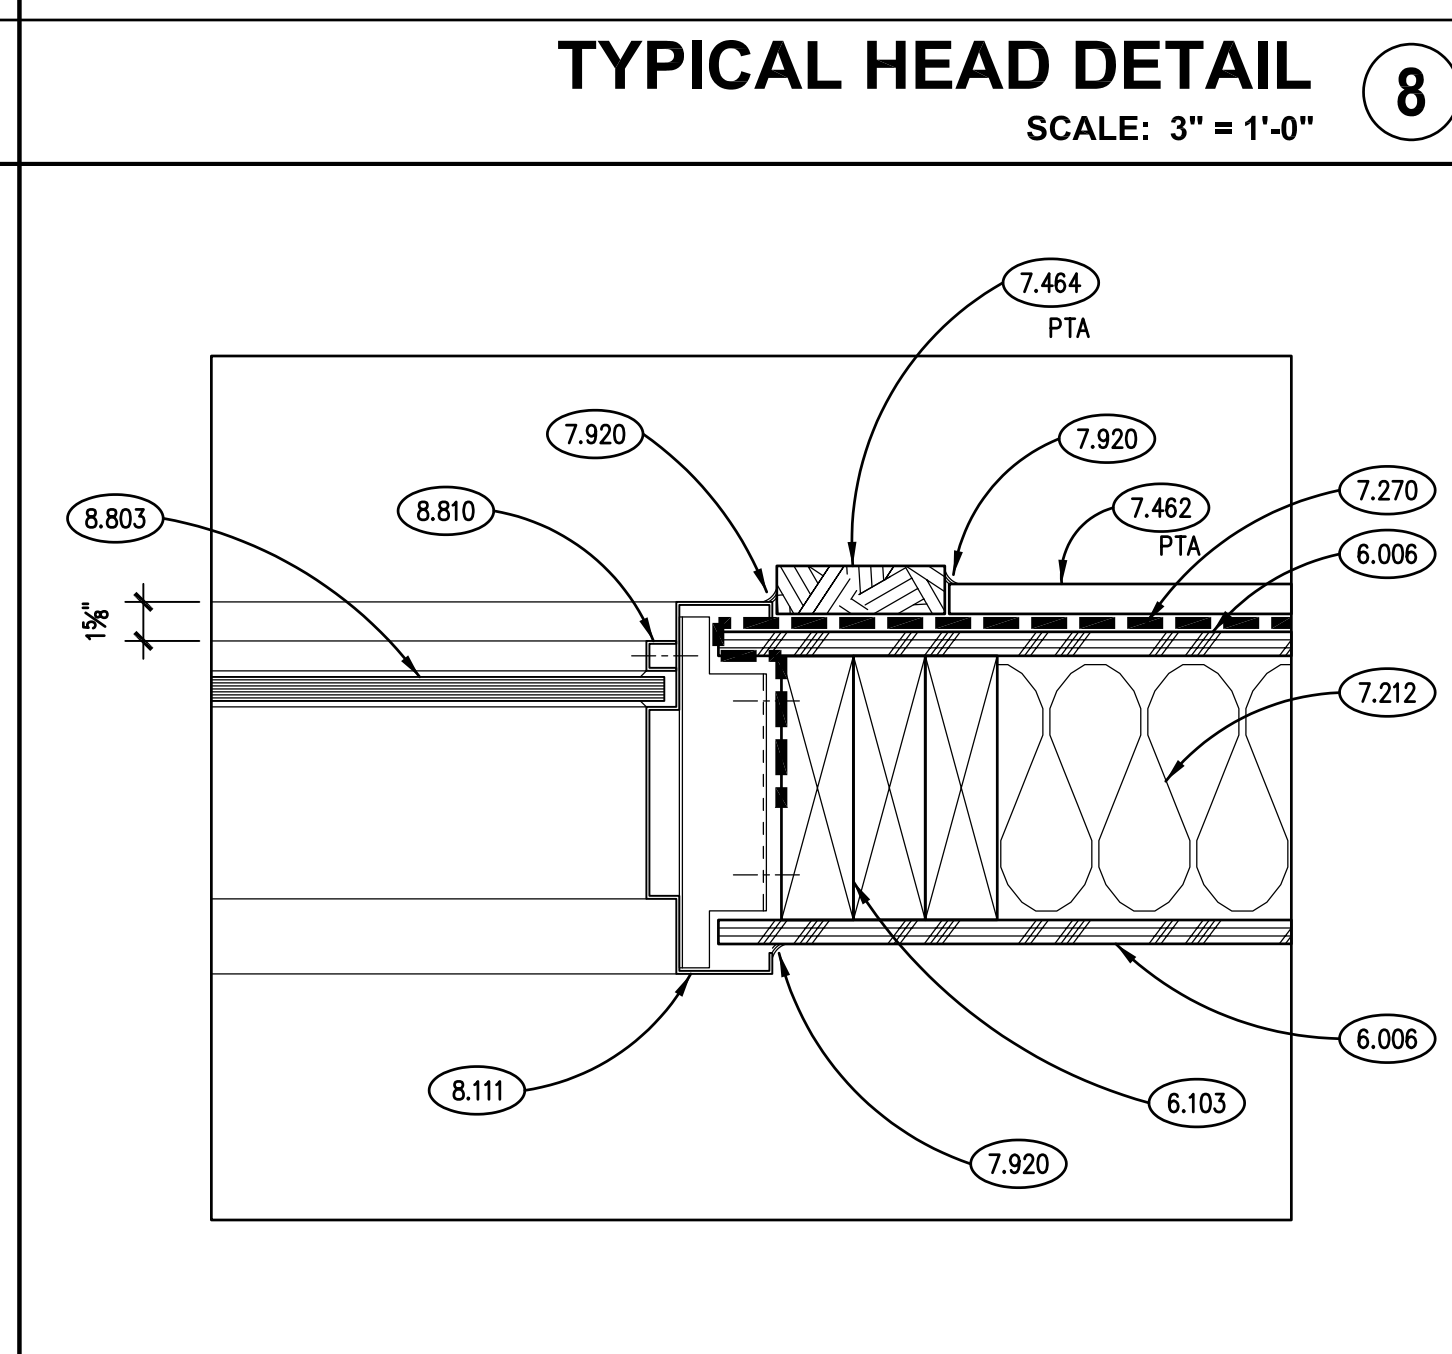


**WINDOW JAMB DETAIL**  
SCALE: 3" = 1'-0" **7**

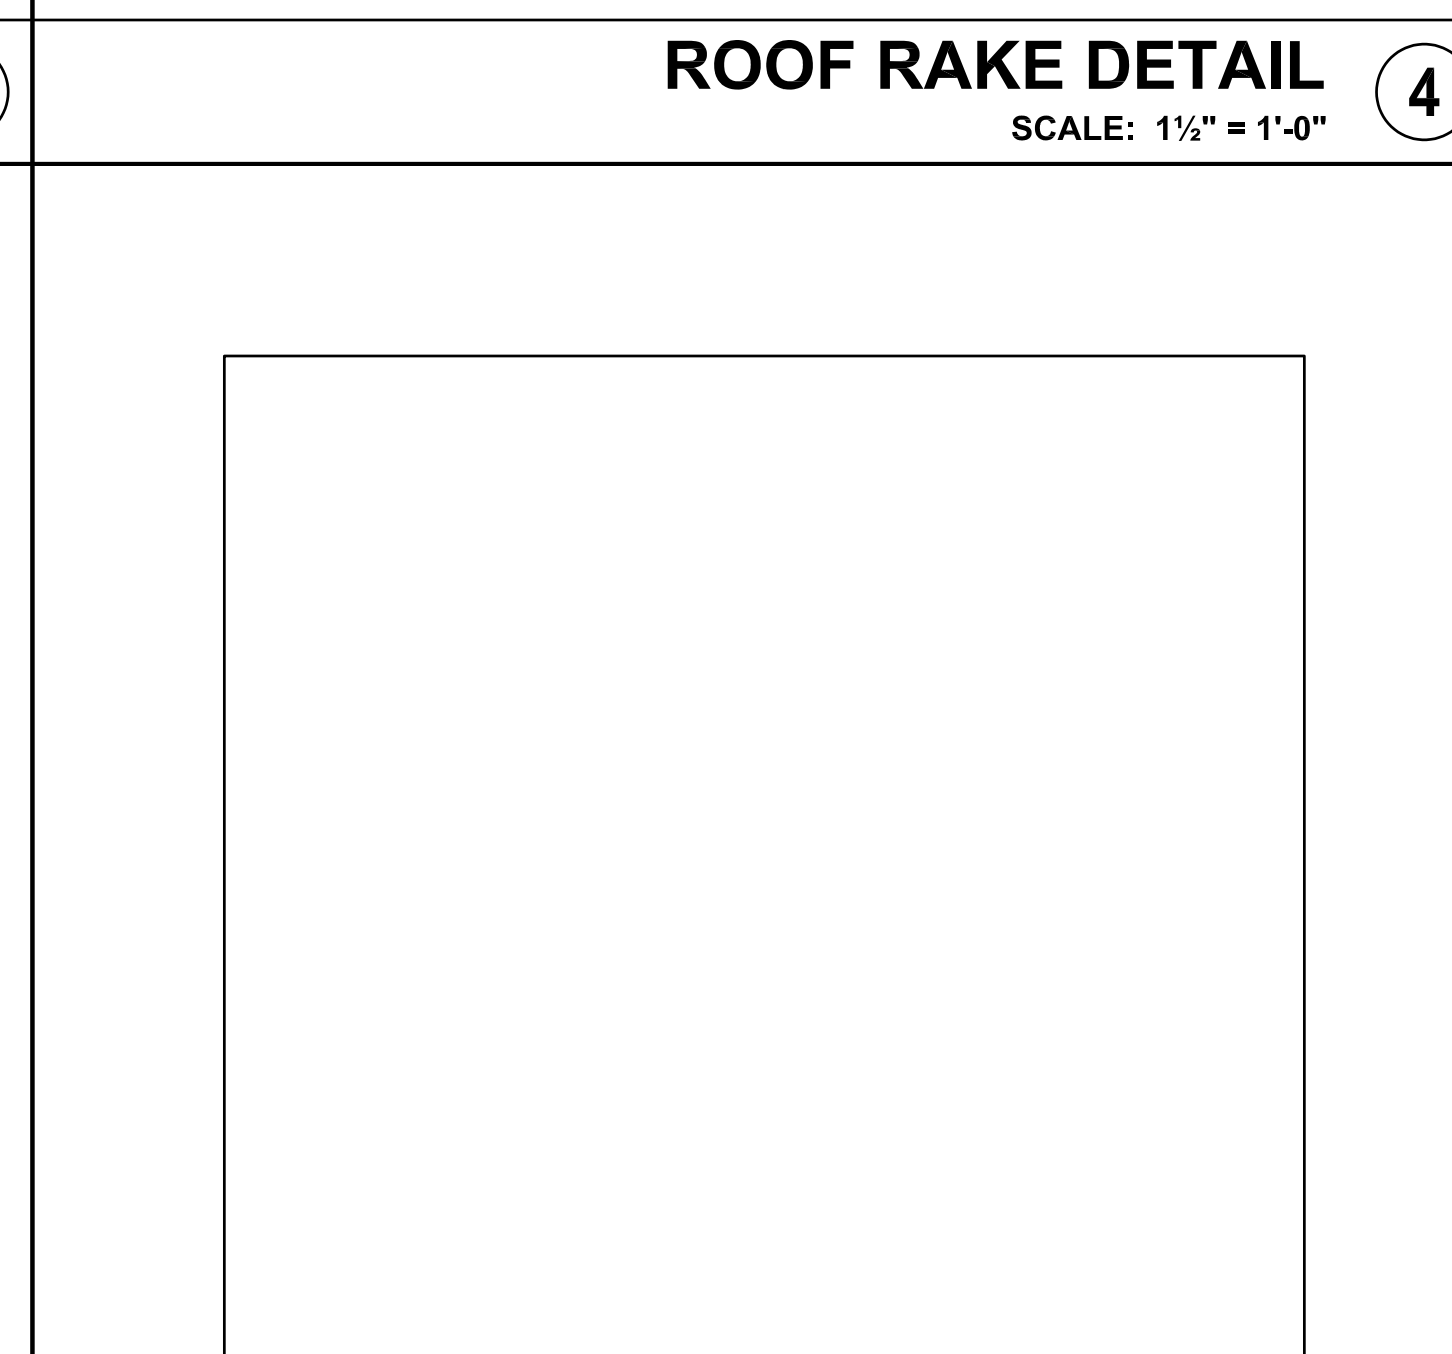


**WALL SECTION**  
SCALE: 3/4" = 1'-0" **3**

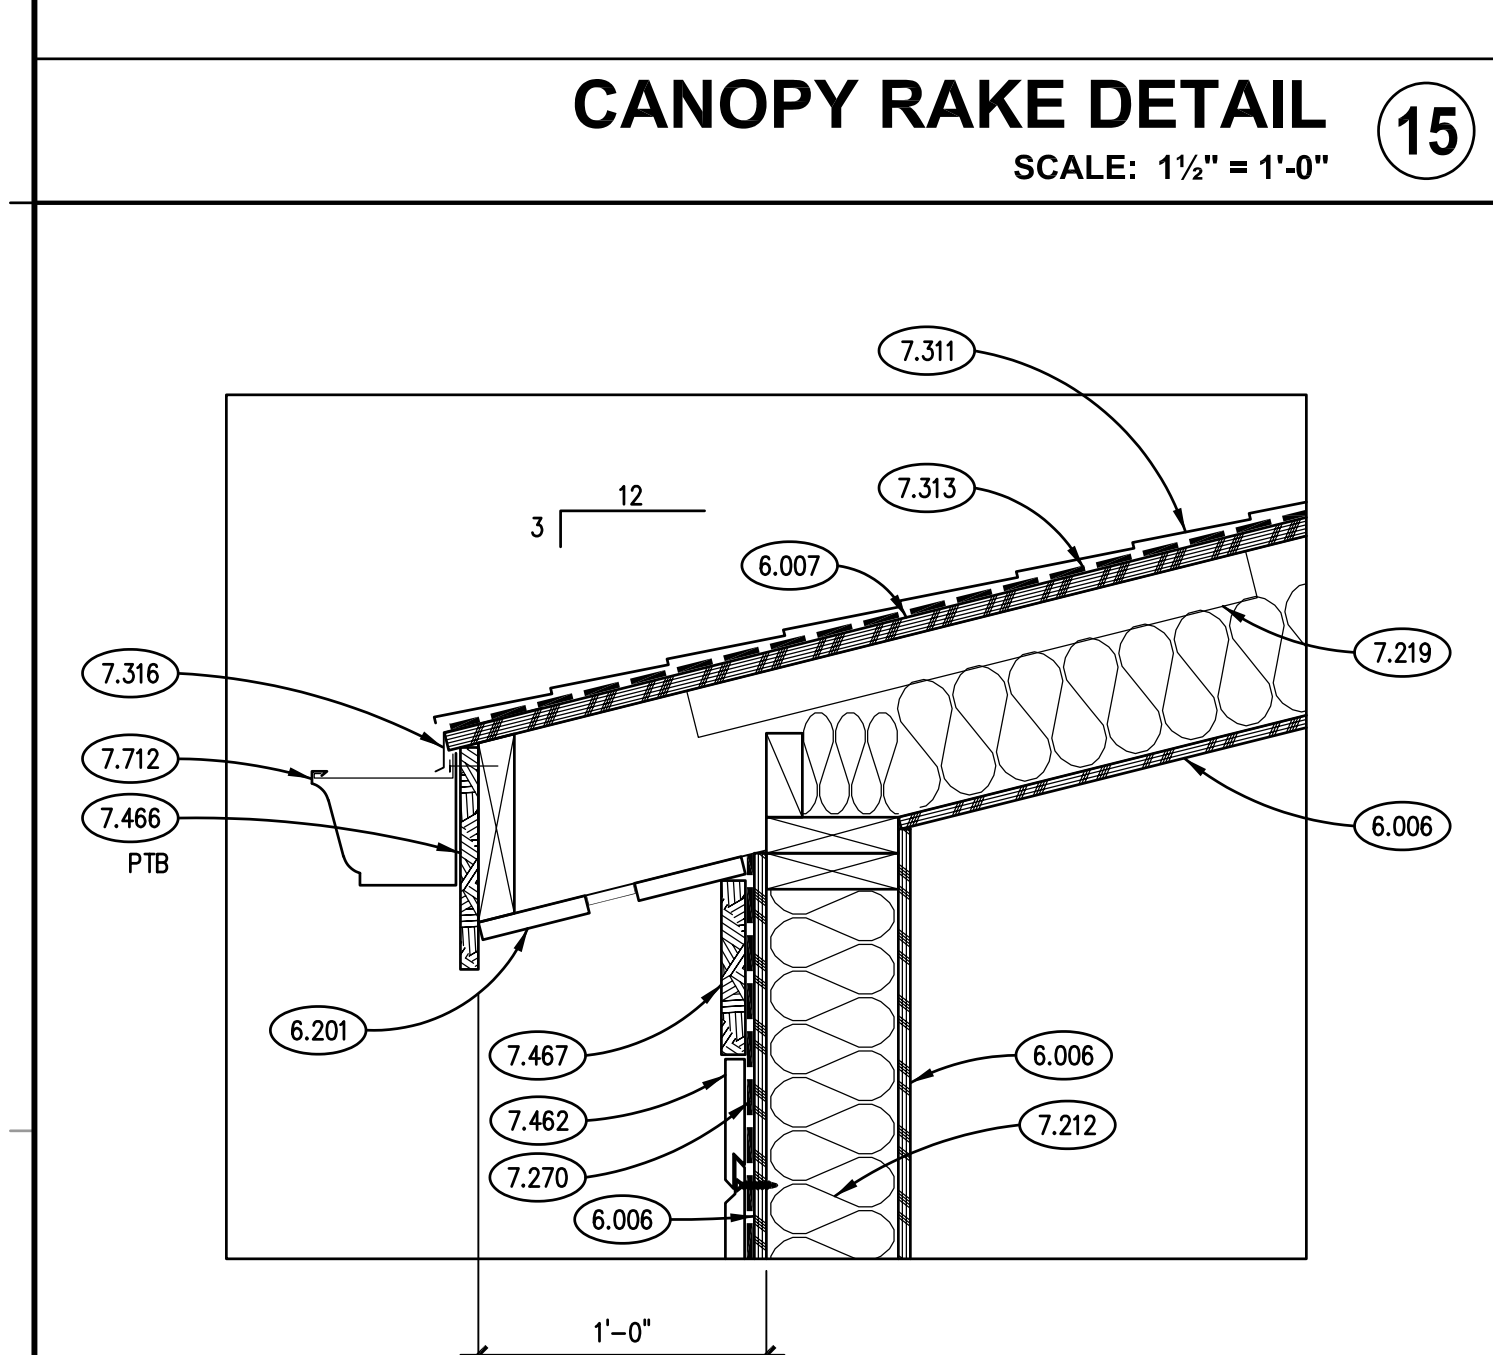


**SECTION DETAIL**  
SCALE: 1 1/2" = 1'-0" **14**

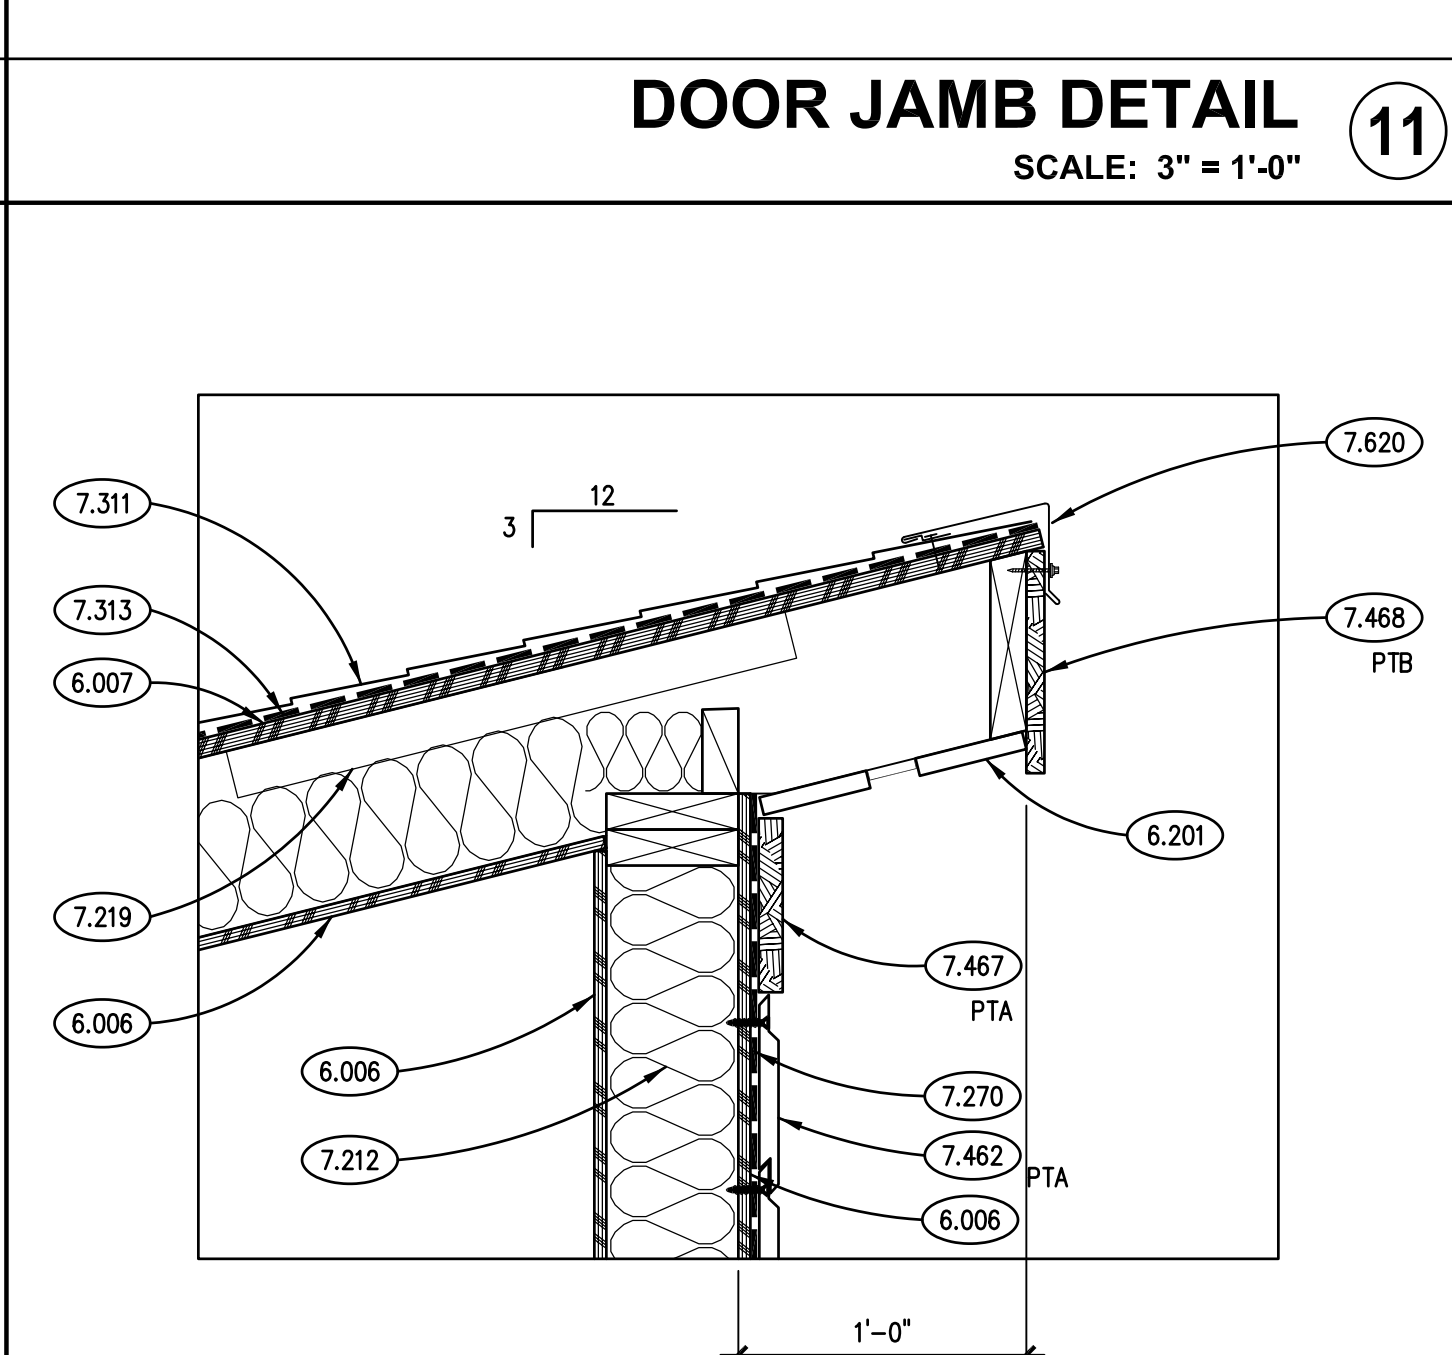


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SCALE: 1 1/2" = 1'-0" **10**

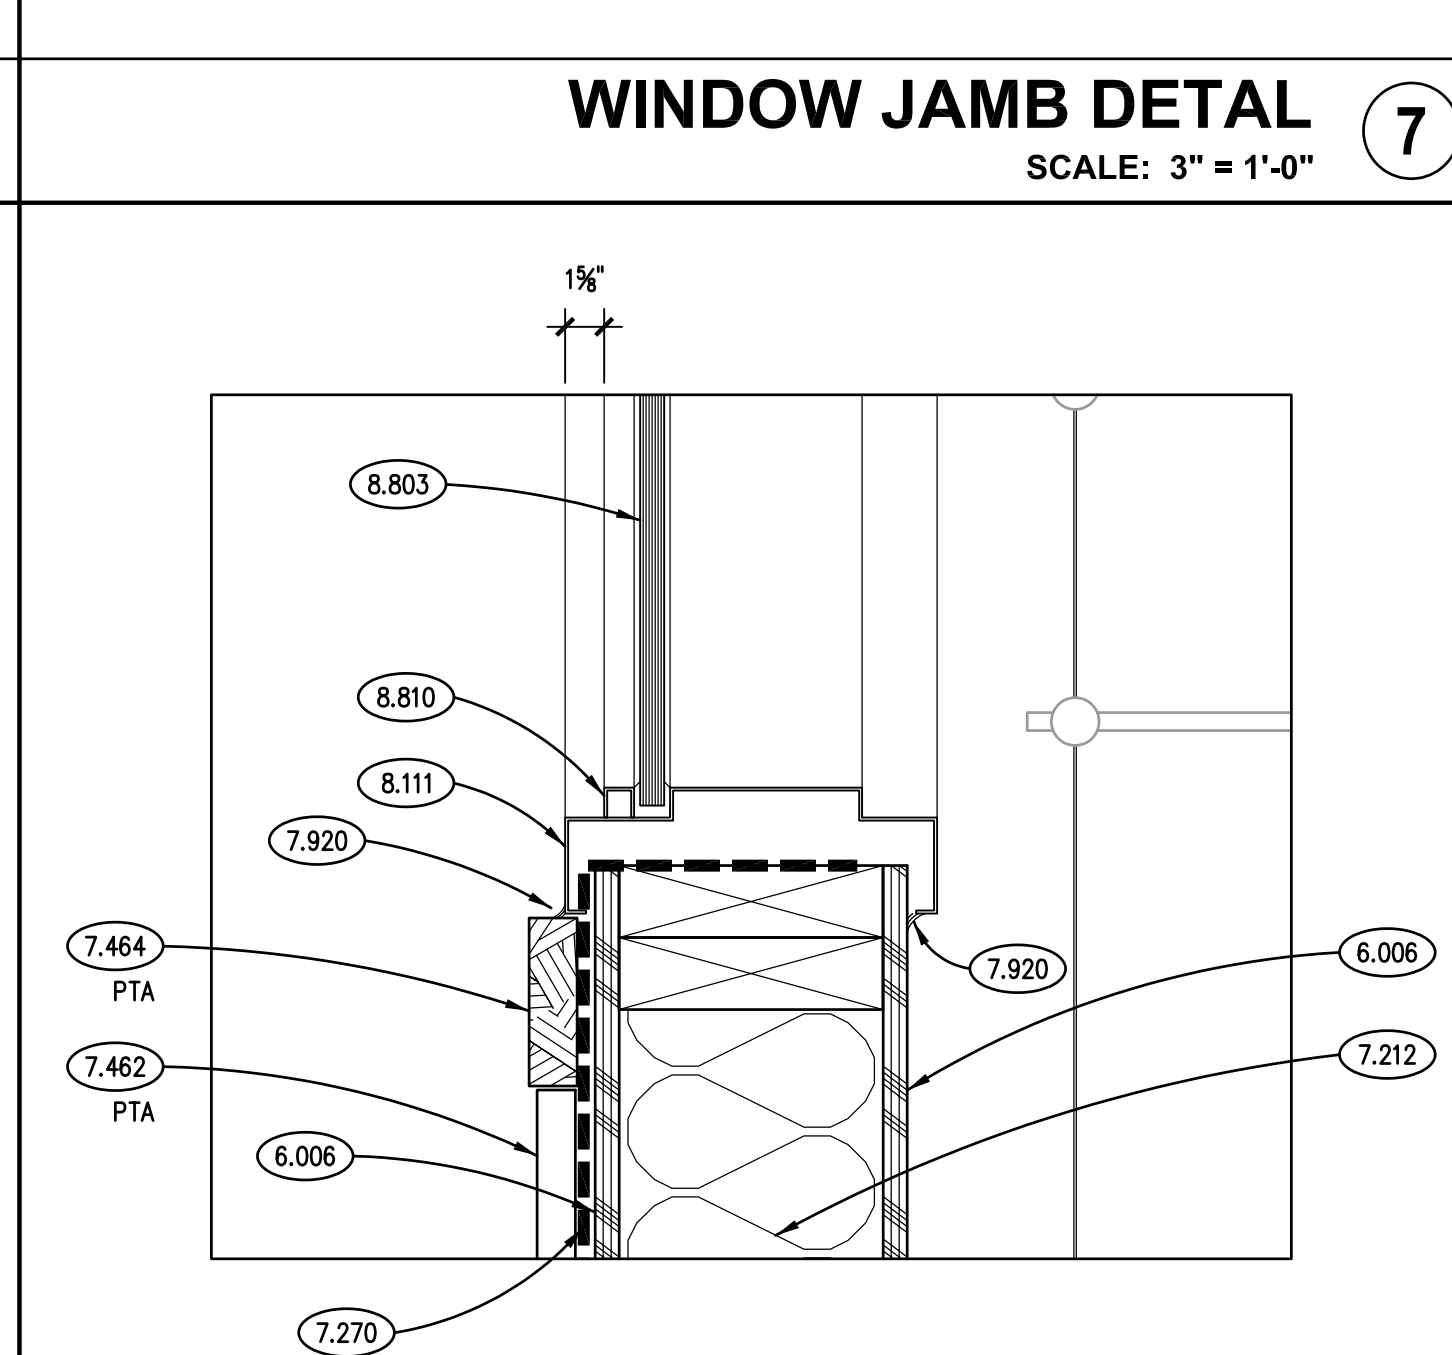


**WINDOW SILL DETAIL**  
SCALE: 3" = 1'-0" **6**

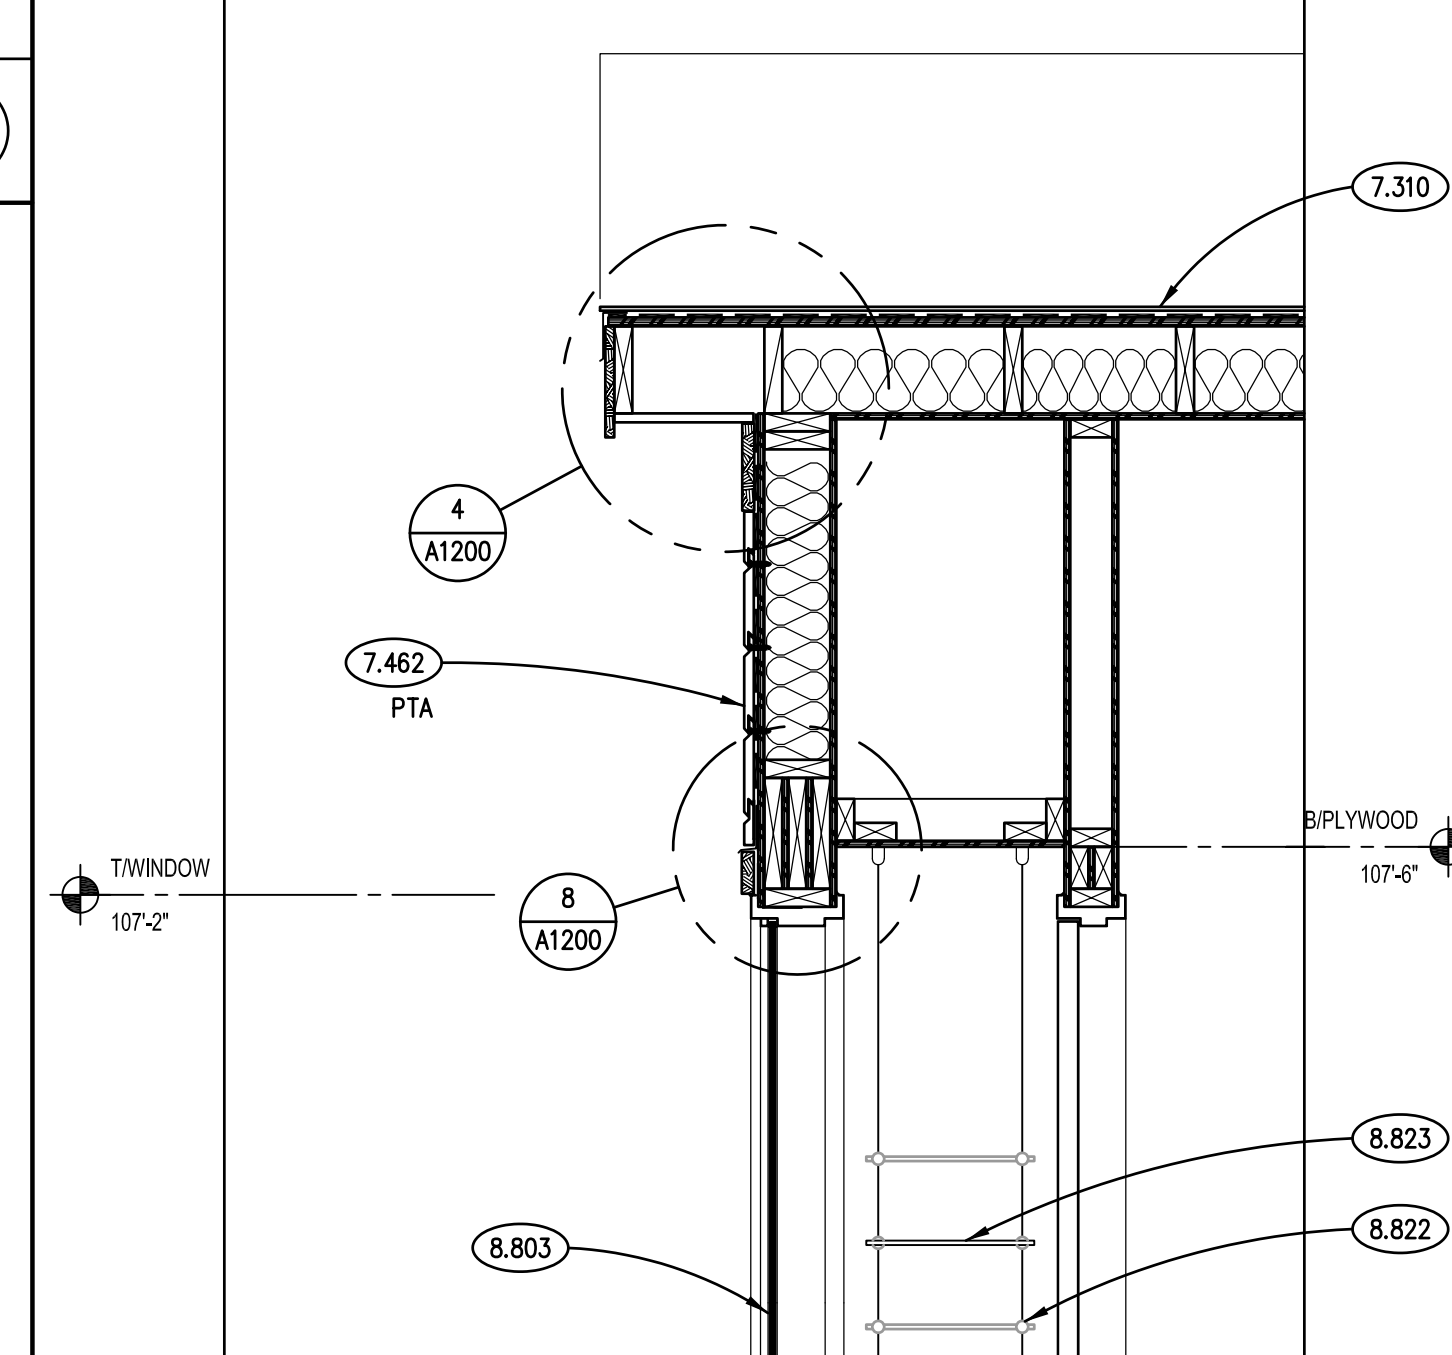


**TYPICAL SECTION DETAIL**  
SCALE: 3" = 1'-0" **5**

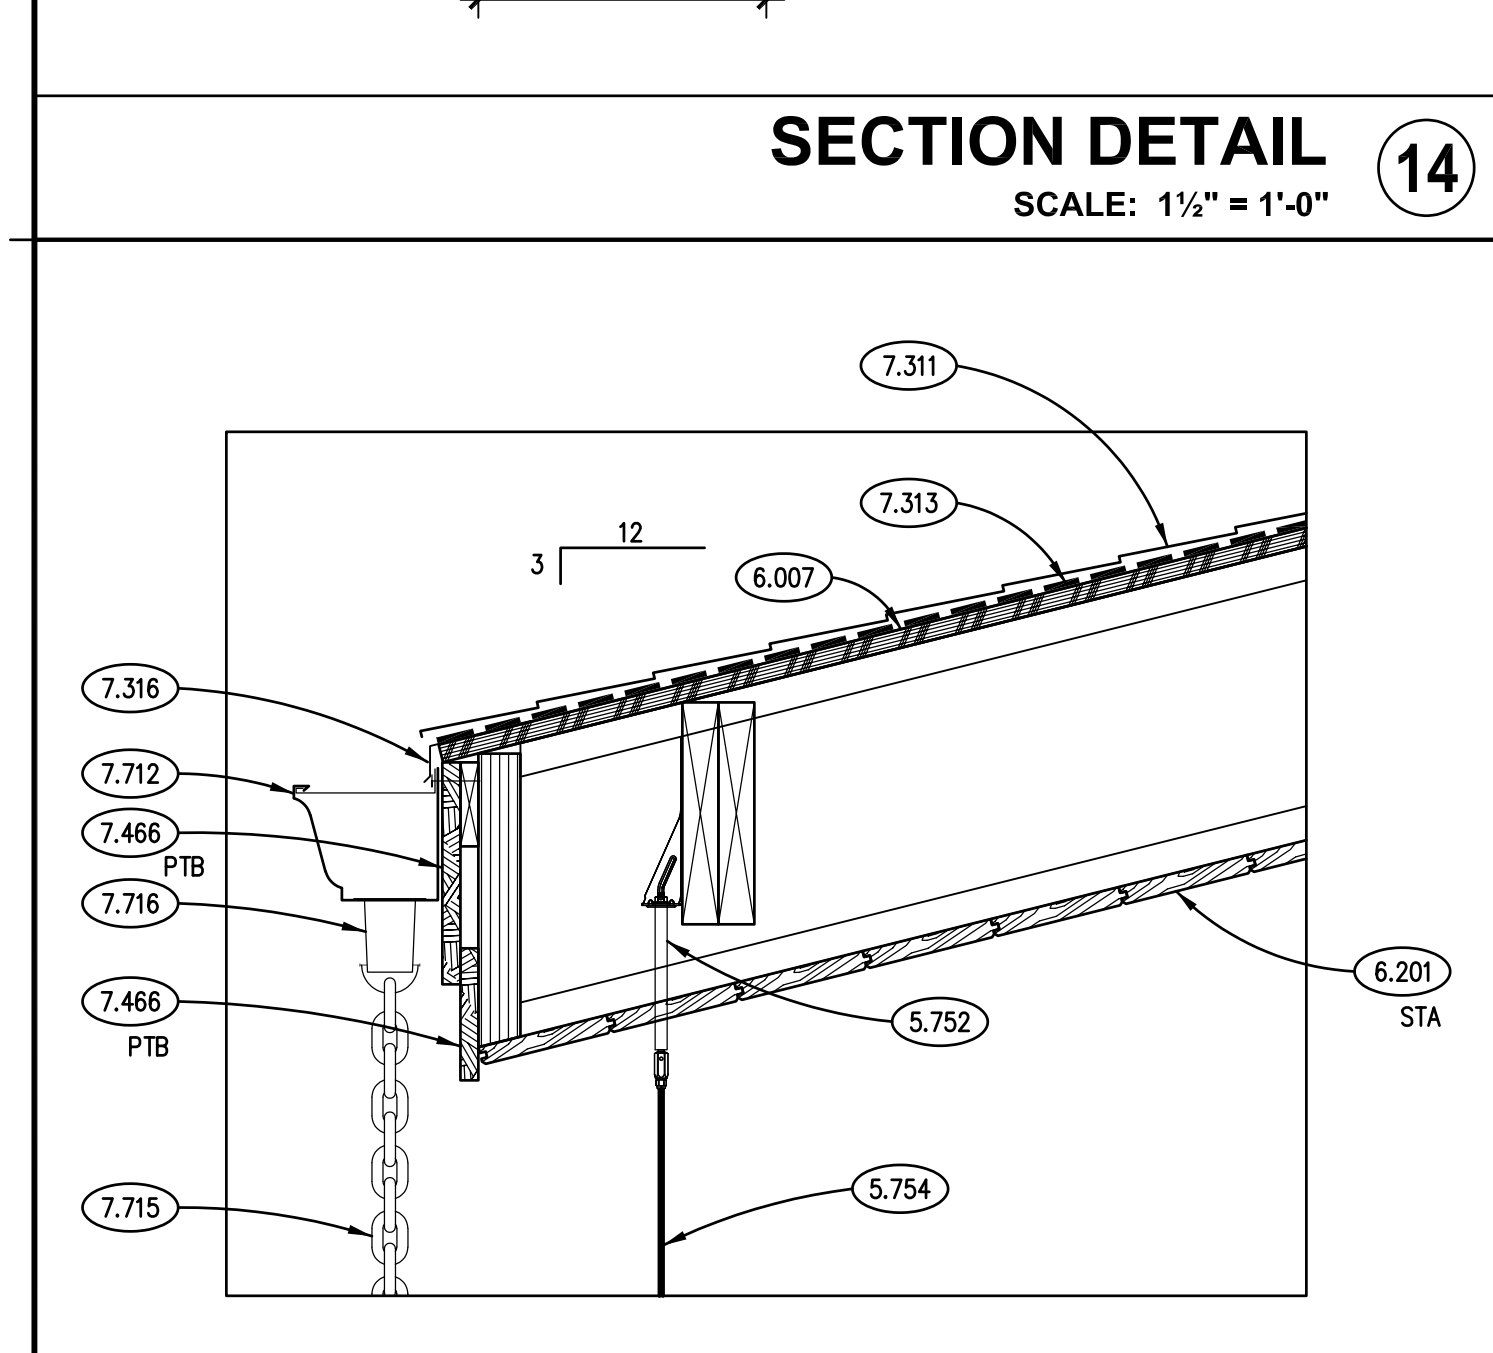


**SECTION DETAIL**  
SCALE: 1 1/2" = 1'-0" **13**

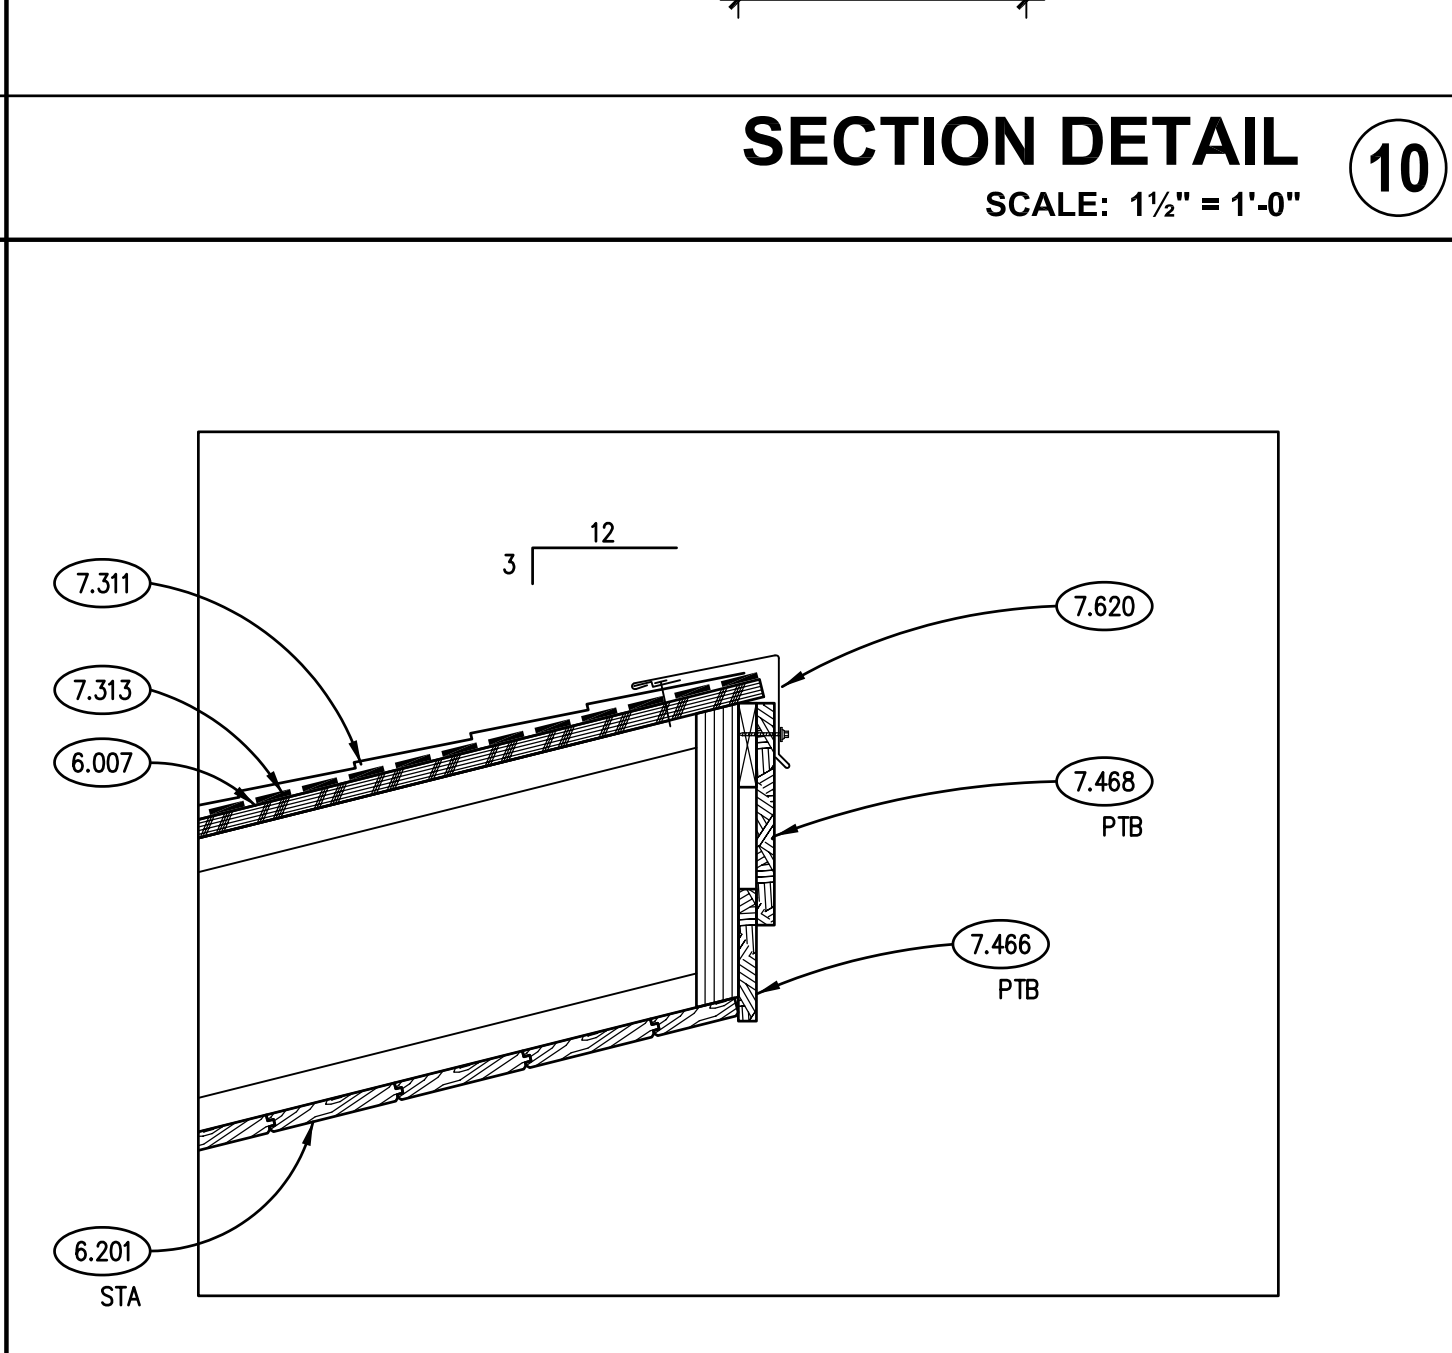


**SECTION DETAIL**  
SCALE: 1 1/2" = 1'-0" **9**

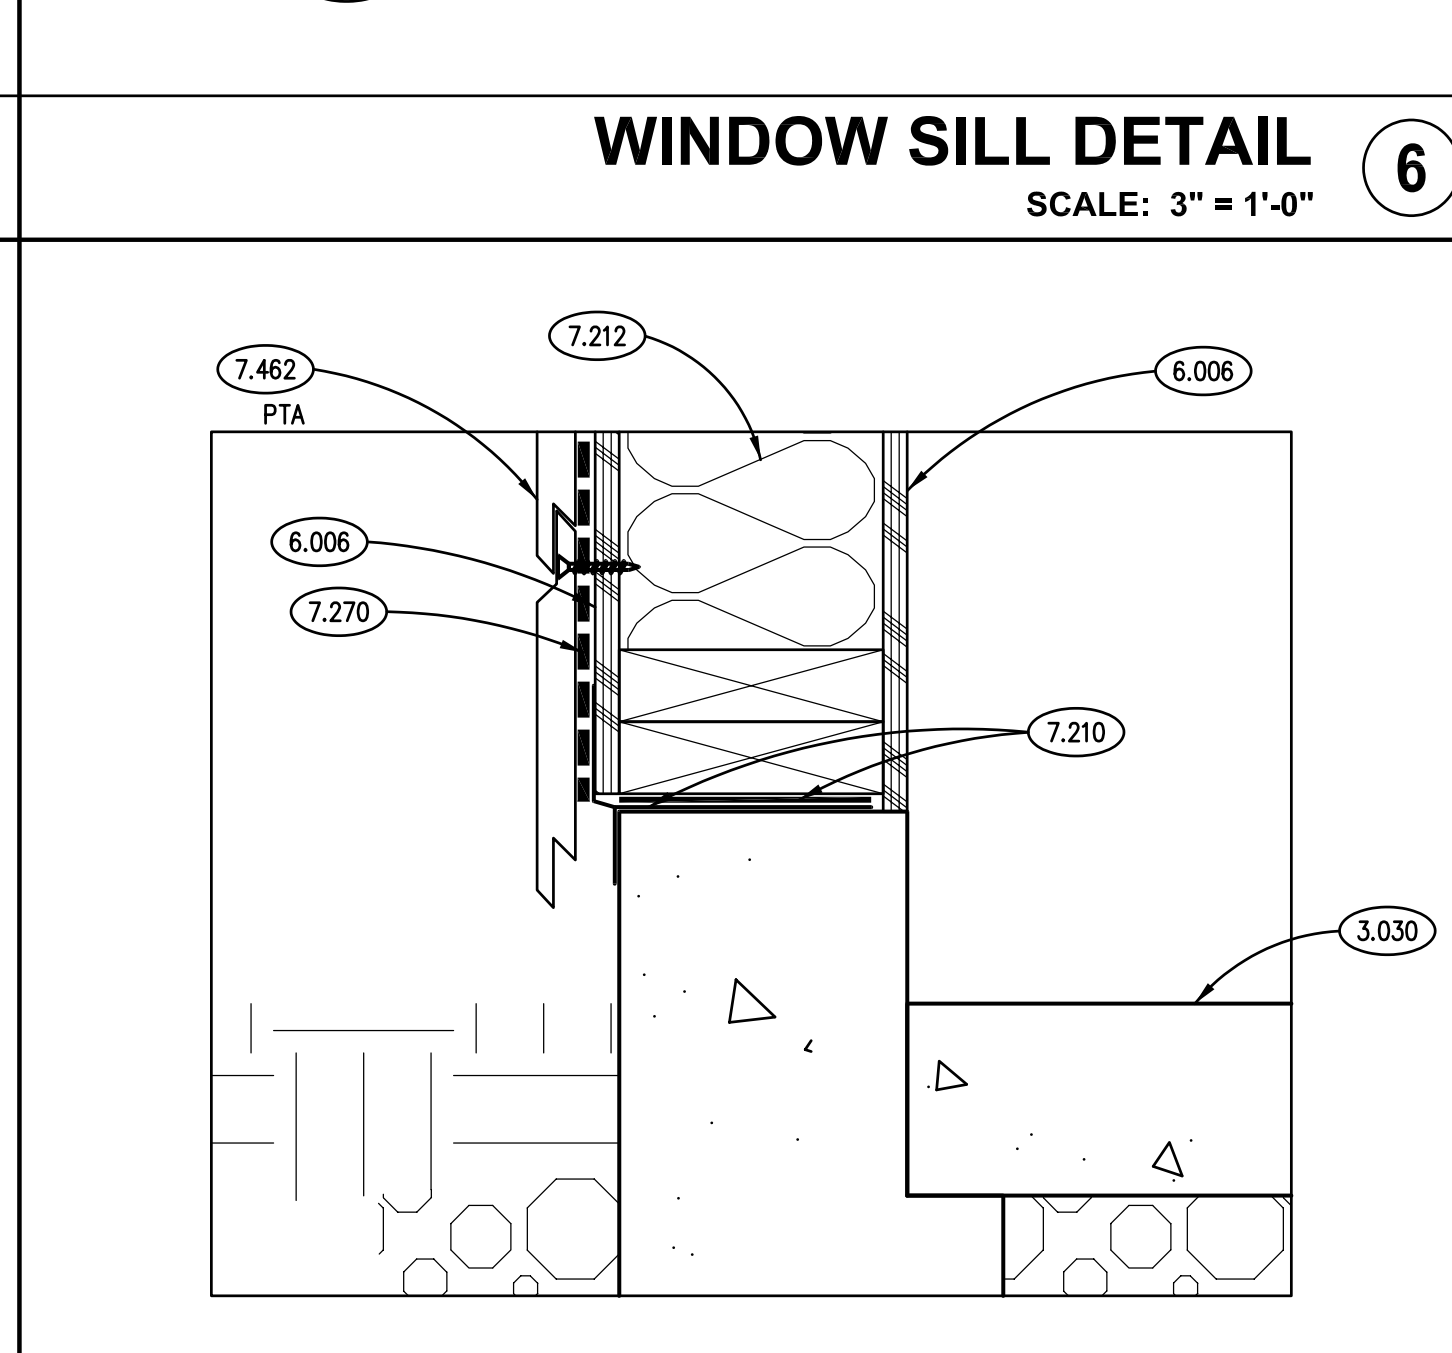

- ### KEYNOTES
- KEYNOTES ARE NOT ALWAYS REPEATED ACROSS ALL DRAWINGS ON THIS SHEET. AN UNKEYNOTED ITEM ON THIS SHEET IS THE SAME AS A KEYNOTED ITEM ON THIS SHEET HAVING THE SAME GRAPHIC APPEARANCE.
- CAST-IN-PLACE CONCRETE: REFER TO STRUCTURAL DRAWINGS.
  - STRUCTURAL STEEL: COLUMN; REFER TO STRUCTURAL DRAWINGS.
  - METAL FABRICATION: STEEL PLATE; REFER TO STRUCTURAL DRAWINGS.
  - METAL FABRICATION: STEEL BEAM SADDLE; REFER TO STRUCTURAL DRAWINGS.
  - DECORATIVE METAL PANEL ACCESSORY: 1/2" DIA. STUD-END PLUS-LOOK WIRE ROPE END FITTING CONNECTED TO SIMPSON HANGER OR CAST INTO CONCRETE PIER; STAINLESS STEEL; REFER TO ALLOWANCES AND SPECIFICATIONS.
  - DECORATIVE METAL PANEL ACCESSORY: REINFORCED CABLE: 3/8" DIA. - 7 X 19 STRAND CORE WIRE ROPE ACCESSORY; REFER TO ALLOWANCES AND SPECIFICATIONS.
  - ROUGH CARPENTRY: WOOD BLOCKING; DIMENSIONAL LUMBER; SIZE AS INDICATED; REFER TO SCHEDULE FOR TREATMENT.
  - ROUGH CARPENTRY: WOOD BLOCKING; DIMENSIONAL LUMBER; SIZE AS REQUIRED; REFER TO SCHEDULE FOR TREATMENT.
  - ROUGH CARPENTRY: PLYWOOD; 1/2" THICK; REFER TO SPECIFICATIONS FOR TREATMENT.
  - ROUGH CARPENTRY: PLYWOOD; 3/4" THICK; REFER TO SPECIFICATIONS FOR TREATMENT.
  - WOOD FRAMING: BEAM/HEADER; REFER TO STRUCTURAL DRAWINGS.
  - WOOD FRAMING: STUDS; REFER TO STRUCTURAL DRAWINGS.
  - WOOD I-JOIST: REFER TO STRUCTURAL DRAWINGS FOR SIZE AND SPACING.
  - FINISH CARPENTRY: EXTERIOR SOFFIT LUMBER; 1 X 6 TONGUE AND GROOVE.
  - INSULATION: THERMAL BATT; FRAFT FACED FIBERGLASS; THICKNESS TO FILL CAVITY, UNLESS INDICATED OTHERWISE; R-21.
  - INSULATION ACCESSORY: FORMED FOAM Baffle FOR ATTIC VENTILATION; REFER TO SPECIFICATIONS.
  - INSULATION ACCESSORY: SILL PLATE SEALER; CLOSED-CELL FOAM TAPE TYPE WITH RUBBERIZED ADHESIVE MEMBRANE; REFER TO SPECIFICATIONS.
  - AIR BARRIER SHEET MEMBRANE; REFER TO SPECIFICATIONS.
  - ASPHALT SHINGLE ROOFING SYSTEM; REFER TO SPECIFICATIONS.
  - ASPHALT SHINGLES; ARCHITECTURAL LAMINATED TYPE.
  - ASPHALT SHINGLES SHEET MATERIAL; UNDERLAYMENT.
  - ASPHALT SHINGLES METAL FLASHING; APRON; MATERIAL, THICKNESS AND FINISH AS SPECIFIED.
  - ASPHALT SHINGLES METAL FLASHING; EDGE FLASHING; MATERIAL, THICKNESS AND FINISH AS SPECIFIED.
  - FIBER CEMENT SIDING; REFER TO SPECIFICATIONS.
  - FIBER CEMENT SIDING; 5/8" THK. HORIZONTAL V-GROOVE LAP SIDING; 7" EXPOSURE; PRIMED. REFER TO SPECIFICATIONS.
  - FIBER CEMENT SIDING; 3.5" X 5/4" TRIM BOARD; PRIMED.
  - FIBER CEMENT SIDING; 4.5" X 5/4" TRIM BOARD; PRIMED.
  - FIBER CEMENT SIDING; 5.5" X 5/4" TRIM BOARD; PRIMED.
  - FIBER CEMENT SIDING; 7.25" X 5/4" TRIM BOARD; PRIMED.
  - FIBER CEMENT SIDING; 9.25" X 3/4" TRIM BOARD; PRIMED.
  - FIBER CEMENT SIDING ACCESSORY: DOOR/WINDOW FRESHENED METAL HEAD FLASHING; INSTALL OVER HEAD TRIM AND UNDER AIR BARRIER. TAPE ALL JOINTS.
  - METAL COPING FLASHING; MATERIAL, THICKNESS AND FINISH AS SPECIFIED.
  - METAL GUTTER; MATERIAL, 6 INCH K-OGEE PROFILE; THICKNESS AND FINISH AS SPECIFIED.
  - METAL DOWNSPOUT ACCESSORY: RAIN CHAIN; DOUBLE LOOPS RAIN CHAIN, BRONZE COLOR; REFER TO SPECIFICATIONS.
  - METAL DOWNSPOUT ACCESSORY: RAIN CHAIN ACCESSORY: INSTALLATION KIT; REFER TO SPECIFICATIONS.
  - JOINT SEALANT; REFER TO SCHEDULE IN SPECIFICATION SECTION 07 92 00; PROVIDE BACKER ROD OR BOND BREAKER.
  - STEEL DOOR FRAME; REFER TO DOOR, FRAME AND BORROWED LIGHT SCHEDULE.
  - STEEL WINDOW FRAME; REFER TO DOOR, FRAME AND BORROWED LIGHT SCHEDULE.
  - STEEL DOOR; REFER TO DOOR, FRAME AND BORROWED LIGHT SCHEDULE.
  - STEEL FRAME ACCESSORY: DOOR FRAME ANCHORS (PROVIDE AT JAMBS ONLY).
  - GLAZING: LAMINATED GLASS TYPE LG-8; REFER TO SPECIFICATIONS.
  - GLAZING ACCESSORY: GLAZING STOP.
  - DISPLAY GLAZING SYSTEM ACCESSORY: TOP OR BOTTOM FIXING AND CABLE; REFER TO SPECIFICATIONS.
  - DISPLAY GLAZING SYSTEM ACCESSORY: SHELF SUPPORTS, CABLE MOUNTED AND FULLY ADJUSTABLE; REFER TO SPECIFICATIONS.
  - DISPLAY GLAZING SYSTEM ACCESSORY: TEMPERED GLASS SHELVES: 14 INCH X 36 INCH X 10MM THICKNESS; REFER TO SPECIFICATIONS.
  - 26.005 PROVIDE 2-2" AND 2-3/4" EMPTY PVC CONDUIT FROM FUTURE PANEL LOCATION TO SE CORNER OF WEST ROOM AS SHOWN. STUB AND CAP. TRANSITION TO GALVANIZED RIGID STEEL CONDUIT ABOVE GRADE. ROUTE CONDUIT THROUGH COLUMN TO ACCESSIBLE CEILING LOCATION.

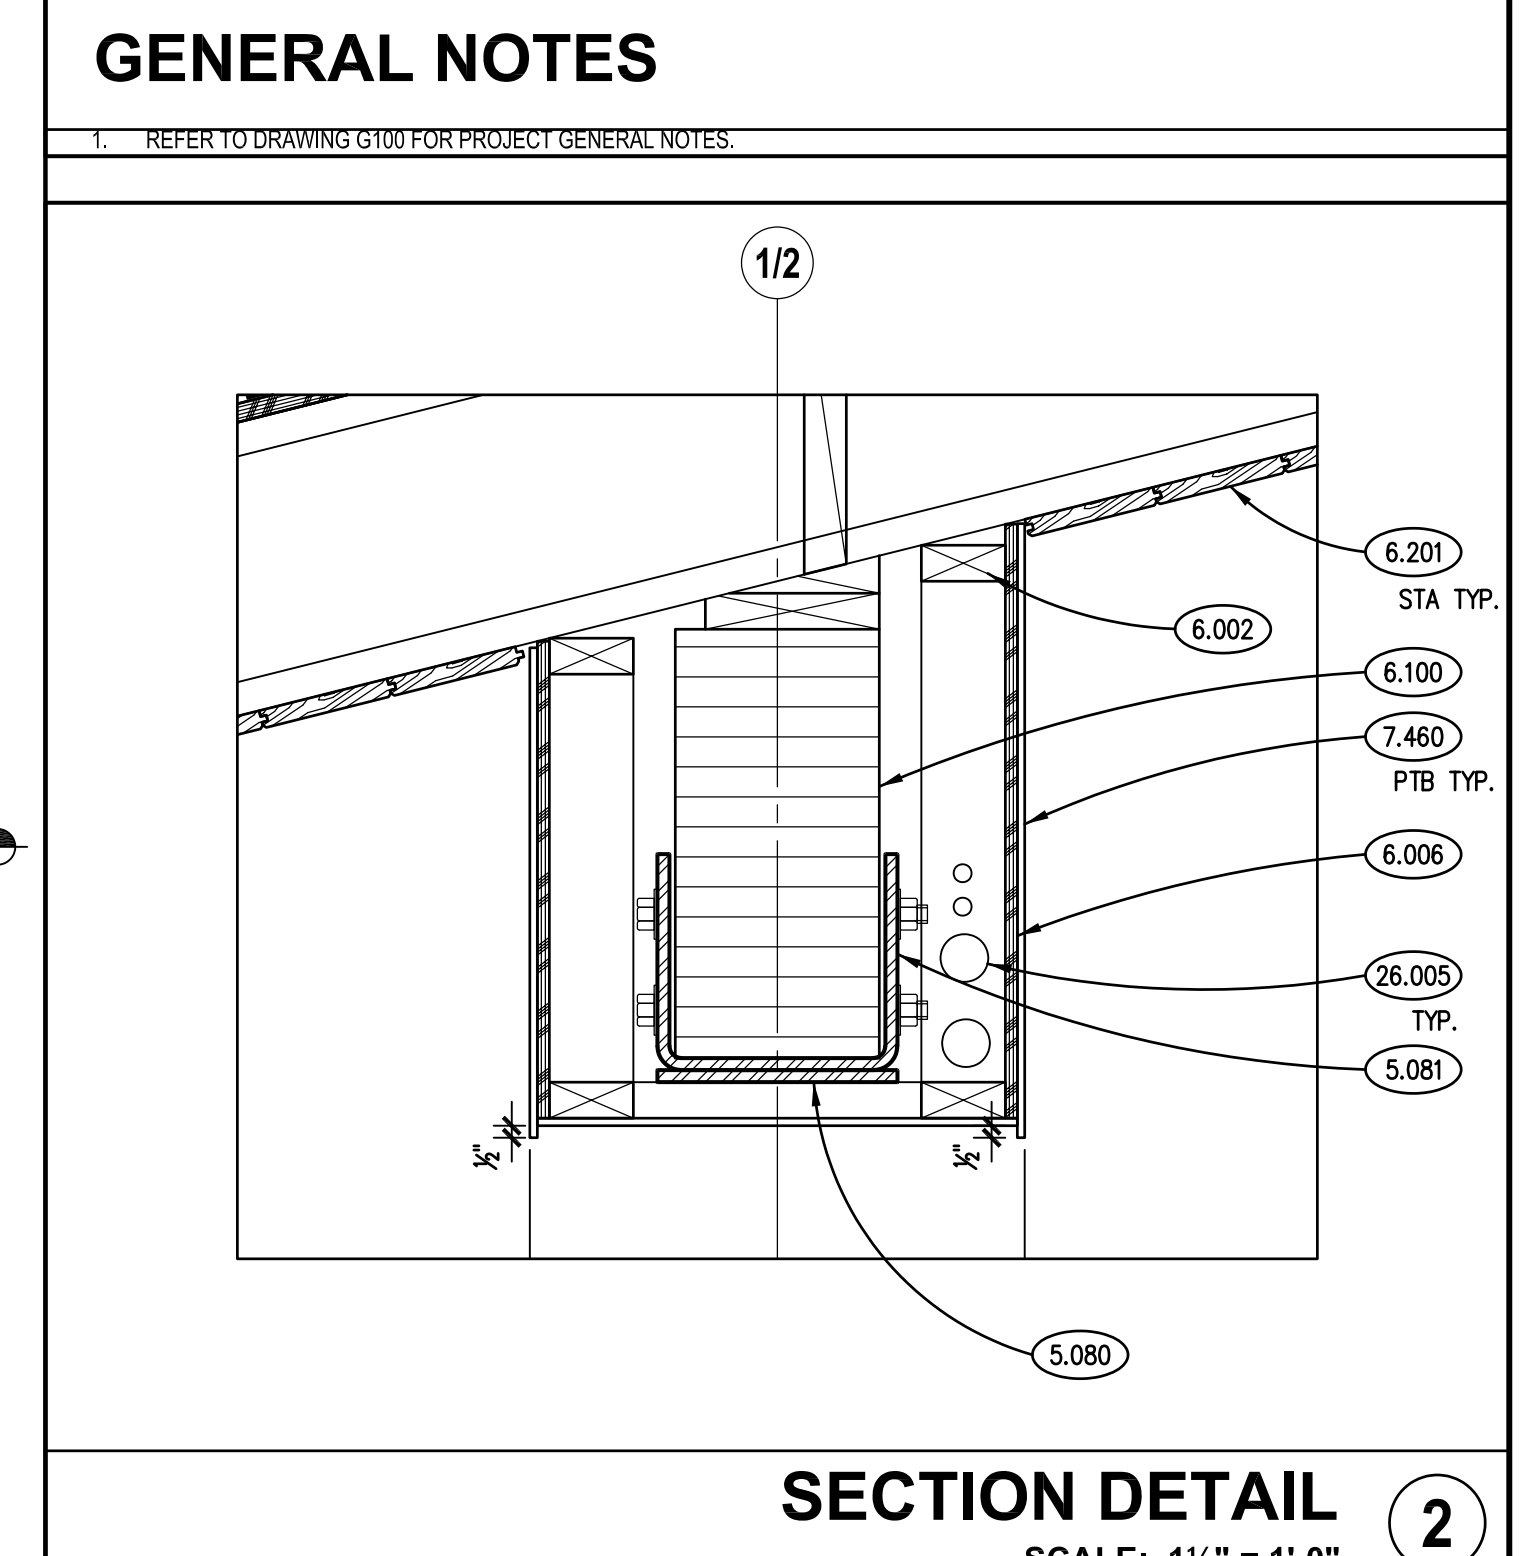

**SECTION DETAIL**  
SCALE: 1 1/2" = 1'-0" **2**

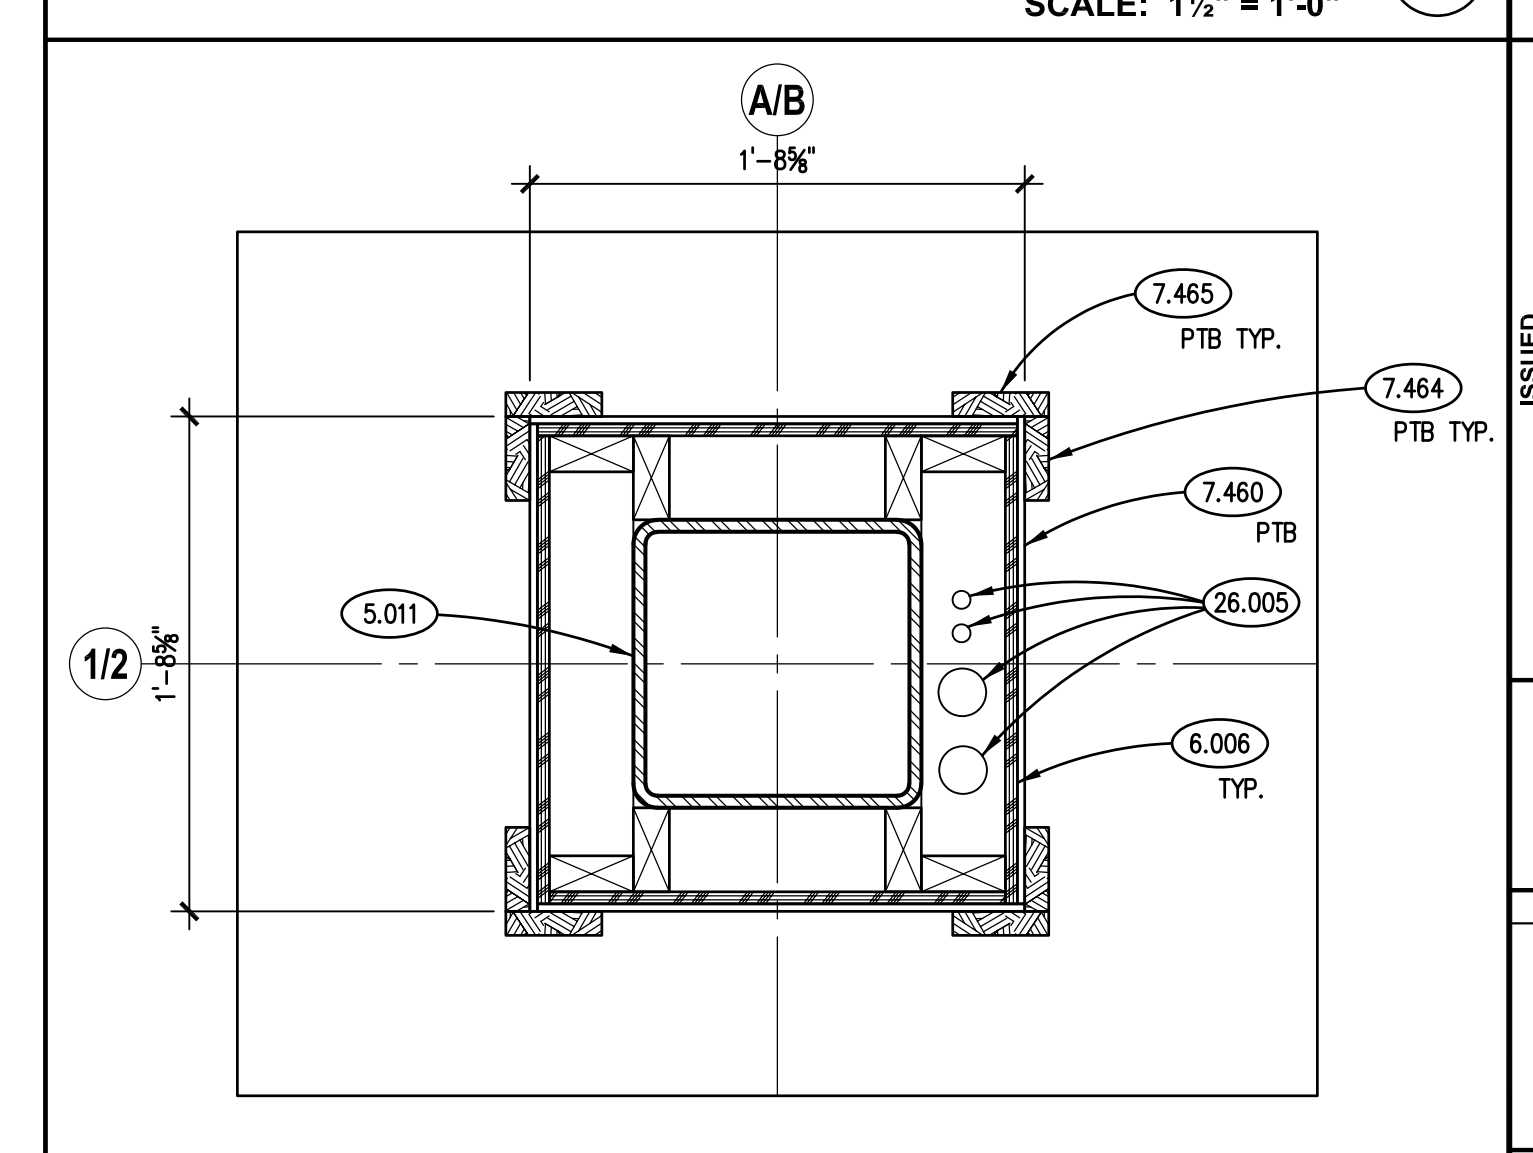

**TYP. COLUMN PLAN DETAIL**  
SCALE: 1 1/2" = 1'-0" **1**

**GENERAL NOTES**

- REFER TO DRAWING G100 FOR PROJECT GENERAL NOTES.

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KLUBER, INC.  
Aurora, Illinois 60506  
Tel: 630.246.9213  
Bloomington, Illinois 61714  
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CHECKED	CJH
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SECTION DETAILS
SHEET NUMBER
<b>A1200</b>

NOTE: SCALES DEPICTED ON THIS DRAWING ARE NOT CORRECT UNLESS PLOTTED SHEET SIZE IS 30 X 42 INCH.

### GENERAL NOTES

- THE CONTRACTOR SHALL FIELD VERIFY THE DIMENSIONS, ELEVATIONS, ETC. NECESSARY FOR THE PROPER CONSTRUCTION AND ALIGNMENT OF THE NEW PORTIONS OF THE WORK TO THE EXISTING WORK. THE CONTRACTOR SHALL MAKE ALL MEASUREMENTS NECESSARY FOR FABRICATION AND ERECTION OF STRUCTURAL MEMBERS. ANY DISCREPANCY SHALL BE IMMEDIATELY BROUGHT TO THE ATTENTION OF THE STRUCTURAL ENGINEER.
- CONTRACTOR SHALL PROVIDE PROTECTION FOR ALL SUBGRADES, FOUNDATIONS AND SLABS FROM FROST EFFECTS DURING INCLEMENT WEATHER.
- CONTRACTOR SHALL COORDINATE ALL DIMENSIONS AND ELEVATIONS WITH ARCHITECTURAL, M.E.P., AND VENDOR PREPARED SHOP DRAWINGS AND EXISTING CONDITIONS. SEE ARCHITECTURAL DRAWINGS FOR WORKPOINTS. SEE CIVIL DRAWINGS FOR BENCHMARKS.
- CONTRACTOR SHALL PROVIDE ALL TEMPORARY SHORING, SHEETING, BRACING ETC. AS REQUIRED TO PROTECT EXCAVATIONS AND EXISTING FOUNDATIONS DURING THE CONSTRUCTION PROCESS. CONTRACTOR SHALL PROVIDE ALL REQUIRED ENGINEERING REQUIRED FOR SUCH SYSTEMS BY AN ILLINOIS LICENSED STRUCTURAL ENGINEER.
- BACKFILLING OF FOUNDATIONS AND BELOW GRADE WALLS SHALL BE COMPLETED IN SUCH A MANNER TO AVOID OVERTURNING OF THE WALL. PROVIDE ALL TEMPORARY BRACING AS REQUIRED.
- HORIZONTAL RUNS OF CABLING, CONDUIT, PIPING OR ANY SUCH M.E.P. ITEMS ARE NOT TO BE PLACED WITHIN THE CROSS-SECTION OF THE SLABS/DECK. ALL SUCH ITEMS ARE TO BE INSTALLED BELOW THE SLAB/DECK WITH INDUSTRY STANDARD, ENGINEERED APPROVED SYSTEMS. THE CONTRACTOR DURING HIS BID SHALL ASSUME THAT HE NEEDS TO PROVIDE AND ENGINEER ALL SUPPLEMENTAL FRAMING ELEMENTS TO SPAN TO THE STRUCTURAL ELEMENTS THEREBY BY-PASSING THE SLABS/DECK. ALL SUCH SYSTEMS ARE SUBJECT TO THE REVIEW OF ENGINEER OF RECORD. SEE REQUIREMENTS FOR HANGING COMPONENTS DIRECTLY FROM ROOF DECKS ON SHEET S010.
- REFER TO DRAWING G100 FOR PROJECT GENERAL NOTES.
- REFER TO ARCHITECTURAL DRAWINGS FOR ALL FINISHES (I.E. FLOOR, WALL, CEILING, ETC.)
- THE STRUCTURAL DRAWINGS SHALL BE USED IN CONJUNCTION WITH ALL CONTRACT DRAWINGS, VENDOR DRAWINGS AND THE SPECIFICATIONS. THE CONTRACTOR SHALL VERIFY THE REQUIREMENTS OF OTHER TRADES FOR LOCATIONS OF SLEEVES, CHASES, HANGERS, INSERTS, ANCHORS, HOLES AND OTHER ITEMS TO BE PLACED OR SET IN THE STRUCTURAL WORK.
- THE STRUCTURAL DRAWINGS REPRESENT THE FINISHED STRUCTURE. THE CONTRACTOR SHALL PROVIDE ALL TEMPORARY GUYING AND BRACING REQUIRED TO ERECT AND HOLD THE STRUCTURE IN ALIGNMENT UNTIL ALL STRUCTURAL WORK AND CONNECTIONS HAVE BEEN COMPLETED. THE INVESTIGATION, DESIGN, SAFETY, ADEQUACY AND INSPECTION OF SUCH GUYING/BRACING IS THE SOLE RESPONSIBILITY OF THE CONTRACTOR.
- DRAWINGS INDICATE GENERAL AND TYPICAL DETAILS OF CONSTRUCTION. WHERE CONDITIONS ARE NOT SPECIFICALLY TAGGED OR SHOWN, SIMILAR DETAILS OF CONSTRUCTION SHALL BE USED, SUBJECT TO THE APPROVAL OF THE ENGINEER.
- ALL NON-LOAD BEARING WALLS ARE TO BE HELD DOWN AND AWAY FROM FRAMING ELEMENTS TO ALLOW FOR THESE ELEMENTS TO DEFLECT UNDER THEIR ANTICIPATED LOADING CONDITIONS. DO NOT BLOCK SOLID AROUND FRAMING ELEMENTS PASSING THROUGH NON-LOAD BEARING WALLS.
- TRADE CONTRACTORS TO COORDINATE WITH M.E.P. DRAWINGS FOR ALL REQUIRED PIPE SLEEVES, HANGERS, CAST-IN / RECESSED COMPONENTS AND INSERTS FOR M.E.P. EQUIPMENT AT SLABS AND WALLS.

### STEEL FRAMING NOTES

- ALL STRUCTURAL STEEL SHALL CONFORM TO THE LATEST EDITIONS OF AISC'S "STEEL CONSTRUCTION MANUAL" AND "CODE OF STANDARD PRACTICE FOR STEEL BUILDING AND BRIDGES".
- ALL WELDING SHALL BE IN ACCORDANCE WITH AWS D1.1 USING E70XX ELECTRODES. UNLESS OTHERWISE NOTED, PROVIDE CONT. MIN. SIZED FILLET WELDS PER AISC REQUIREMENTS.
- THE STEEL FABRICATOR AND ERECTOR ARE TO DEVELOP AND IMPLEMENT A QUALITY CONTROL PROGRAM AS SPECIFIED IN AISC 360-10, CHAPTER 9. THE STEEL FABRICATOR AND ERECTOR ARE TO PERFORM QUALITY CONTROL INSPECTIONS OF THE STEEL AT THE FABRICATION PLANT AND AT THE PROJECT SITE. REFER TO AISC 360-10, TABLES N5.4-1, N5.4-2, N5.4-3, N5.6-1, N5.6-2, N5.6-3 AND N6.1 FOR MINIMUM INSPECTION REQUIREMENTS.
- STRUCTURAL STEEL ERECTION TO COMPLY WITH OSHA REQUIREMENTS.
- STEEL PROPERTIES:
  - A. W & WT SHAPES = A992 (Fy = 50 KSI)
  - B. ANGLES, PLATES, CHANNELS & THREADED RODS = A36 (Fy = 36 KSI)
  - C. STRUCTURAL BOLTS = 3/4" Ø A325N
  - D. ANCHOR BOLTS = F1554 GRADE 36 (Fy = 36 KSI)
  - E. WELDING ELECTRODES = E70XX
- FINISH REQUIREMENTS:
  - A. TYPICAL CLEANING = SSPC-SP2 OR SSPC-SP3
  - B. PAINT = FABRICATOR'S STANDARD. SEE SPECIFICATIONS FOR ADDITIONAL PAINTING REQUIREMENTS.
  - C. GALVANIZED STEEL = ASTM A123, 1.7 OZ./SQ. FT MIN.
  - D. TOUCH-UP PRIMER = FABRICATOR'S STANDARD.
- ALL EXTERIOR STEEL ELEMENTS, BOLTS, WASHERS, LINTELS, ETC. TO BE GALVANIZED.
- BEAMS SHALL BE FIELD WELDED TO BEARING PLATES U.N.O. WELD SIZE TO BE 1/4"x2" LONG ON BOTH SIDES OF ELEMENTS. DO NOT WELD LOCATIONS NOTED ON PLAN AS \*\*. SEE LINTEL SCHEDULE NOTES REGARDING WELDING REQUIREMENTS.
- ACCEPTABLE EXPANSION ANCHOR PRODUCTS INCLUDE THE FOLLOWING:
  - a. HILT: KWIK BOLT 3 EXPANSION ANCHOR.
  - b. SIMPSON STRONG-TIE: STRONG-BOLT 2 WEDGE ANCHOR.

### TESTING AND INSPECTION

**GENERAL**

- THE APPROVED TESTING AGENCY SHALL BE RETAINED BY THE OWNER.
- THE APPROVED TESTING AGENCY SHALL BE THE "SPECIAL INSPECTOR" REFERRED TO IN OF THE INTERNATIONAL BUILDING CODE (IBC), CHAPTER 17 "STRUCTURAL TESTS AND SPECIAL INSPECTIONS."
- REFER TO CHAPTER 17 OF THE 2018 INTERNATIONAL BUILDING CODE FOR DEFINITION OF TERMS.
- THE TESTING AGENCY SHALL SUBMIT TO THE ENGINEER OF RECORD ONE (1) COPIES OF WEEKLY REPORTS OF THE TEST AND INSPECTIONS CONDUCTED DURING THE WEEK. THE REPORTS SHALL STATE IF THE TESTS AND INSPECTIONS MET THE PROJECT REQUIREMENTS AND, IF NOT, WHAT FOLLOW-UP TESTS OR INSPECTIONS WILL BE MADE.
- THE TESTING AGENCY SHALL NOTIFY GENERAL CONTRACTOR IMMEDIATELY IF ANY OF THE SCHEDULED TESTS FAIL IN ORDER TO AVOID PROJECT DELAYS.
- SEE SPECIFICATION SECTION 1400 "QUALITY REQUIREMENTS" FOR ADDITIONAL INFORMATION.

**FOUNDATION INSPECTION**

- ALL FOUNDATION EXCAVATIONS SHALL BE OBSERVED AND TESTED BY A REPRESENTATIVE OF A QUALIFIED GEOTECHNICAL ENGINEERING FIRM. DAILY REPORTS OF OBSERVATIONS SHALL BE PREPARED.
- PROVIDE CONTINUOUS INSPECTION FOR THE FOLLOWING:
  - A. VERIFY USE OF PROPER MATERIALS, DENSITIES AND LIFT THICKNESSES DURING PLACEMENT AND COMPACTION OF CONTROLLED FILL.
- PROVIDE PERIODIC INSPECTION FOR THE FOLLOWING:
  - A. VERIFY MATERIALS BELOW FOOTINGS AS ADEQUATE TO ACHIEVE THE DESIGN BEARING CAPACITY.
  - B. VERIFY EXCAVATIONS ARE EXTENDED TO PROPER DEPTH AND HAVE REACHED PROPER MATERIAL.
  - C. PERFORM CLASSIFICATION AND TESTING OF CONTROLLED FILL MATERIALS.
  - D. PRIOR TO PLACEMENT OF CONTROLLED FILL, OBSERVE SUBGRADE AND VERIFY THAT SITE HAS BEEN PREPARED PROPERLY.

**REINFORCED CONCRETE INSPECTION**

- PROVIDE CONTINUOUS INSPECTION FOR THE FOLLOWING:
  - A. SAMPLING OF FRESH CONCRETE FOR SLUMP, AIR CONTENT AND TEMPERATURE AT THE TIME OF MAKING SPECIMENS FOR STRENGTH TESTS PER ACI 318, CHAPTERS 5.6, 5.8.
  - B. INSPECTION OF CONCRETE PLACEMENT PER ACI 318, CHAPTERS 5.9, 5.10.
- PROVIDE PERIODIC INSPECTIONS FOR THE FOLLOWING FOR CONFORMANCE TO ACI 318:
  - A. INSPECT REINFORCING STEEL PLACEMENT PER ACI 318, CHAPTERS 3.5, 7.1-7.7.
  - B. VERIFY USE OF REQUIRED MIX DESIGN PER ACI 318, CHAPTERS 4, 5.2-5.4.
  - C. MAINTENANCE OF SPECIFIED CURING TEMPERATURE AND TECHNIQUES PER ACI 318, CHAPTERS 5.11-5.13.
- INSPECT FORMWORK FOR SHAPE, LOCATION AND DIMENSIONS PER ACI 318, CHAPTER 6.1.1.

### STRUCTURAL WOOD CONSTRUCTION

- INSPECTION OF FABRICATED STRUCTURAL LOAD-BEARING MEMBERS REQUIRED PER IBC SECTION 1704.2 SHALL CONSIST OF EITHER THE FOLLOWING:
  - A. SPECIAL INSPECTION IN ACCORDANCE WITH IBC 1704.2.5.1 "FABRICATION AND IMPLEMENTATION PROCEDURES".
  - B. FABRICATOR PARTICIPATION IN A QUALITY ASSURANCE INSPECTION PROGRAM IN ACCORDANCE WITH IBC 1704.2.5.2 "FABRICATOR APPROVAL".
- CONTINUOUS SPECIAL INSPECTION IS REQUIRED DURING FIELD GLUING OPERATIONS OF ELEMENTS OF THE MAIN WINDFORCE-RESISTING SYSTEM. PERIODIC SPECIAL INSPECTION IS REQUIRED FOR NAILING, BOLTING, ANCHORING AND OTHER FASTENING OF ELEMENTS OF THE MAIN WIND-FORCE RESISTING SYSTEM, INCLUDING WOOD SHEAR WALLS, WOOD DIAPHRAGMS, DRAG STRUTS, BRACES AND HOLD-DOWNS.

### FOUNDATION & SLAB NOTES

- ALL CONCRETE WORK SHALL CONFORM TO THE REQUIREMENTS OF ACI 301, "SPECIFICATION FOR STRUCTURAL CONCRETE BUILDINGS" AND ACI 318, "BUILDING CODE REQUIREMENTS FOR STRUCTURAL CONCRETE". HOT WEATHER CONCRETING SHALL BE IN ACCORDANCE WITH ACI 305. COLD WEATHER CONCRETING SHALL BE IN ACCORDANCE WITH ACI 306.
- CONCRETE CONTRACTOR TO COORDINATE ALL DIMENSIONS, ELEVATIONS, SLOPES, ETC. OF ALL CONCRETE SLABS / FOUNDATIONS WITH ARCHITECTURAL DRAWINGS.
- CONCRETE STRENGTHS AS FOLLOWS (28 DAY):
  - A. FOOTINGS, FOUNDATION WALLS & PIERS= 3,000 PSI
  - B. INTERIOR SLABS= 4,000 PSI
  - C. EXTERIOR SLABS= 4,500 PSI
  - D. SEE SPECIFICATIONS FOR DETAILED CONCRETE MIX DESIGNS.
- REINFORCEMENT:
  - A. BARS, TIES & STIRRUPS: ASTM A615 GRADE 60, DEFORMED
  - B. W.W.F.: ASTM A185, SMOOTH. FLAT SHEETS ONLY. PLACEMENT (I.E. SUPPORT SPACING, LAP SPICE LENGTHS, ETC.) TO BE IN ACCORDANCE WITH THE STRUCTURAL WELDED WIRE REINFORCEMENT MANUAL OF STANDARD PRACTICE; (WWR-500); WIRE REINFORCEMENT INSTITUTE; LATEST EDITION.
  - C. WELDABLE BARS: ASTM A706 GRADE 60, DEFORMED.
  - D. PROVIDE LAP SPLICES IN ACCORDANCE WITH ACI 301.
  - E. FABRICATE & DETAIL REINFORCING STEEL IN ACCORDANCE WITH CRSI (DA4) MANUAL OF STANDARD PRACTICE.
  - F. FACTORY MADE WIRE BAR SUPPORTS AND HOLDING BARS SHALL BE PROVIDED FOR ALL REINFORCING STEEL TO ENSURE MINIMUM CONCRETE COVER AND MAINTAIN POSITION DURING CASTING.
  - G. PROVIDE ADEQUATE AND PROPER SUPPORT OF ALL REINFORCING STEEL AS REQUIRED TO PROVIDE THE COVER REQUIREMENTS NOTED ON THE PROJECT DRAWINGS AND ACI 318.
  - H. CONCRETE COVER FOR REINFORCEMENT TO BE AS FOLLOWS:
 

LOCATION / APPLICATION	COVER
SLAB ON GRADE:	3"
FOUNDATION WALL:	2"
FOOTINGS:	3"
- BACKFILLING OF FOUNDATIONS AND BELOW GRADE WALLS SHALL BE COMPLETED IN SUCH A MANNER TO AVOID OVERTURNING OF THE WALL. PROVIDE ALL TEMPORARY BRACING AS REQUIRED.
- CONTRACTOR SHALL PROVIDE PROTECTION FOR ALL SUBGRADES, FOUNDATIONS AND SLABS FROM FROST EFFECTS DURING INCLEMENT WEATHER.
- ALL BOTTOM OF EXTERIOR FOOTINGS SHALL HAVE A MINIMUM OF 3'-6" GROUND COVER. COORDINATE ALL FINAL GRADE ELEVATIONS WITH ARCHITECTURAL AND CIVIL DRAWINGS.
- SEE ARCHITECTURAL DRAWINGS AND PROJECT SPECIFICATIONS FOR ALL WATERPROOFING, DAMPROOFING AND INSULATION REQUIREMENTS.
- ALUMINUM MATERIALS OF ANY TYPE ARE PROHIBITED FROM BEING CAST, EMBEDDED OR IN CONTACT WITH THE CONCRETE WORK.
- CONCRETE CONTRACTOR TO COORDINATE WITH M.E.P. CONTRACTORS FOR ANY REQUIRED FOUNDATION DEPRESSIONS, OPENINGS, KNOCK-OUTS, FLOOR DRAINS, INSERTS, ETC.
- ACCEPTABLE INJECTION EPOXY ADHESIVE PRODUCTS INCLUDE THE FOLLOWING:
  - a. HILTI HY-150 FAST-CURING INJECTION ADHESIVE SYSTEM.
  - b. SIMPSON STRONG-TIE SET-XP HIGH-STRENGTH ANCHORING ADHESIVE SYSTEM.
  - c. POWERS FASTENERS PURE 110+ EPOXY INJECTION ADHESIVE ANCHORING SYSTEM.

### FOUNDATION & SLAB SYMBOLS & NOMENCLATURE

<p>F a. S.C.J. DENOTES SLAB CONTRACTION/CONTROL JOINT.</p> <p>F b. SF6.0 DENOTES SPREAD FOOTING. SEE SCHEDULE ON SHEET S310.</p> <p>F c. SLAB S1 DENOTES CONCRETE SLAB. SEE PLANS AND SCHEDULE ON SHEET S311 FOR ALL SLAB TYPES AND LOCATIONS.</p> <p>F d. DENOTES TOP OF FOOTING ELEVATION. ALL FOOTINGS NOT SPECIFICALLY TAGGED SHALL HAVE A TOP OF FOOTING ELEVATION OF 96'-6".</p> <p>F e. [6'-0"] DENOTES ANTICIPATED BOTTOM OF FOOTING UNDERCUT BASED ON INFORMATION EXTRACTED FROM THE PROJECT SOILS REPORT NOTED ABOVE.</p>	
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### WOOD FRAMING NOTES

- WOOD FRAMING TO CONFORM TO THE LATEST EDITIONS OF THE NATIONAL DESIGN SPECIFICATIONS FOR WOOD CONSTRUCTION MANUAL.
- ALL STRUCTURAL PLYWOOD SHEATHING / DECKING TO MEET THE REQUIREMENTS OF THE "VOLUNTARY PRODUCT STANDARD PS 1-09" BY THE NATIONAL INSTITUTE OF STANDARDS AND TECHNOLOGY.
- ALL STRUCTURAL PLYWOOD SHEATHING / DECKING TO MEET THE REQUIREMENTS OF "APA PRP-109/ APA PRP-108, FORM B455 - PERFORMANCE STANDARDS AND QUALITY POLICY FOR STRUCTURAL-USE PANELS".
- PENETRATIONS THROUGH THE ROOF REQUIRE SUPPLEMENTAL FRAMING AS DETAILED ON SHEET S800. CONTRACTOR TO COORDINATE SIZE, LOCATIONS AND QUANTITIES WITH THE FULL SET OF DOCUMENTS.
- ALL NON-LOAD BEARING WALLS ARE TO BE HELD DOWN AND AWAY FROM FRAMING ELEMENTS TO ALLOW FOR THESE ELEMENTS TO DEFLECT UNDER THEIR ANTICIPATED LOADING CONDITIONS.
- HORIZONTAL RUNS OF CABLING, CONDUIT, PIPING OR ANY SUCH M.E.P. ITEMS ARE NOT TO BE PLACED THROUGH LOAD BEARING WALLS. ALL SUCH ITEMS ARE TO TRAVEL VERTICALLY WITHIN LOAD BEARING WALLS WITH INDUSTRY STANDARD, ENGINEER APPROVED SUPPORT SYSTEMS. DO NOT HANG DIRECTLY FROM WOOD SHEATHING DECKS.
- ALL PENETRATIONS ARCHITECTURAL AND M.E.P. ITEMS THROUGH WOOD LOAD BEARING WALLS REQUIRE A HEADER. CONTRACTOR TO COORDINATE SIZE, LOCATIONS AND QUANTITIES WITH THE FULL SET OF DOCUMENTS AVAILABLE AT THE TIME OF BIDDING. IF A HEADER IS NOT SPECIFICALLY TAGGED, THE CONTRACTOR SHALL ASSUME THAT THE MINIMUM HEADER WILL BE A H1.
- ALL LIGHT GAUGE WOOD CONNECTORS ARE TO BE AS MANUFACTURED BY SIMPSON STRONG-TIE. PROVIDE FASTENER TYPE AND QUANTITY THAT RESULTS IN THE MAXIMUM TABULATED VALUES.
- SEE SCHEDULE ON SHEET S800 FOR TYPICAL MINIMUM FASTENER CONNECTION REQUIREMENTS FOR ALL WOOD FRAMING ELEMENTS.
- MINIMUM ELEMENT PROPERTIES AS FOLLOWS:
 

CONVENTIONAL LUMBER	ENGINEERED LUMBER
SPECIES: SPRUCE PINE-FIR NO. 2	SPECIES: LVL GLULAM: SP_26F-1.9E
Fb: 875 PSI	Fb: 2,600 PSI
Fc: 450 PSI	Fc: 750 PSI
Fv: 135 PSI	Fv: 285 PSI
E: 1,400,000 PSI	E: 1,900,000 PSI
	Ft: 2,500 PSI
	Fcr: 1,600 PSI
	Fv: 565 PSI
	E: 1,900,000 PSI
- ALL SHEATHING FOR EXTERIOR WALLS TO BE ZIP SYSTEM. STRUCTURAL I. ATTACH TO ALL SUPPORTING MEMBERS USING 8d NAILS @ 6" O.C. AT PANEL EDGES AND 12" O.C. IN FIELD OF PANEL U.N.O. ALL PANELS SHALL BE 1/2" NOMINAL THICKNESS, SPAN RATING 32/16. SEE SCHEDULES ON SHEET S800 FOR ADDITIONAL INFORMATION REGARDING ADDITIONAL FASTENERS REQUIRED AT SHEAR WALL ELEMENTS.
  - A. FLAT ROOFS: TYPE CDX, 4-PLY, 3/4" NOMINAL THICKNESS, SPAN RATING 40/20. PROVIDE "PSCL" CLIPS AT MID-SPAN OF UNSUPPORTED EDGES OF PANELS. CONTRACTOR OPTION: TYPE OSB, 3/4" NOMINAL THICKNESS, SPAN RATING 40/20.
- ALL PLYWOOD AND OSB SHEATHING FOR ROOFS TO BE APA RATED EXPOSURE 1, STRUCTURAL I. ATTACH SHEATHING TO SUPPORTING MEMBERS USING 10d NAILS @ 6" O.C. AT PANEL EDGES AND 12" O.C. IN FIELD OF PANEL U.N.O. PROVIDE 1/8" GAP BETWEEN ADJACENT PANELS. PROVIDE MINIMUM OF 3 SPAN CONDITION. ORIENT PLYWOOD STRENGTH AXIS OF PLYWOOD PERPENDICULAR TO FRAMING ELEMENTS. STAGGER PANEL END JOINTS. SEE SPECIFICS BELOW FOR DIFFERENT TYPES AND LOCATIONS.
  - A. FLAT ROOFS: TYPE CDX, 4-PLY, 3/4" NOMINAL THICKNESS, SPAN RATING 40/20. PROVIDE "PSCL" CLIPS AT MID-SPAN OF UNSUPPORTED EDGES OF PANELS. CONTRACTOR OPTION: TYPE OSB, 3/4" NOMINAL THICKNESS, SPAN RATING 40/20.

### WOOD FRAMING SYMBOLS & NOMENCLATURE

<p>Wa. H1/H1M DENOTES WOOD HEADER. SEE HEADER SCHEDULE ON SHEET S800.</p> <p>Wb. P1 DENOTES WOOD POST. SEE SCHEDULE ON SHEET S800.</p> <p>Wc. CR1 DENOTES CRIPPLE STUD. SEE SCHEDULE ON SHEET S800.</p> <p>Wd. K1 DENOTES KING STUD. SEE SCHEDULE ON SHEET S800.</p> <p>We. WSWALL-1 DENOTES WOOD SHEARWALL. SEE SCHEDULE ON SHEET S800.</p>	
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### CODE AND LOADING

A. DESIGN REQUIREMENTS AND STRUCTURAL LOADS ARE TO BE IN ACCORDANCE WITH THE 2018 INTERNATIONAL BUILDING CODE AND ANY VILLAGE AMENDMENTS.

B. LOADING CRITERIA:


- OCCUPANCY GROUP: U
- OCCUPANCY CATEGORY: II
- ROOF LOADS:
  - a. GROUND SNOW LOAD (Pg) = 25 PSF
  - b. FLAT-ROOF SNOW LOAD (Ps) = 21 PSF
  - c. SNOW IMPORTANCE FACTOR (Is) = 1.0
  - d. SNOW IMPORTANCE FACTOR (Is) = 1.0
  - e. THERMAL FACTOR (Ct) = 1.2
- WIND LOADS:
  - a. BASIC WIND SPEED (V) = 115 MPH
  - b. IMPORTANCE FACTOR (I) = 1.00
  - c. EXPOSURE CATEGORY = B
  - d. ENCLOSURE CLASSIFICATION = ENCLOSED
  - e. MWFRS = 20 PSF
  - f. COMPONENTS AND CLADDING = 25 PSF
  - g. ROOFTOP STRUCTURES & EQUIPMENT = 35 PSF
- SEISMIC CRITERIA:
  - a. IMPORTANCE FACTOR (I) = 1.00
  - b. MAPPED SPECTRAL RESPONSE (Ss & S1) = 16.0%g & 6.6%g
  - c. SPECTRAL RESPONSE COEF. (Sds & S1d) = .171 & .106
  - d. DESIGN CATEGORY = B
  - e. SITE CLASS = D
  - f. BASIC RESISTING SYSTEM= WOOD SHEAR WALLS, Rw=6.5
  - g. RESPONSE COEFFICIENT (Cs) = 0.026W
  - h. ANALYSIS PROCEDURE = EQUIVALENT LATERAL FORCE

### DRAFTING LEGEND

DESCRIPTION	SYMBOL	MATERIAL	NOTES
PIER DETAIL LETTER SHEET NUMBER			NOT CONTINUOUS SOLID BLOCKING, REFER TO DETAILS
ELEVATION NUMBER SHEET NUMBER			EARTH
SECTION NUMBER SHEET NUMBER			CONCRETE
LOCATION ELEVATION			INSULATION RIGID
SPOT ELEVATION			FOUNDATION DEPRESSION
WOOD SHEAR WALL TAG	WS-WALL 1		ASPHALT PAVEMENT
SPREAD FOOTING TAG	SF6.0		
KEYNOTE IDENTIFICATION			ROOF/FLOOR FRAME FOR OPENING W/ PIPING/CONDUITS REQ'D TO BE SLEEVED AND FIRE CAULKED
CONTINUOUS SOLID BLOCKING			ROOF/FLOOR FRAME FOR OPENING W/ PIPING/CONDUITS REQ'D TO BE SLEEVED AND FIRE CAULKED


DATE	OWNER REVIEW	ARCHITECT	ENGINEER	JOB NO.	DRAWN	CHECKED	APPROVED	SHEET TITLE
				23-429-1495	KSG	JMB	JMB	GENERAL NOTES CODE & LOADING, TESTING & INSPECTIONS
								SHEET NUMBER
								S010

NOTE: SECTION IS PORTRAYING FRAMING CONDITIONS AT NORTH WALL OF WEST SHED BEYOND. SIMILAR LOCATIONS DO NOT HAVE DISPLAY WINDOW OPENING, AND STANDARD WALL FRAMING AS DEPICTED IN SECTION 2 SHALL BE COMPLETED.

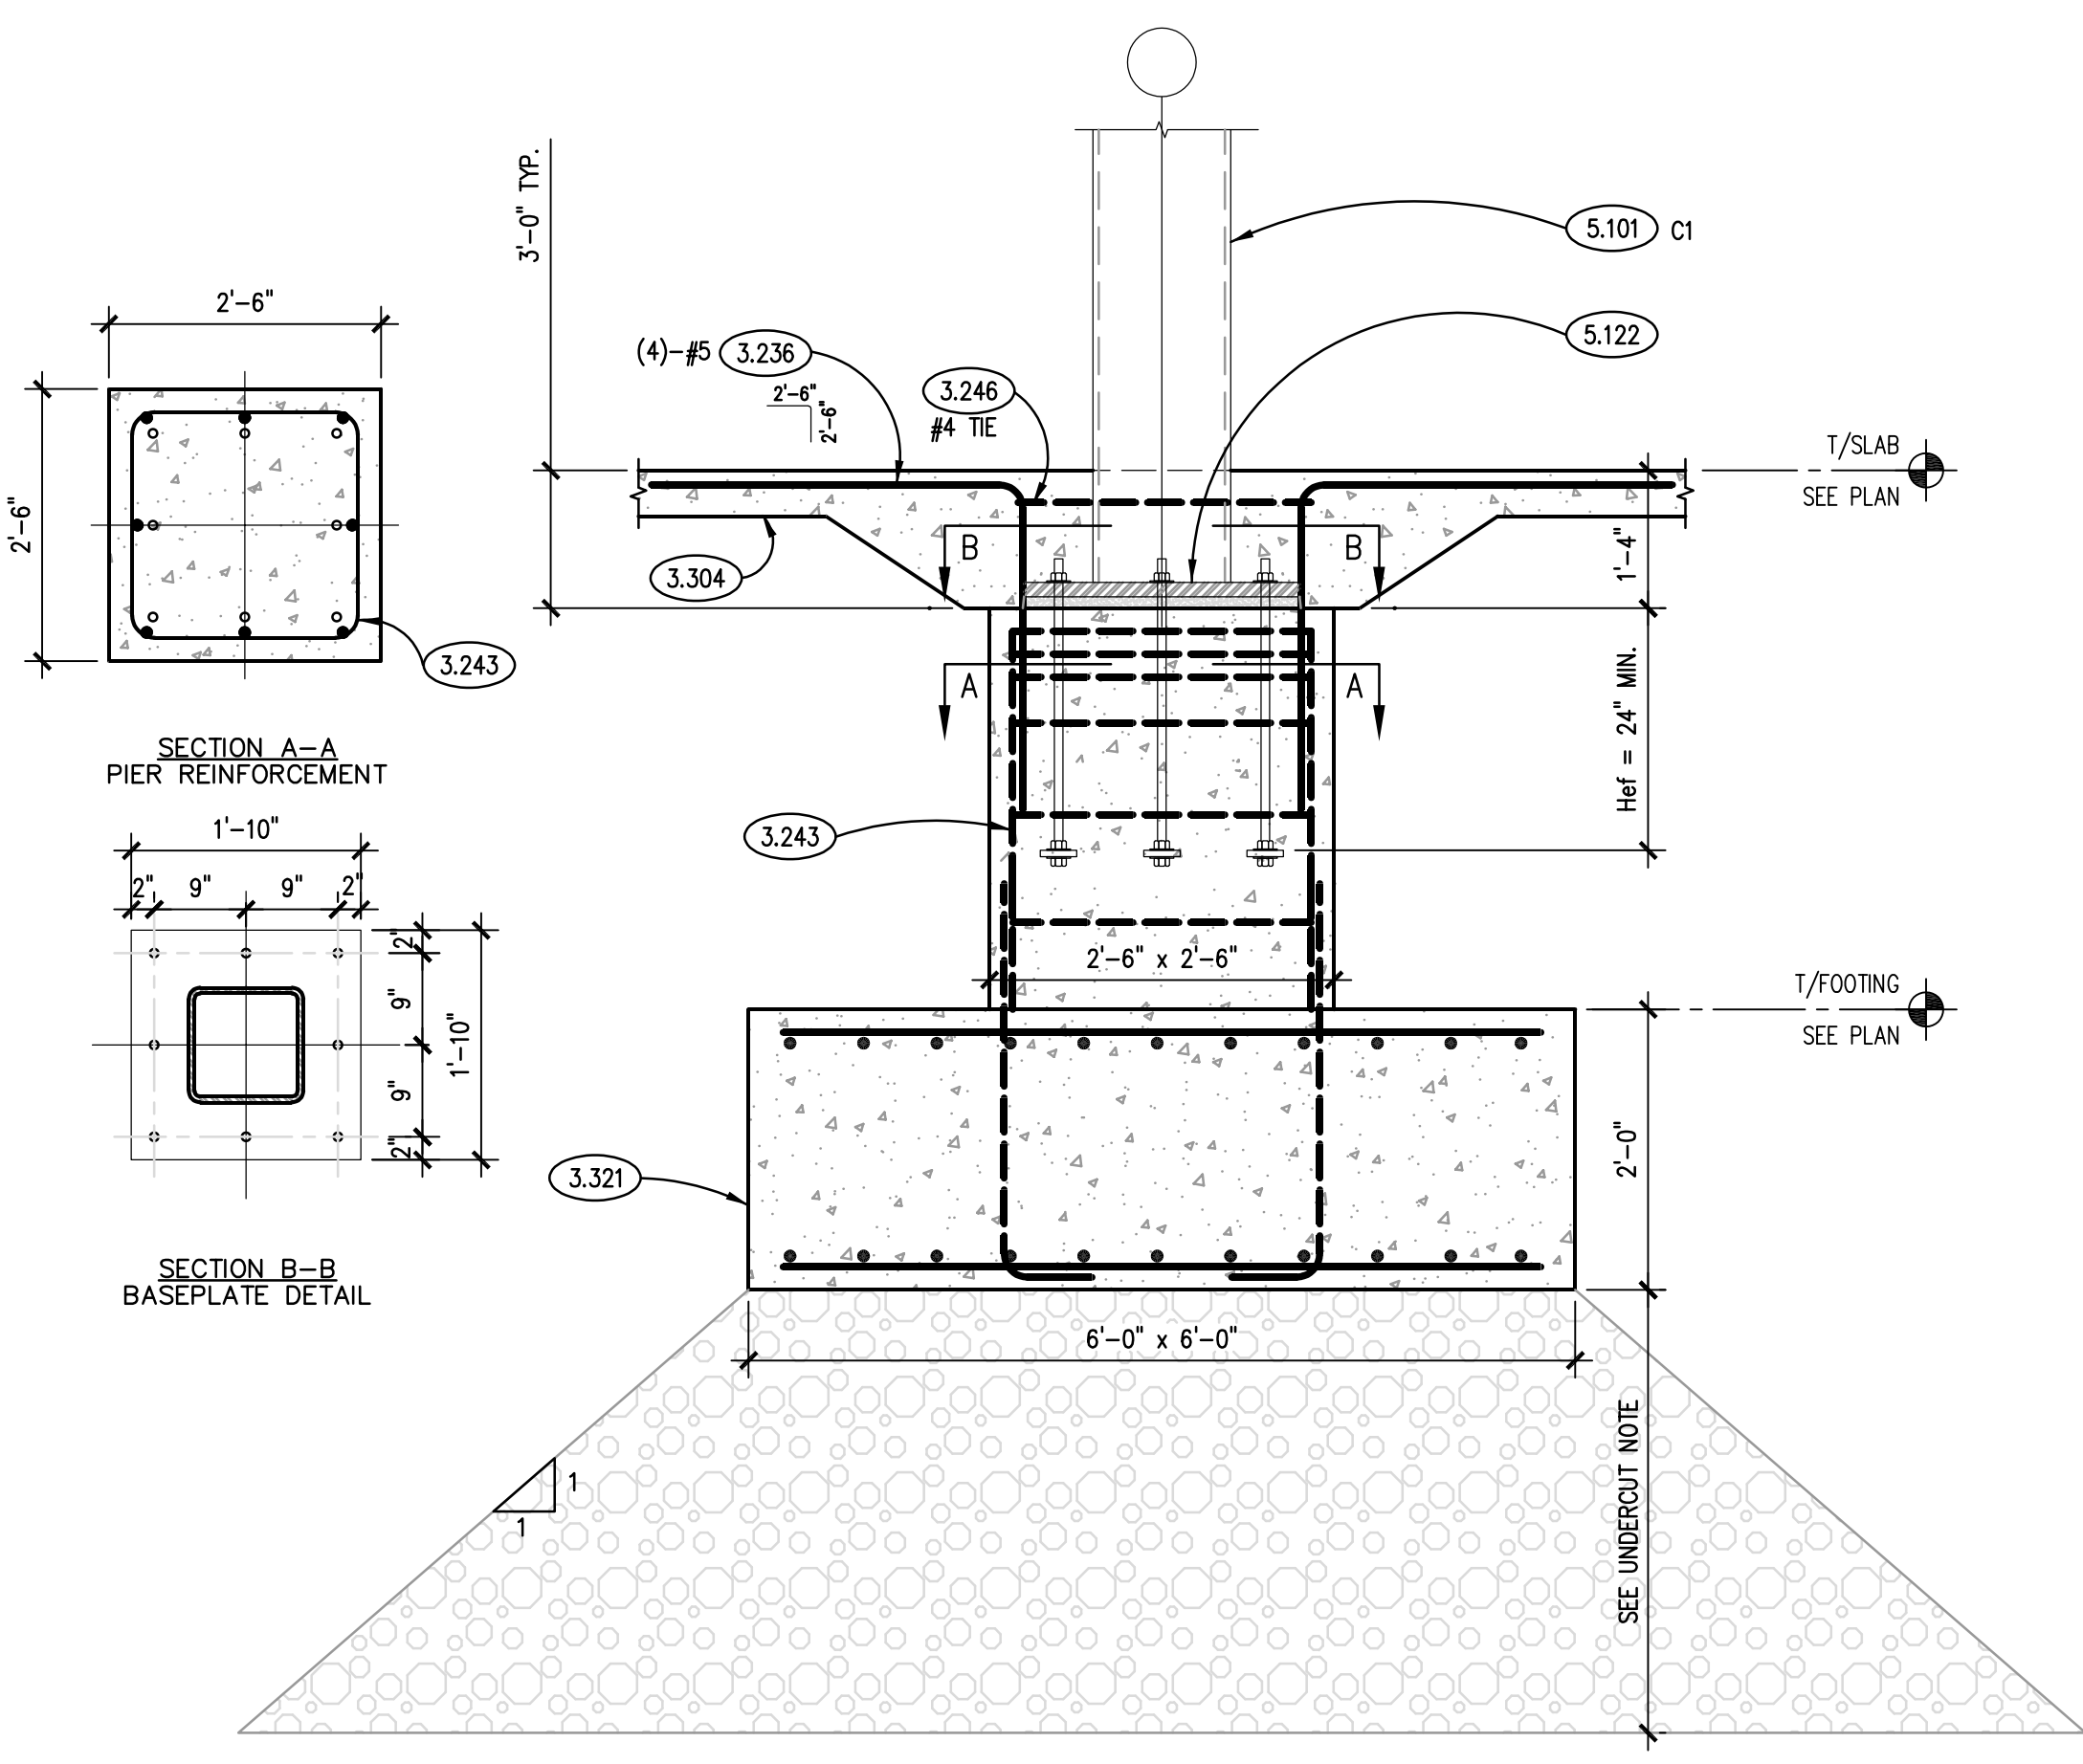


UNDERCUT NOTE: SOIL BEARING CAPACITY SHALL BE CONFIRMED AT THE TIME OF EXCAVATION PRIOR TO FORMING SPREAD FOOTINGS. SHOULD AN ALLOWABLE BEARING CAPACITY OF 3,000 PSF NOT BE DETERMINED, UNDERCUTTING AND BACKFILL OF ENGINEERED FILL SHALL BE PERFORMED IN ACCORDANCE WITH SOILS REPORT. FOR BIDDING PURPOSES, AN ESTIMATED UNDERCUT OF 3'-0" SHALL BE ASSUMED FOR ALL FOUR CANOPY FOOTINGS.

TYPICAL SPREAD FOOTING SECTION SCALE: N.T.S. 4

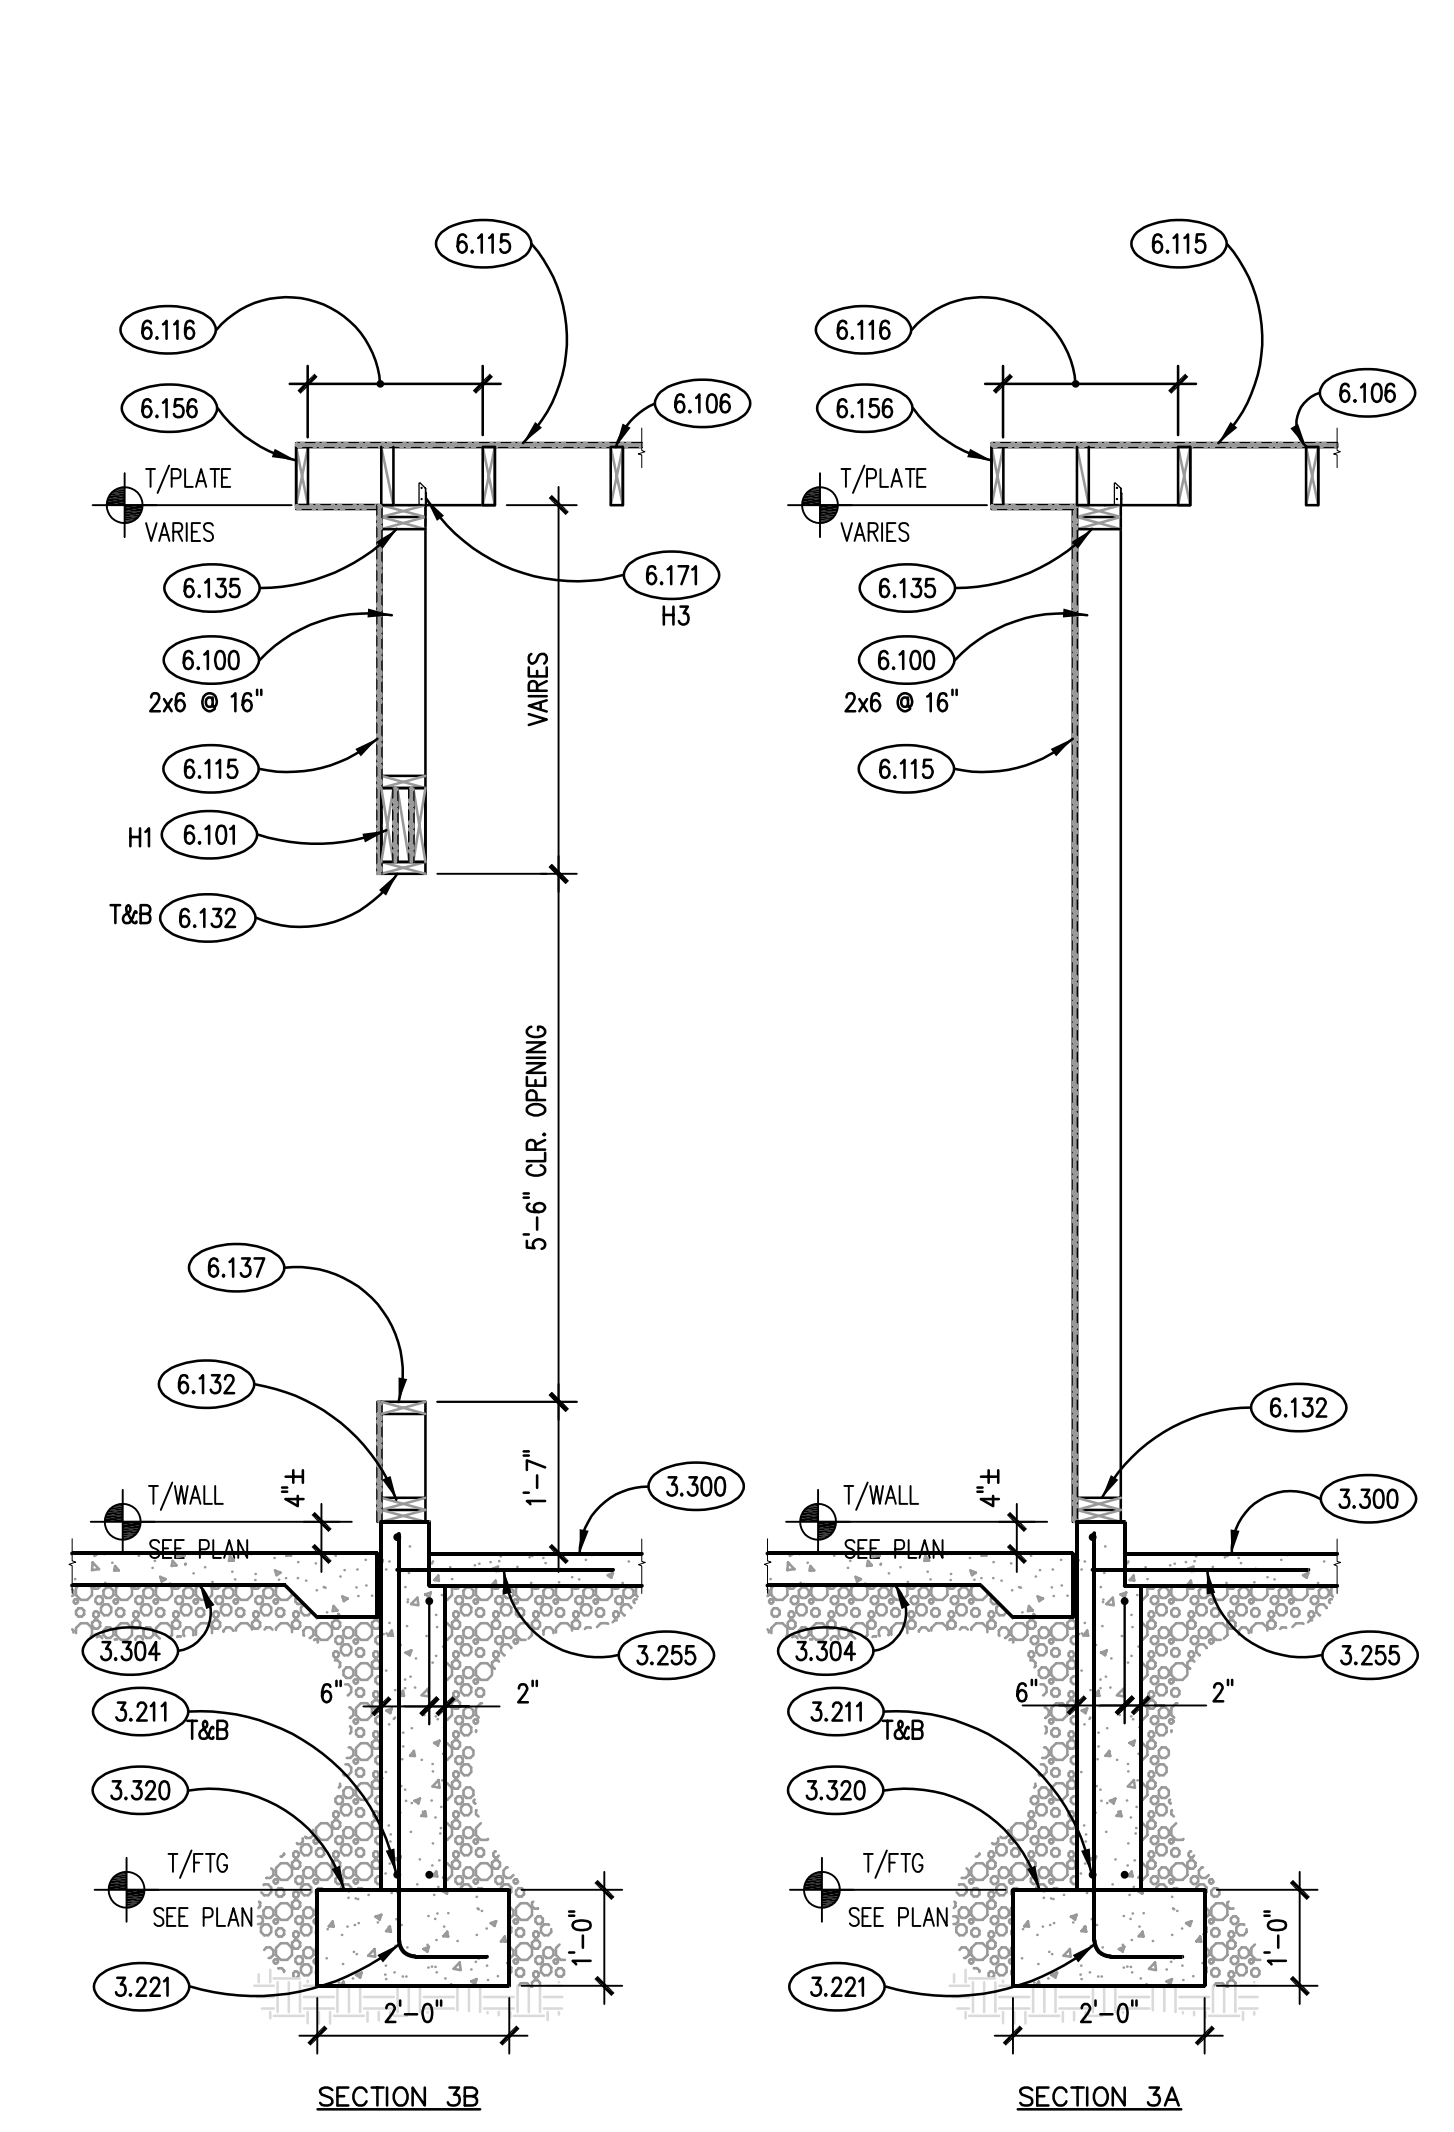


SECTION AT SHED SCALE: 1/2" = 1'-0" 3

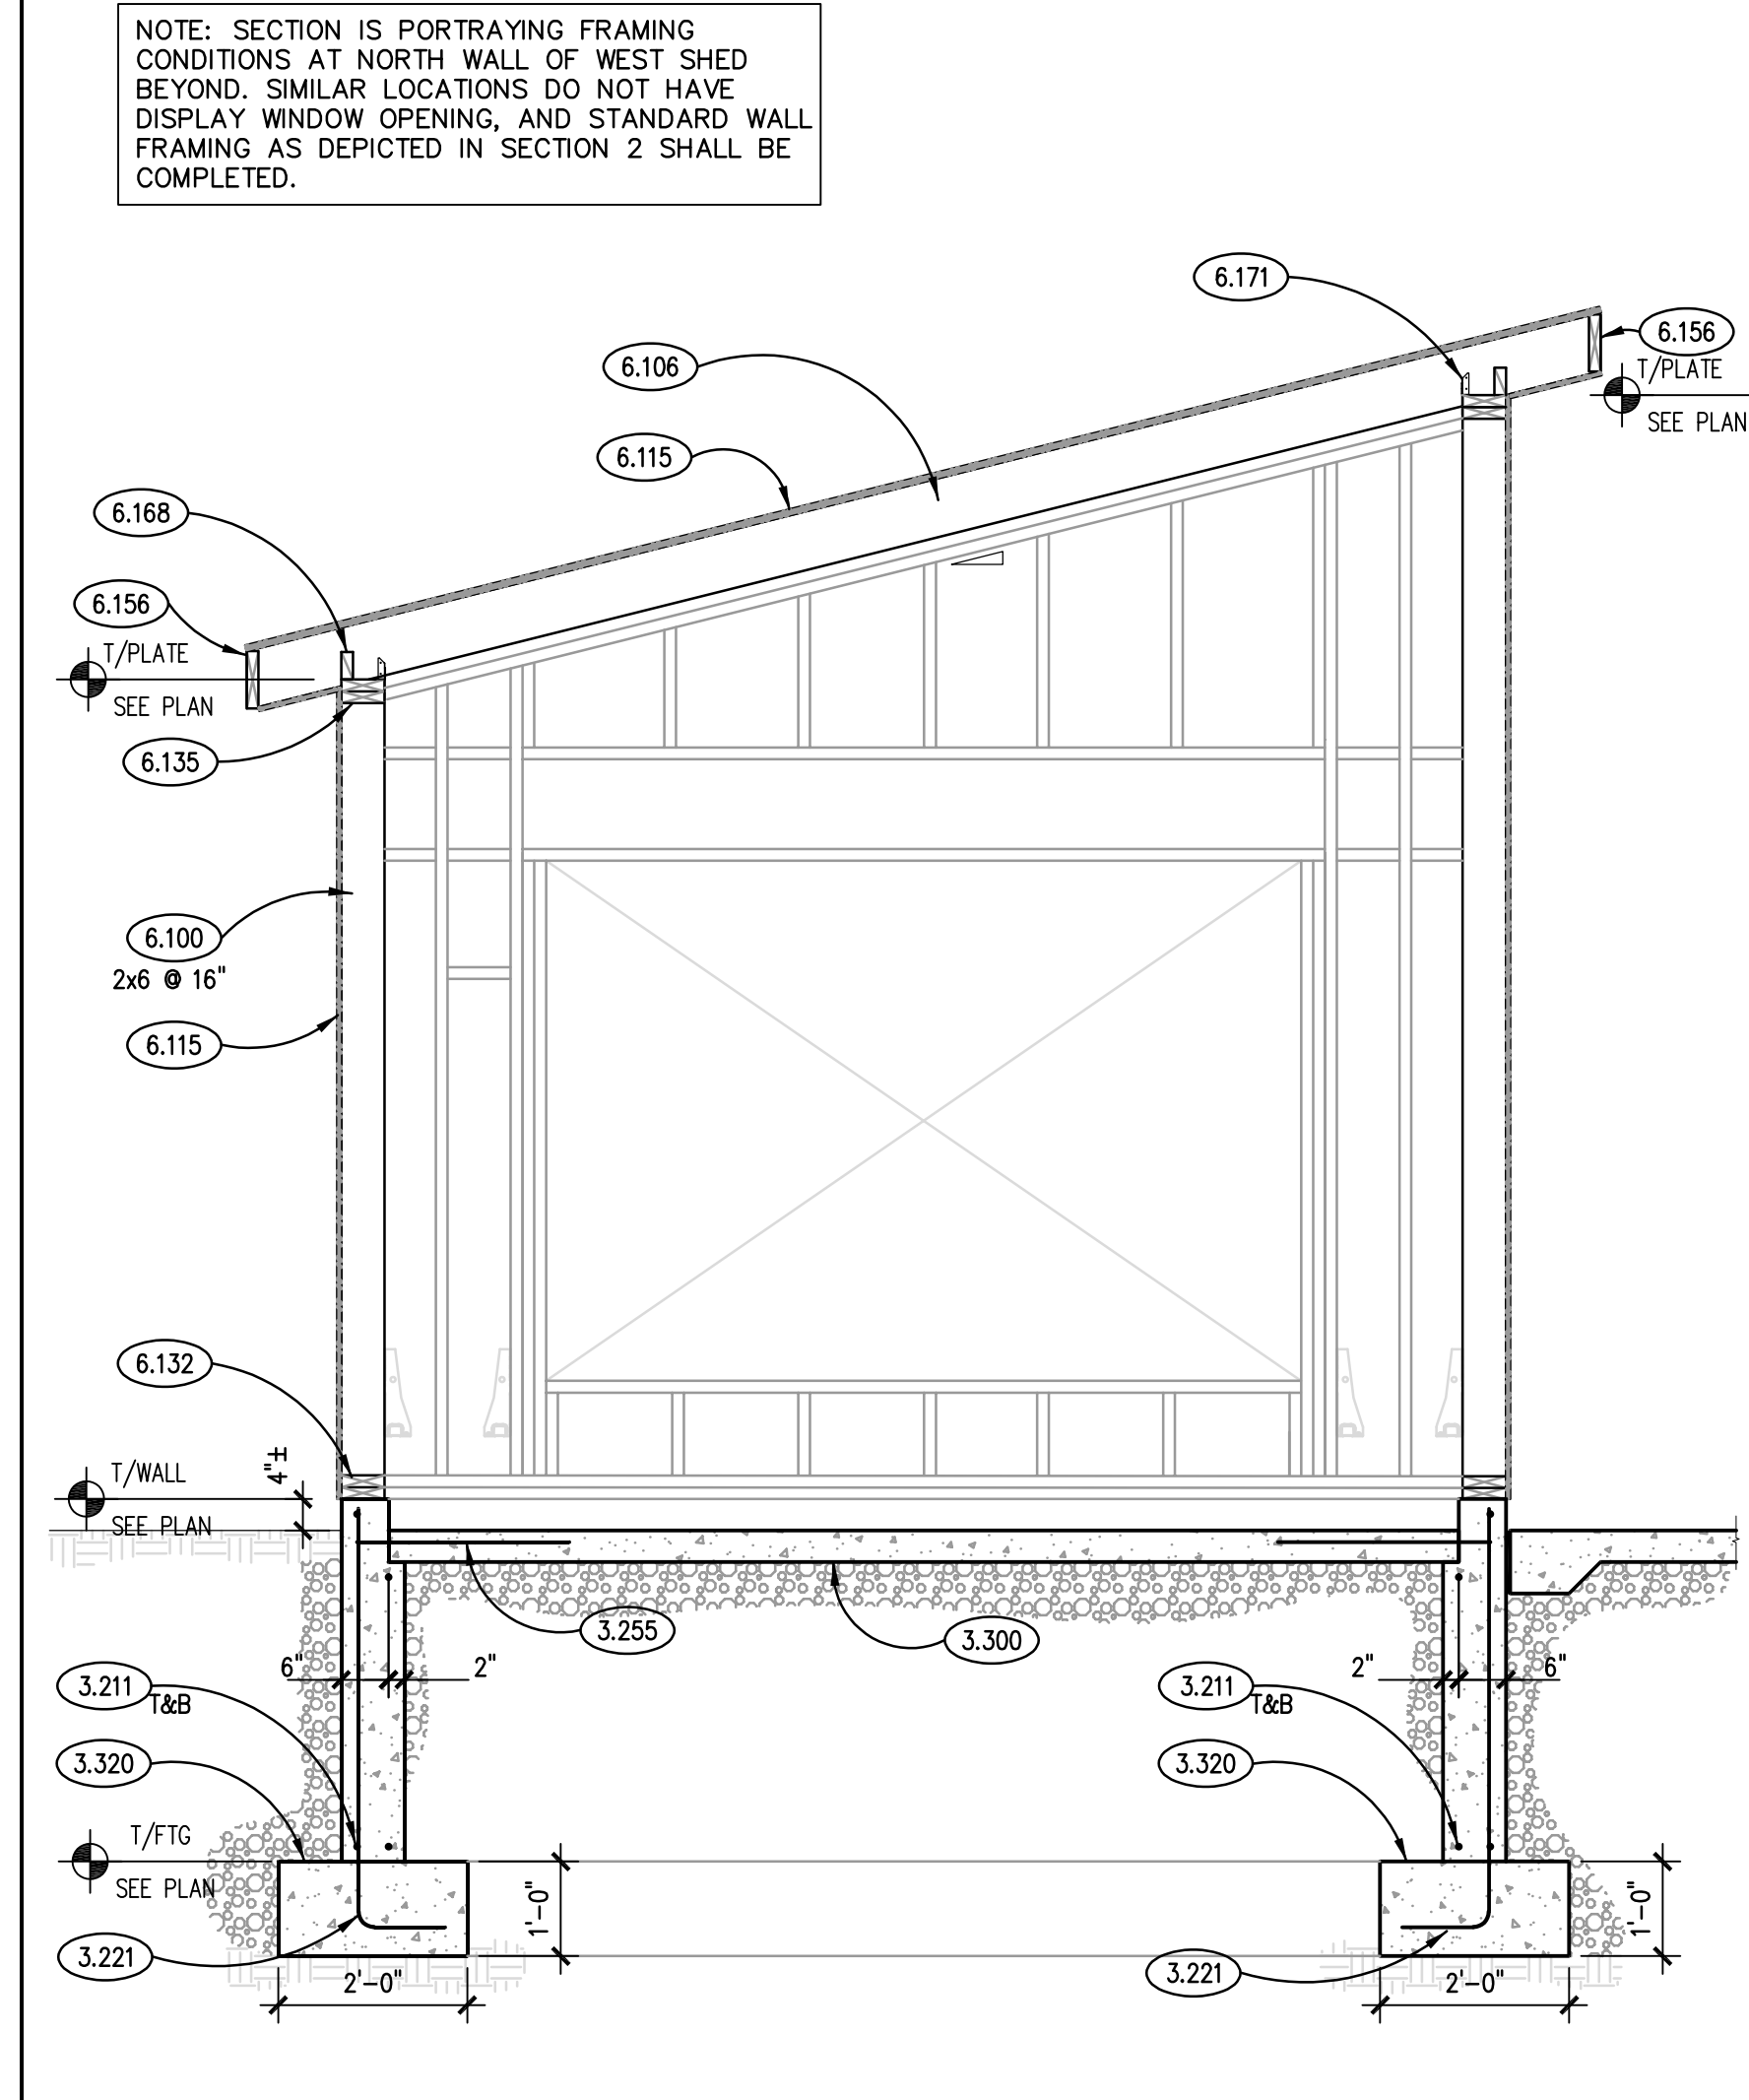

SECTION AT SHED SCALE: 1/2" = 1'-0" 2

- KEYNOTES: 3.211 CONCRETE REINFORCING: CONTINUOUS WALL/FOOTING REINFORCING... 3.221 CONCRETE REINFORCING: #4 DOWELS @ 1'-4" O.C. HORIZONTAL... 3.236 CONCRETE REINFORCING: #5 PIER DOWELS AS NOTED HOOKED INTO FOOTING... 5.101 STRUCTURAL STEEL: STEEL COLUMN... 5.122 STRUCTURAL STEEL: BASEPLATE & SETTING PLATE...

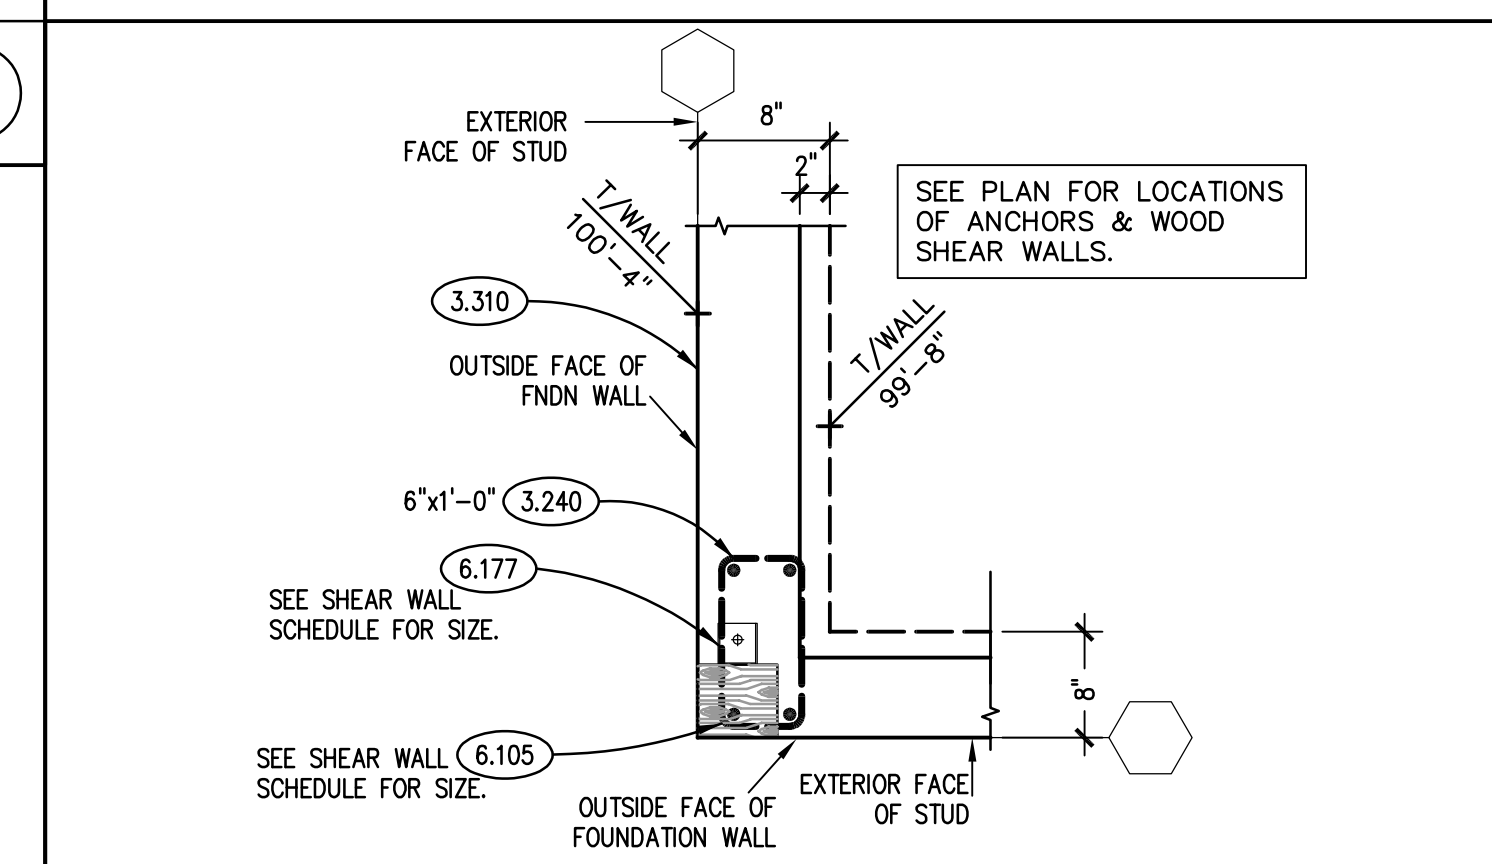


FNDN WALL REINFORCEMENT DETAIL SCALE: N.T.S. 6

SPREAD FOOTING SCHEDULE table with columns: MARK, DIMENSIONS (LENGTH, WIDTH, THICK), REINFORCING STEEL (BOTTOM LENGTH, BOTTOM WIDTH, TOP), SPECIAL COMMENTS.

SPREAD FOOTING NOTES AND DETAILS


- NOTES: 1. SEE PLAN FOR FOOTING LOCATIONS. 2. FOOTING SIZES BASED UPON NOTE F12 INDICATED ON SHEET S010... 3. CONTRACTOR TO HAVE A QUALIFIED SOIL TESTING AGENCY CONFIRM THE SOIL AT THE BASE OF THE FOOTING EXCAVATIONS PRIOR TO CASTING THE CONCRETE...

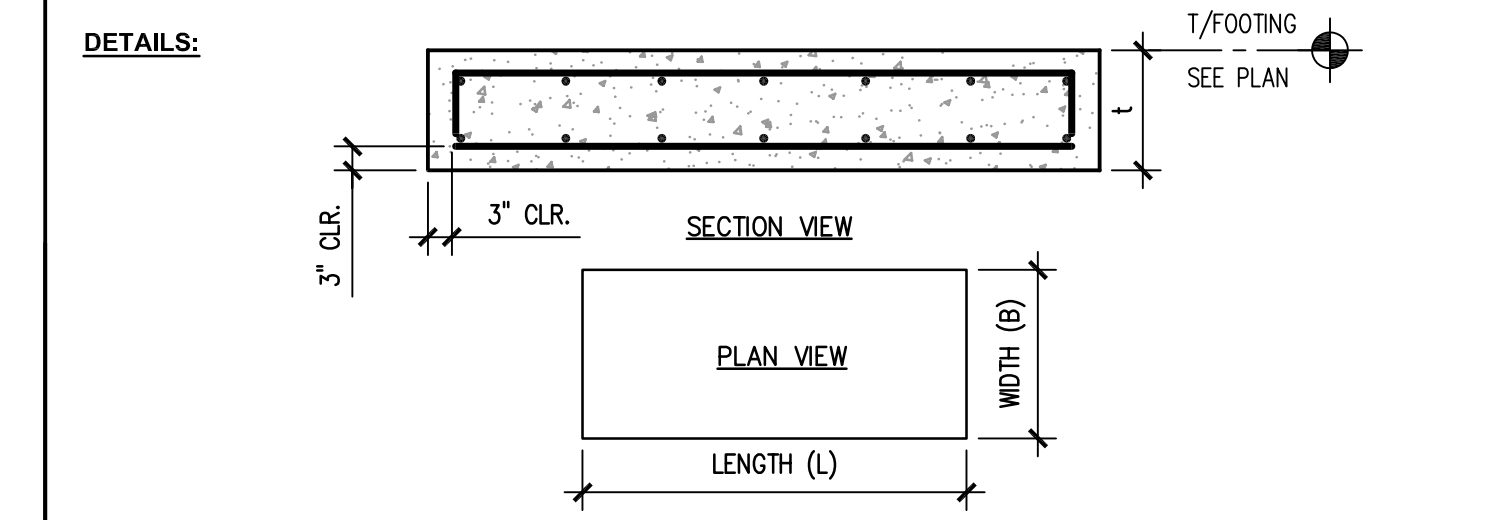

SLAB SCHEDULE AND NOTES

SLAB SCHEDULE AND NOTES table with columns: MARK, THICK, CONCRETE STRENGTH, CONCRETE TYPE, REINFORCING STEEL, GENERAL LOCATIONS, SPECIAL COMMENTS OR ADDITIONAL LOCATIONS.

- NOTES: 1. SEE PROJECT SPECIFICATIONS FOR DETAILED MIX DESIGNS. 2. PREPARE ALL SLAB ON GRADE SUB-GRADES AS INDICATED ON SHEET S010. 3. ALL SLABS ON GRADE TO BE PLACED OVER 6" OF CLEAN, WELL GRADED GRANULAR MATERIALS...

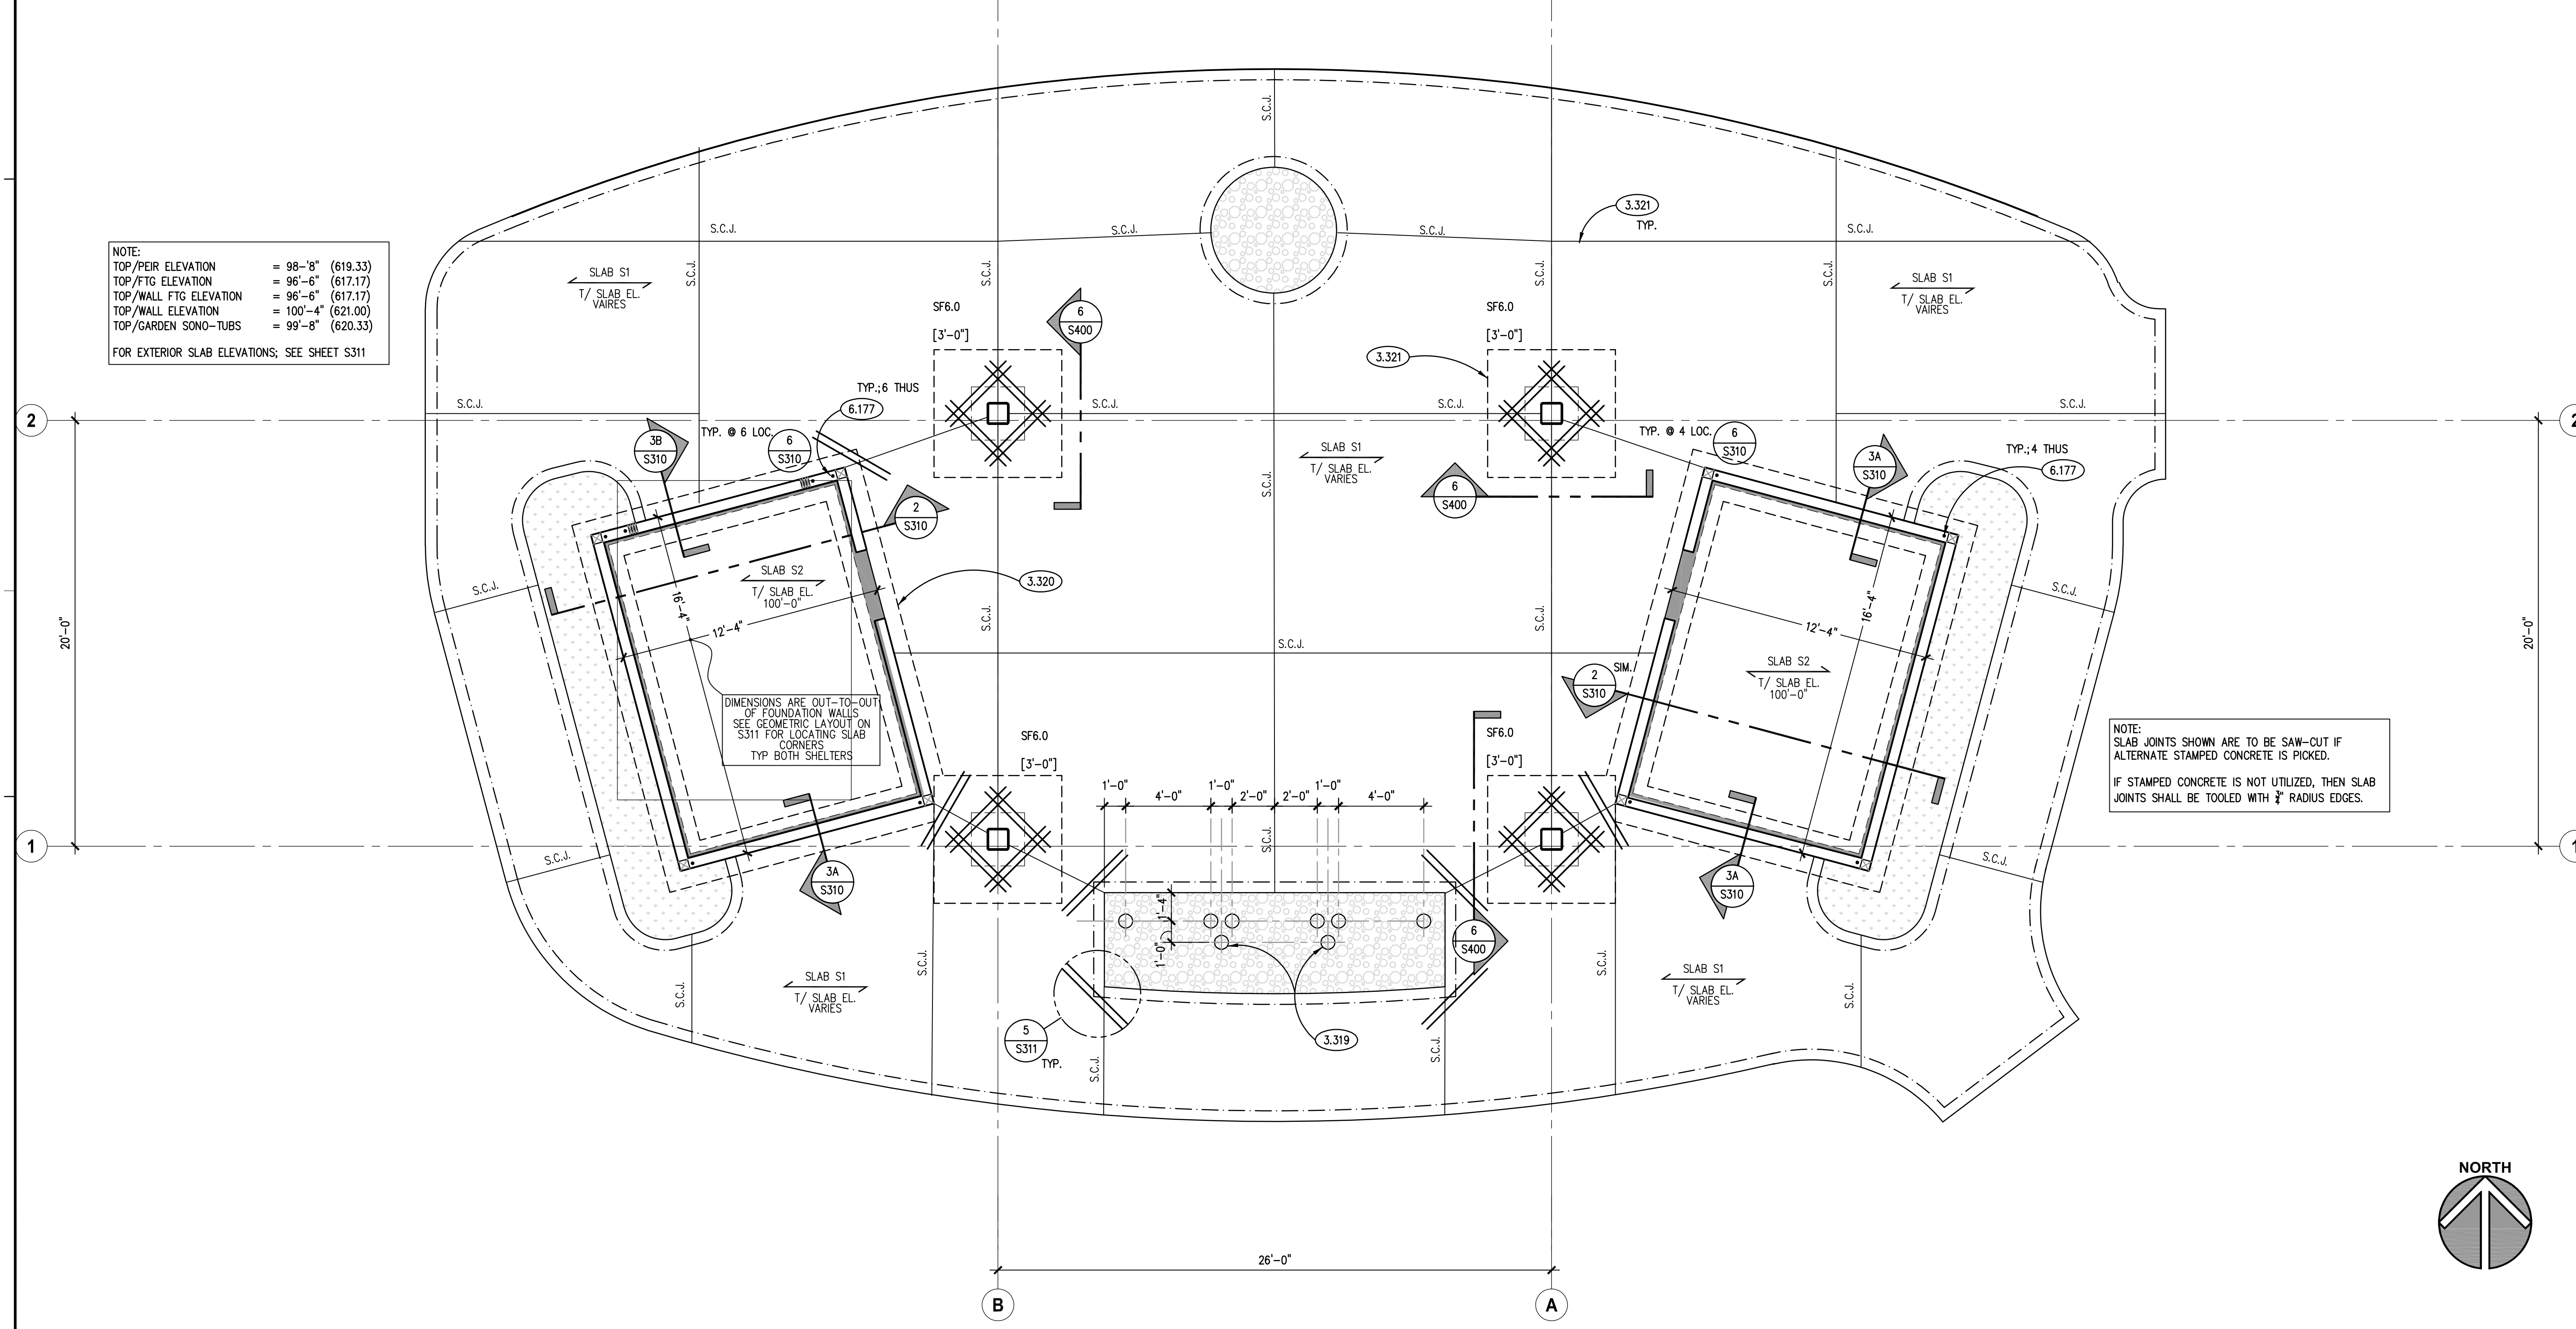

FOUNDATION AND SLAB PLAN SCALE: 1/4" = 1'-0" 1




KLUBER, INC. Aurora, Illinois 60506 Tel: 630.306.5213 Bloomington, Illinois 61714 Tel: 309.303.6400 www.klubertec.com

SUBAT NATURE CENTER KENDALL COUNTY FOREST PRESERVE DISTRICT 4675 ELDAMAIN ROAD PLANO, IL 60545

Project information table including JOB NO. 23-429-1495, DRAWN KSG, CHECKED JMB, APPROVED JMB, SHEET TITLE FOUNDATION & SLAB PLAN, SECTIONS AND DETAILS, SHEET NUMBER S310.

NOTE: EACH NORTH/SOUTH & EAST/WEST TERMINATING CHORD END HAS BEEN LOCATED OFF OF THE CANOPY GRID LINES. THE ARC HEIGHTS OR CIRCULAR SAGITTA DIMENSIONS TAKEN ORTHOGONAL FROM EACH CHORD TO ITS CORRESPONDING ARC HAS BEEN PROVIDED FOR DEVELOPMENT OF RADIAL EDGES.

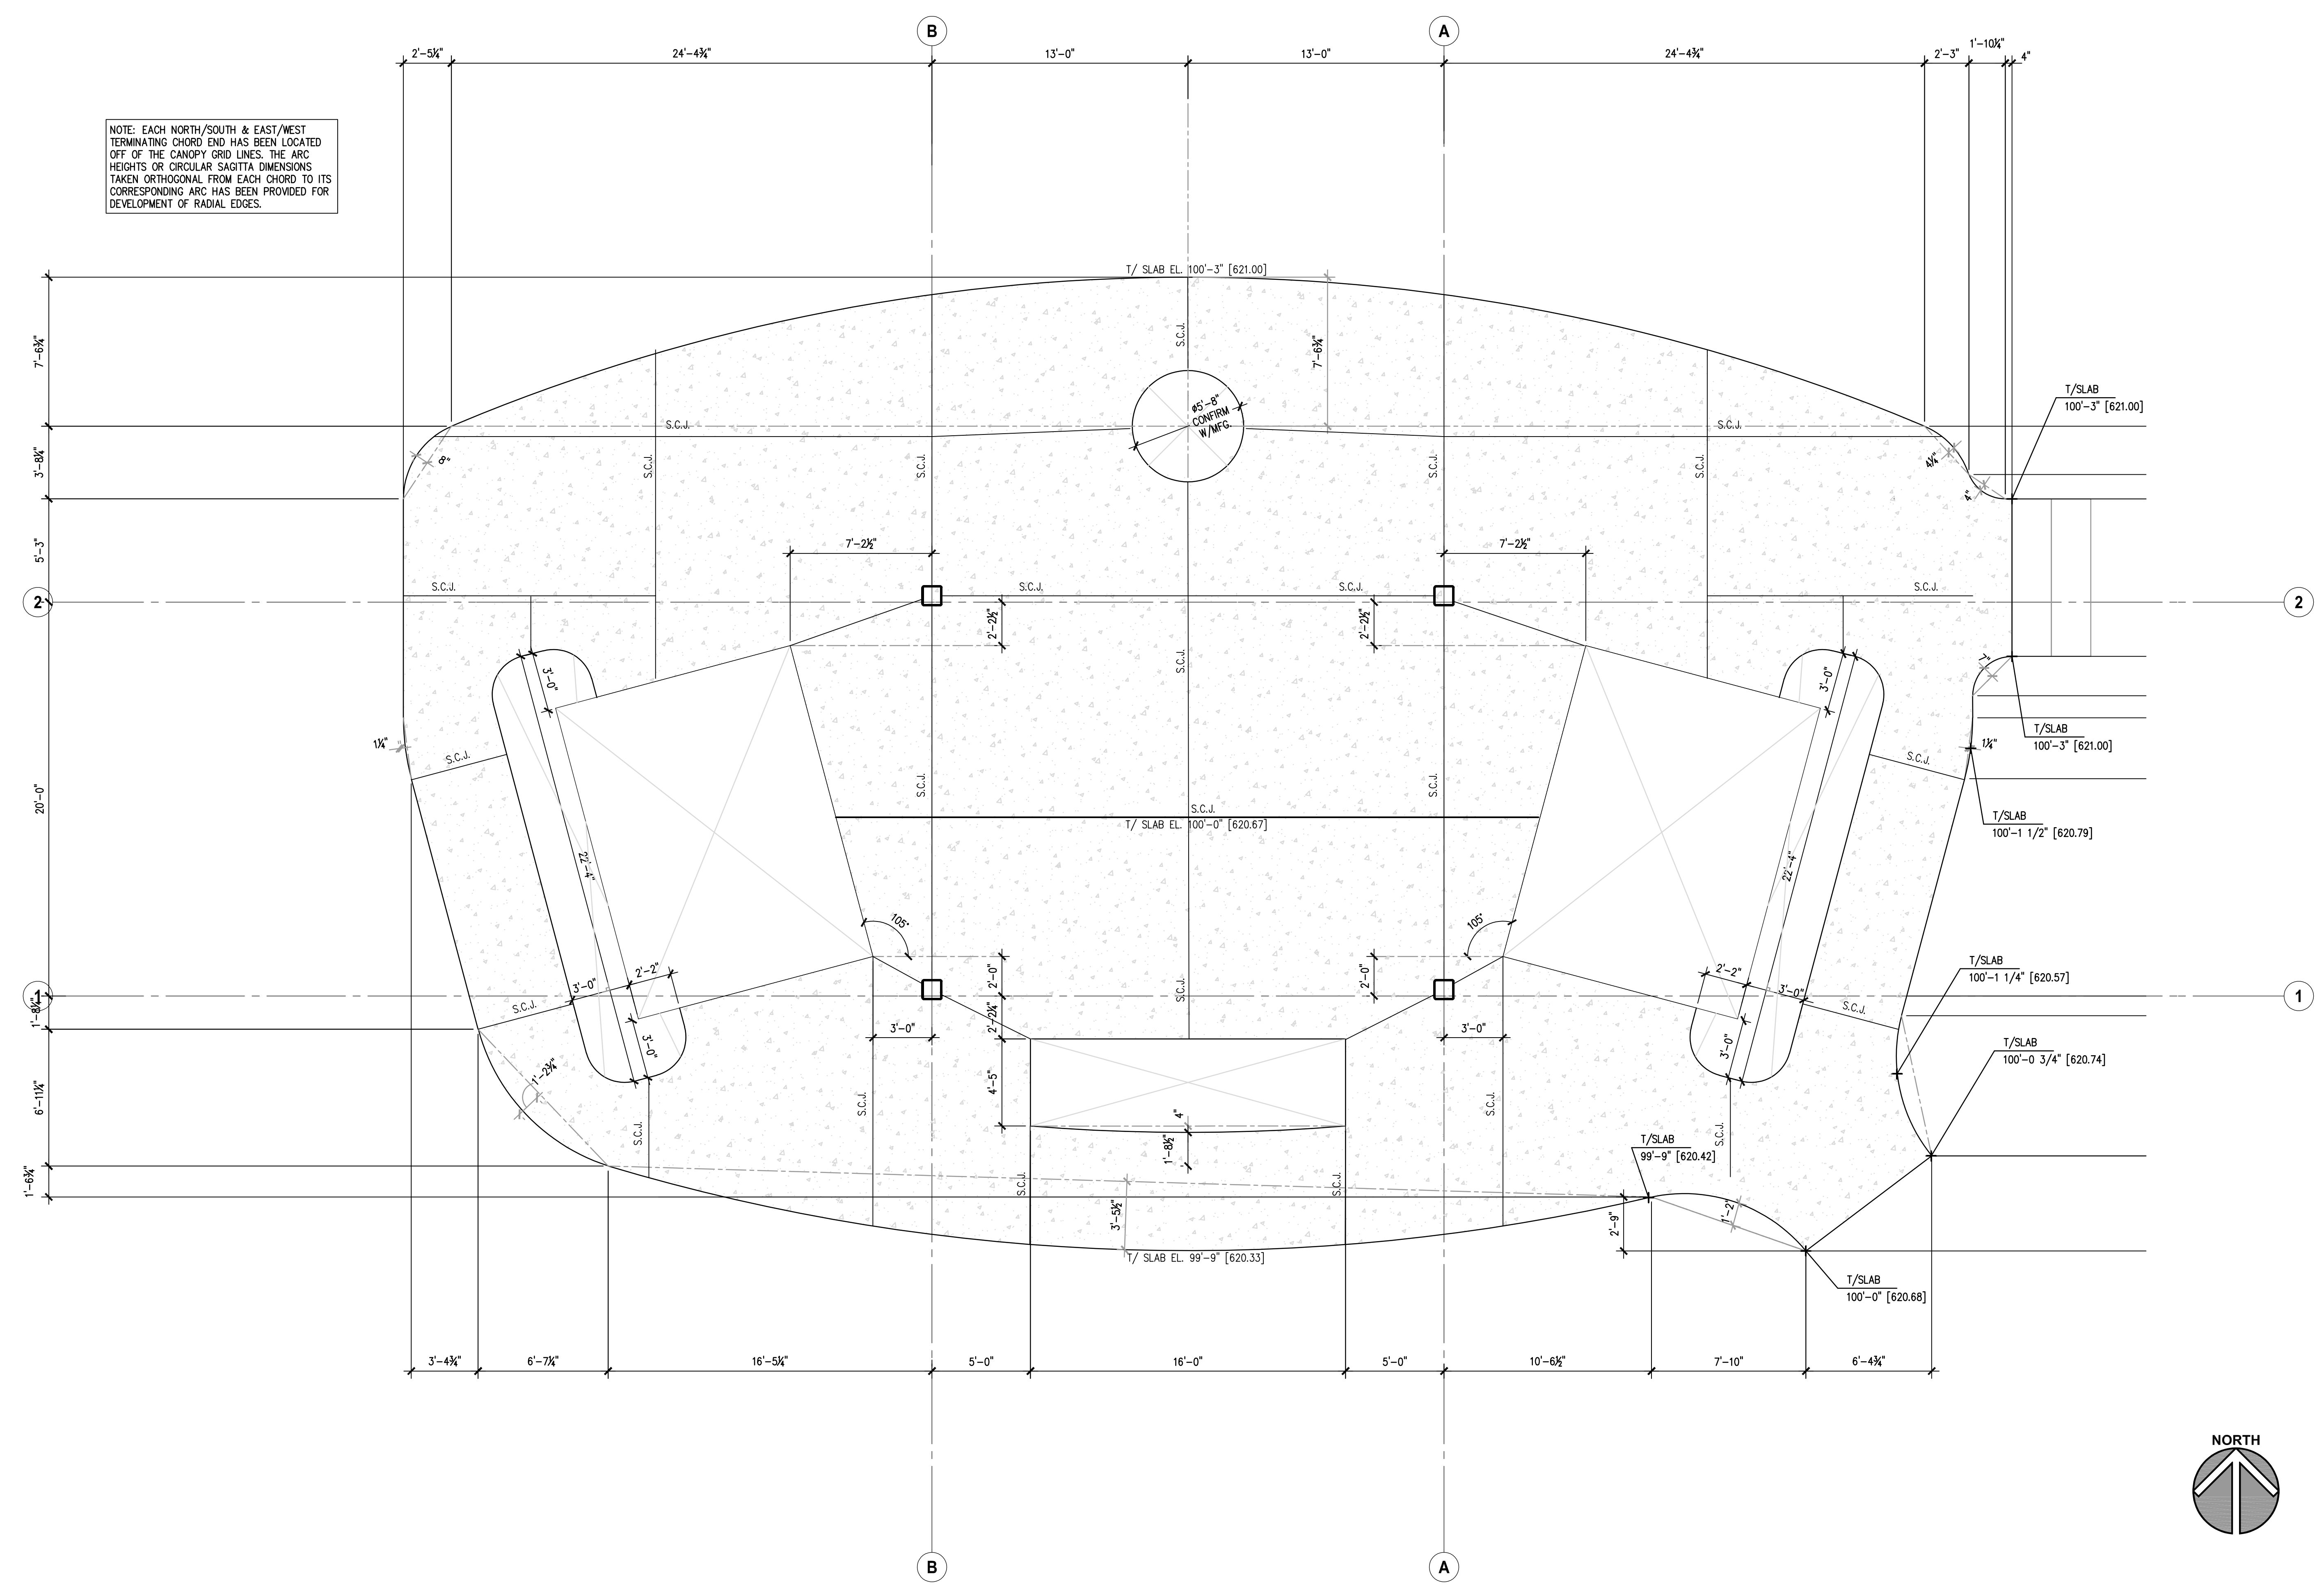

KEYNOTES


KEYNOTES ARE TYPICALLY NOT DUPLICATED WITHIN A GIVEN DETAIL. AN UN-KEYNOTED ITEM IN A DETAIL IS THE SAME AS A KEYNOTED ITEM HAVING THE SAME APPEARANCE WITHIN THE SAME DETAIL.

- 3.110 CONCRETE FORMING AND ACCESSORIES: CONTINUOUS 2x4 KEYWAY U.N.O.
3.111 CONCRETE FORMING AND ACCESSORIES: CONTINUOUS 3/4" CHAMFER U.N.O.
3.113 CONCRETE FORMING AND ACCESSORIES: CONTINUOUS RADIUS EDGE. PROVIDE 3/4" RADIUS U.N.O.
3.120 CONCRETE FORMING AND ACCESSORIES: 1/4" DIAMOND DOWEL SYSTEM @ 1'-0" O.C.
3.211 CONCRETE REINFORCING: CONTINUOUS WALL/FOOTING REINFORCING. REFER TO SECTIONS AND SCHEDULES. PROVIDE (2) #5 BARS U.N.O. OR DEPICTED.
3.212 CONCRETE REINFORCING: LAP REINFORCING BAR TO MATCH SIZE, SPACING AND QUANTITY OF WALL/FOOTING REINFORCING.
3.213 CONCRETE REINFORCING: CORNER/INTERSECTION BARS TO MATCH SIZE, SPACING AND QUANTITY OF WALL/FOOTING REINFORCING. PROVIDE IN ALL ELEMENTS WITH LONGITUDINAL REINFORCING. REFER TO TYPICAL DETAIL ON CONTRACT DOCUMENTS.
3.214 CONCRETE REINFORCING: (2) #4x4'-0" LONG DOWELS CENTERED ON JOINT AND SLAB/WALL DEPTH.
3.215 CONCRETE REINFORCING: REINFORCING STEEL MAT. #5 @ 12" O.C. EACH WAY U.N.O.
3.216 CONCRETE REINFORCING: CONTINUOUS REINFORCING BAR. #5 U.N.O. QUANTITY AS DEPICTED.
3.221 CONCRETE REINFORCING: #4 DOWELS @ 1'-0" O.C. HORIZONTAL LEG= 2'-6", VERTICAL LEG= 2'-6" U.N.O.
3.250 CONCRETE REINFORCING: WWF REFER TO SLAB CALLOUT ON PLAN. PROVIDE WWF-6X6 W2.1 X W2.1 IN FLAT SHEETS U.N.O. PROVIDE PROPER SUPPORT AS REQUIRED TO MAINTAIN PLACEMENT AT NOTED ELEVATION. "PULL UP" METHOD DURING SLAB PLACEMENT NOT ACCEPTABLE. DISCONTINUE AT CONTRACTION AND CONSTRUCTION JOINTS.
3.260 CONCRETE REINFORCING: REINFORCING STEEL SUPPORT ELEMENT.
3.300 CAST-IN-PLACE CONCRETE: INTERIOR SLAB-ON-GRADE. REFER TO PLAN, SCHEDULE AND SPECIFICATIONS FOR THICKNESS, REINFORCING, MIX TYPE AND FINISH.
3.303 CAST-IN-PLACE CONCRETE: EXTERIOR SLAB-ON-GRADE. REFER TO SPECIFICATIONS FOR MIX TYPE AND FINISH. REINFORCE WITH WWF-6X6 W2.1 X W2.1. SLOPE AWAY FROM BUILDING. ELEVATION AT DOOR AT MATCH INTERIOR SLAB/FINISH FLOOR ELEVATION.
3.310 CAST-IN-PLACE CONCRETE: FOUNDATION WALL. REFER TO PLAN, DETAILS AND SPECIFICATIONS FOR THICKNESS, REINFORCING, MIX TYPE AND FINISH.
3.320 CAST-IN-PLACE CONCRETE: CONTINUOUS WALL FOOTING. REFER TO PLAN, SCHEDULE AND SPECIFICATIONS FOR THICKNESS, REINFORCING AND MIX TYPE.
3.361 CAST-IN-PLACE CONCRETE JOINT DEVICE/FILLER: SLAB CONSTRUCTION JOINT.
3.362 CAST-IN-PLACE CONCRETE JOINT DEVICE/FILLER: SLAB CONTRACTION JOINT. SAWCUT 4-12 HOURS AFTER POUR. EMBEDDED PLASTIC STRIPS ALSO ACCEPTABLE.
3.363 CAST-IN-PLACE CONCRETE JOINT DEVICE/FILLER: SLAB JOINT SEALANT.
31.232 EXCAVATION FILL: ENGINEERED GRANULAR FILL.

Kluber Architects + Engineers






Kluber, Inc. Aurora, Illinois 60506 Tel: 630.346.5213

SUBAT NATURE CENTER KENDALL COUNTY FOREST PRESERVE DISTRICT 4675 ELDAIMAN ROAD PLANO, IL 60545

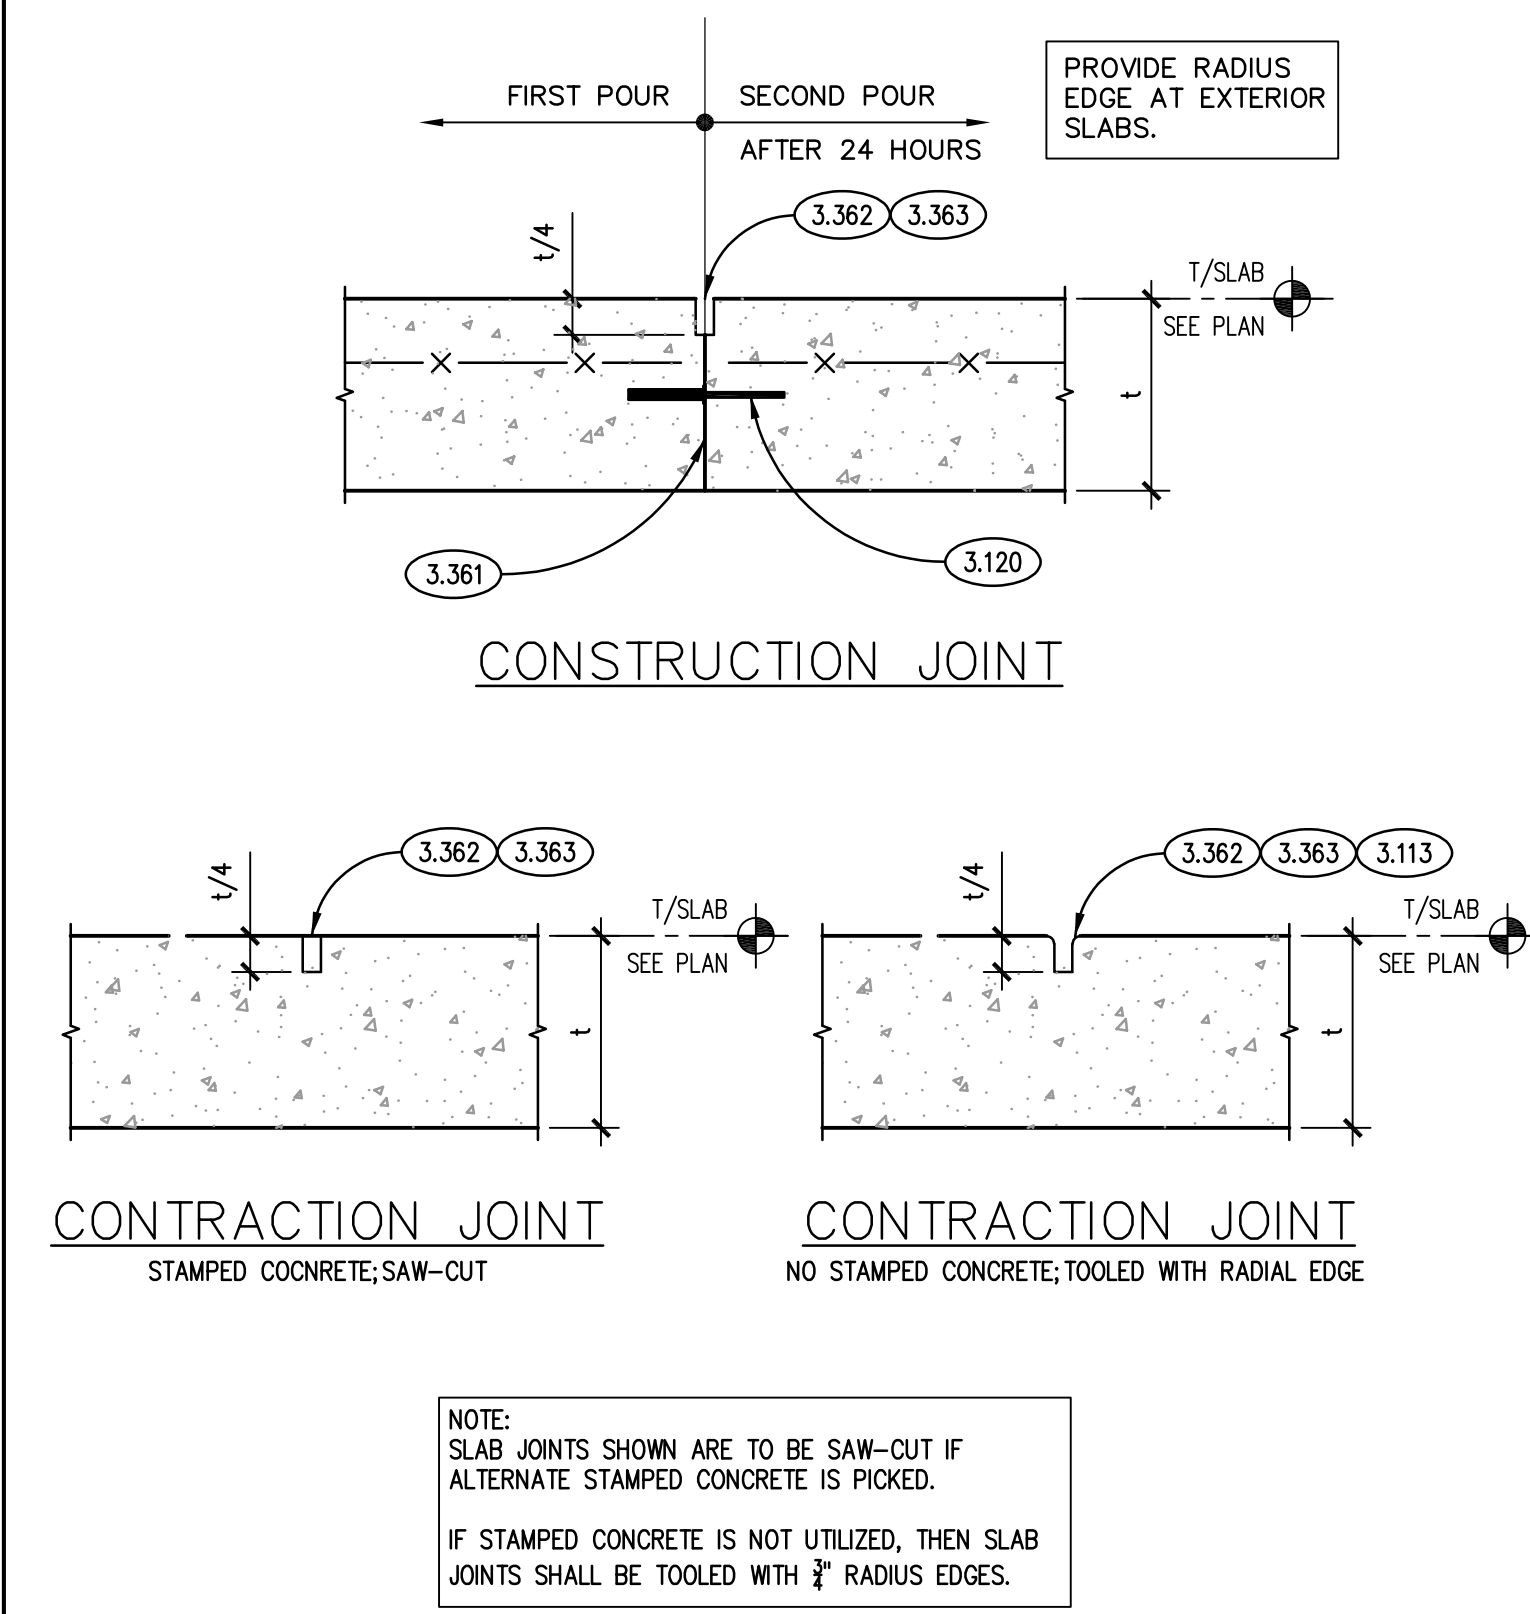

SLAB GEOMETRIC PLAN AND SPOT ELEVATIONS SCALE: 1/4" = 1'-0"

TYPICAL SLAB JOINT DETAILS SCALE: N.T.S.

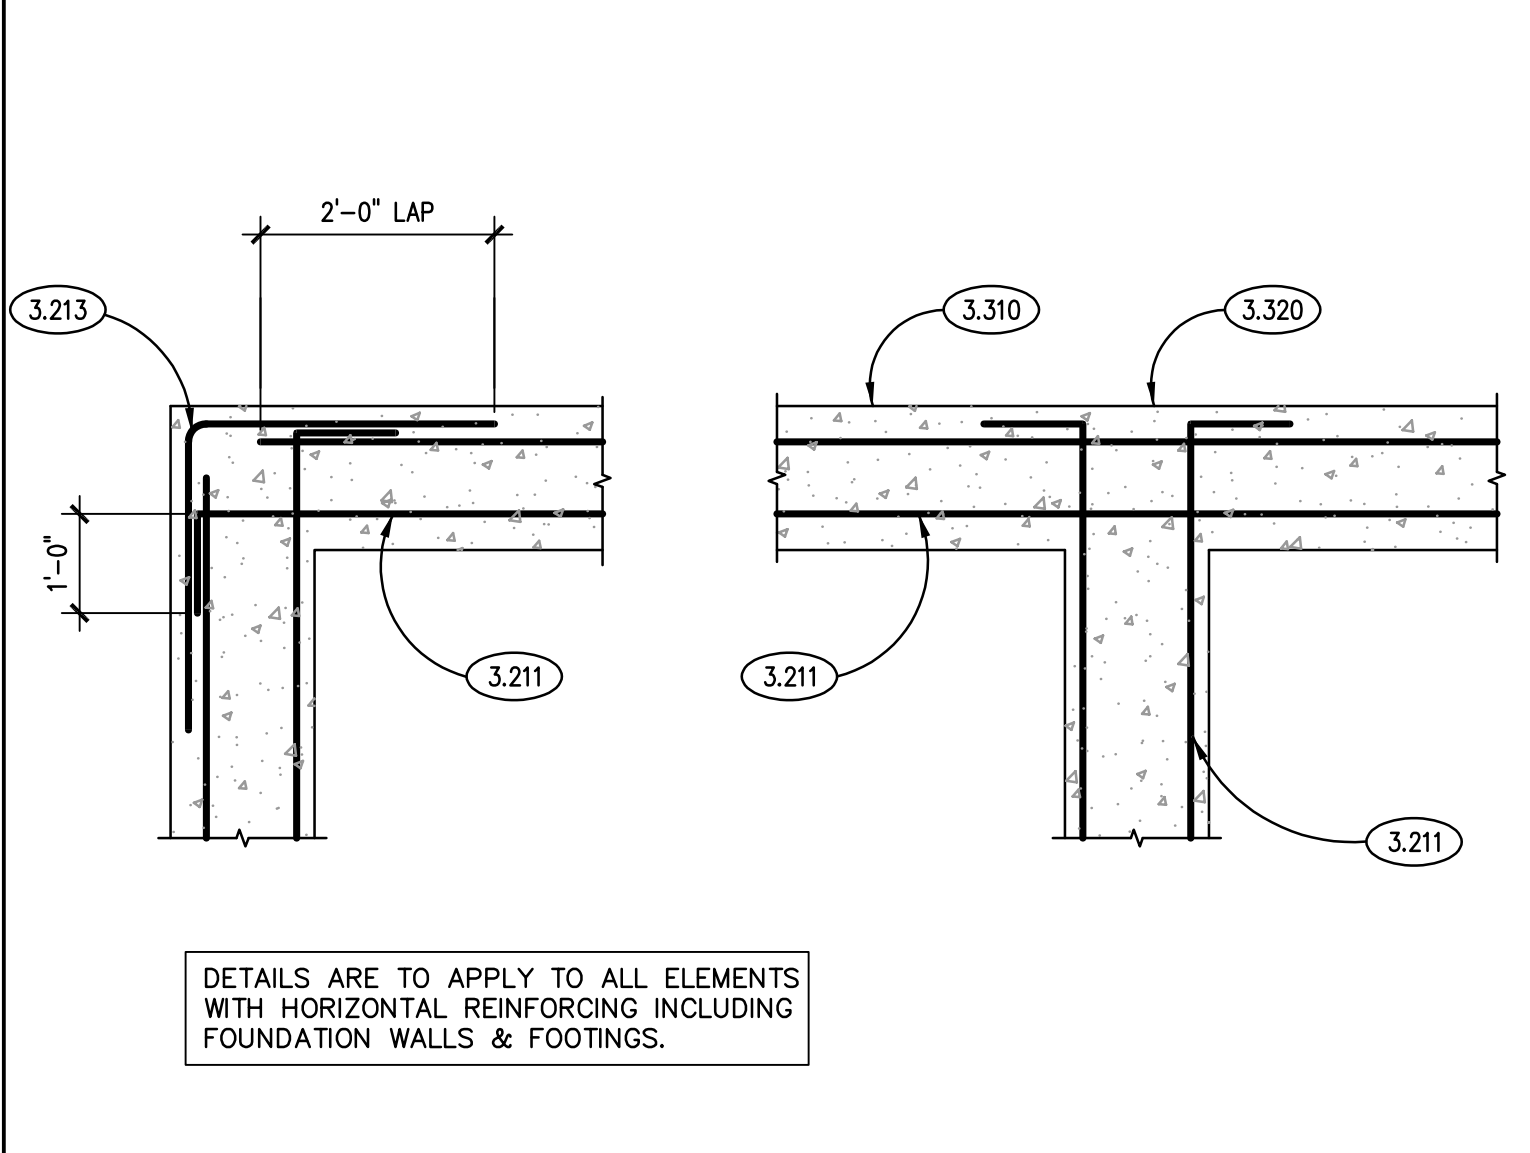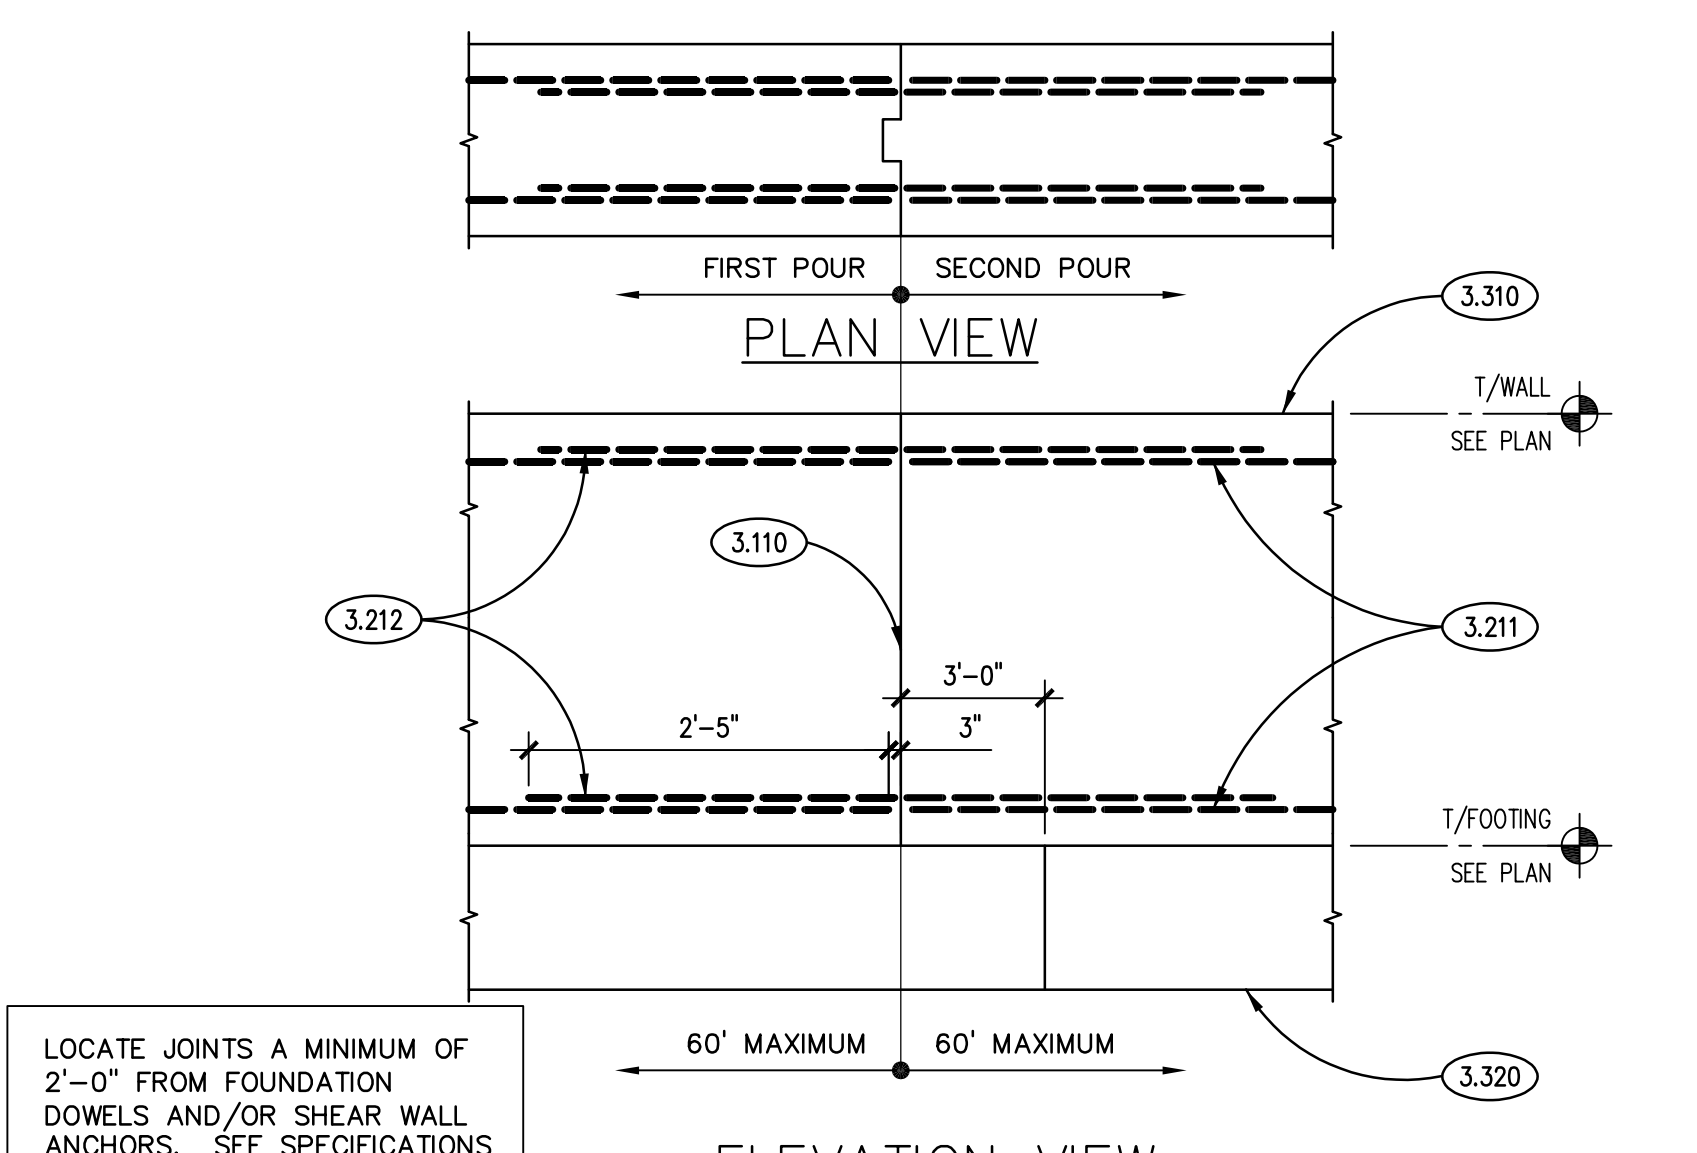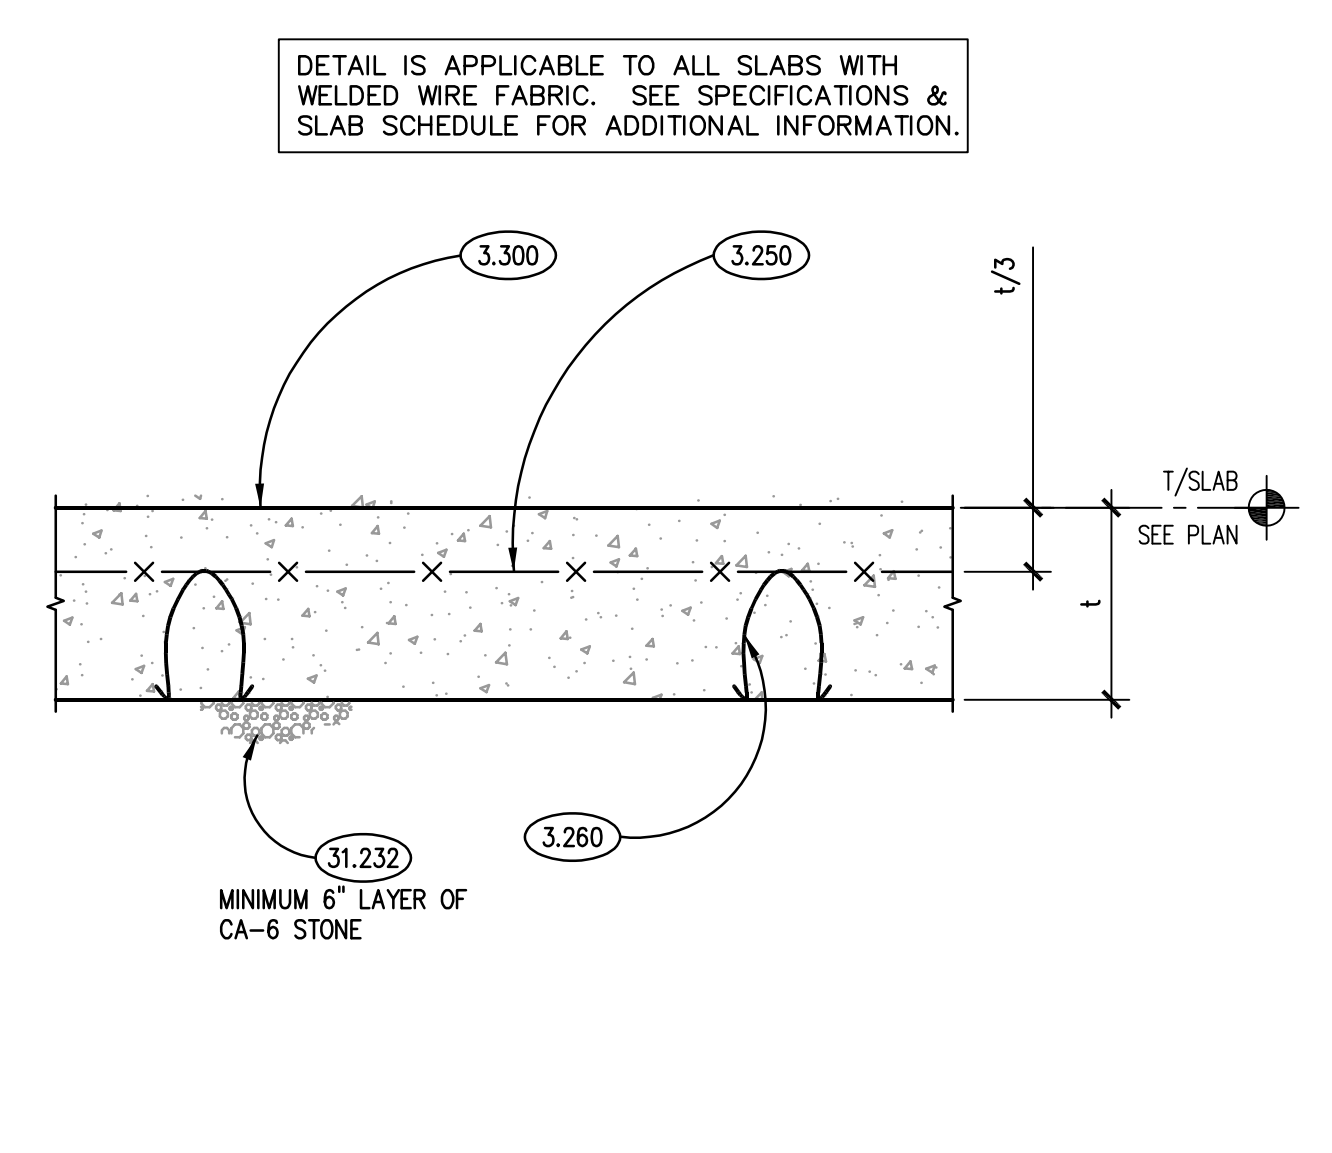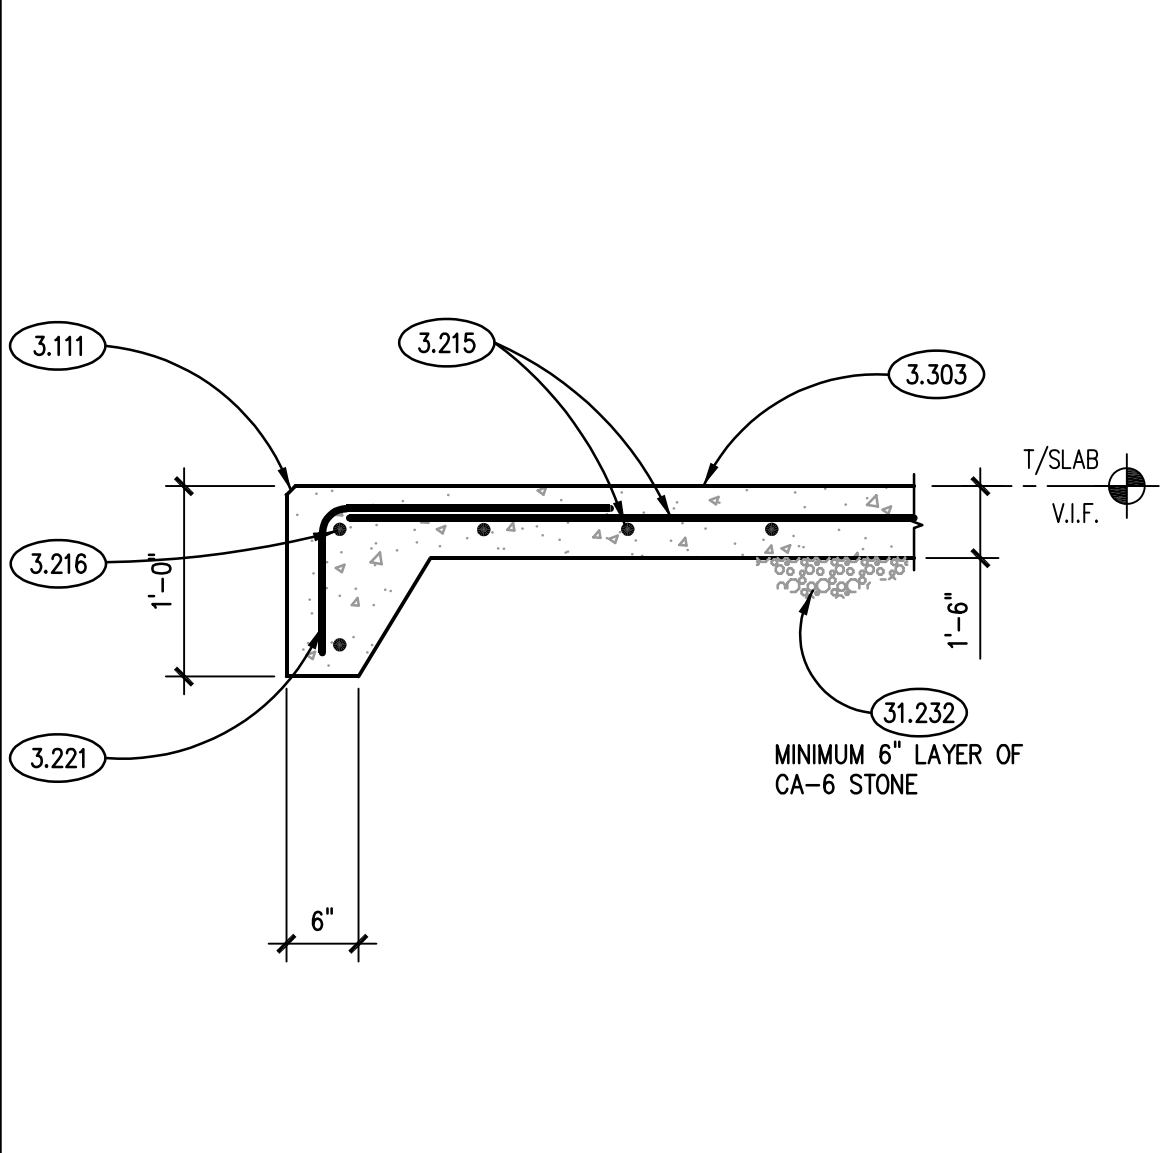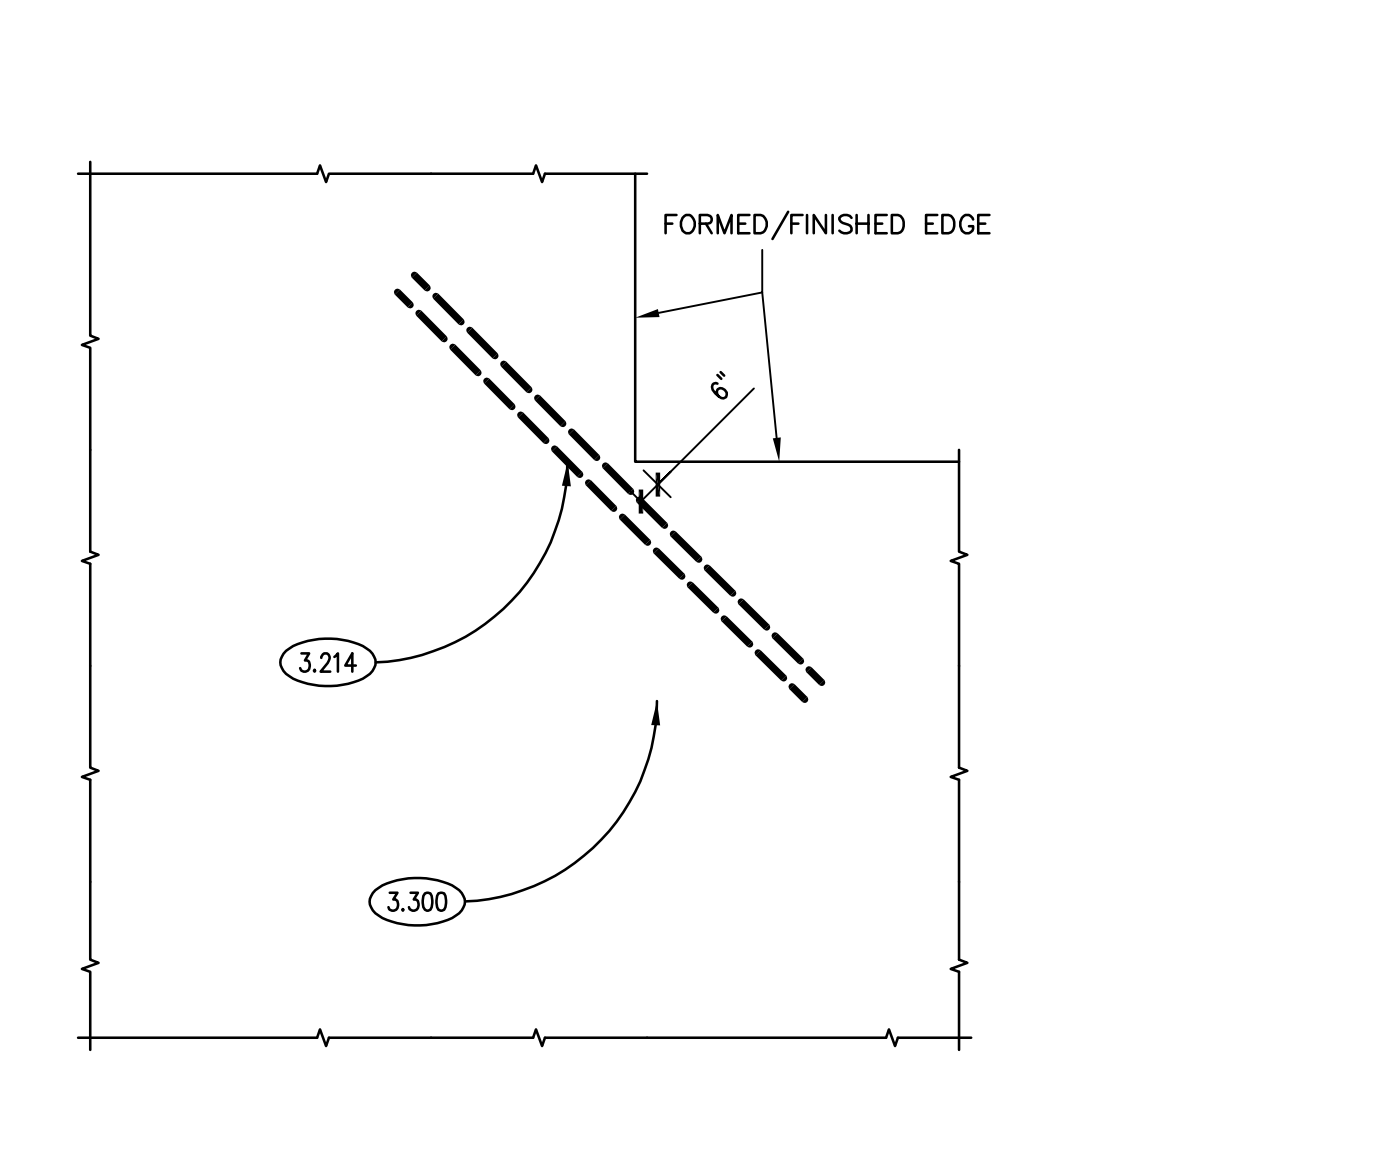

TYP. SLAB RE-ENTRANT CORNER BAR DETAIL SCALE: N.T.S.






TYP. THICKENED SLAB EDGE DETAIL SCALE: N.T.S.

TYPICAL SLAB ON GRADE DETAIL SCALE: N.T.S.

FND. WALL CONSTRUCTION JOINT DETAIL SCALE: N.T.S.

TYP. CORNER/INTERSECTION BAR DETAILS SCALE: N.T.S.

Table with columns for ISSUED, OWNER REVIEW, CONTRACTOR BID DOCUMENTS, JOB NO. 23-429-1495, DRAWN KSG, CHECKED JMB, APPROVED JMB, SHEET TITLE GEOMETRIC SLAB PLAN & FOUNDATION SECTION AND DETAILS, SHEET NUMBER S311.

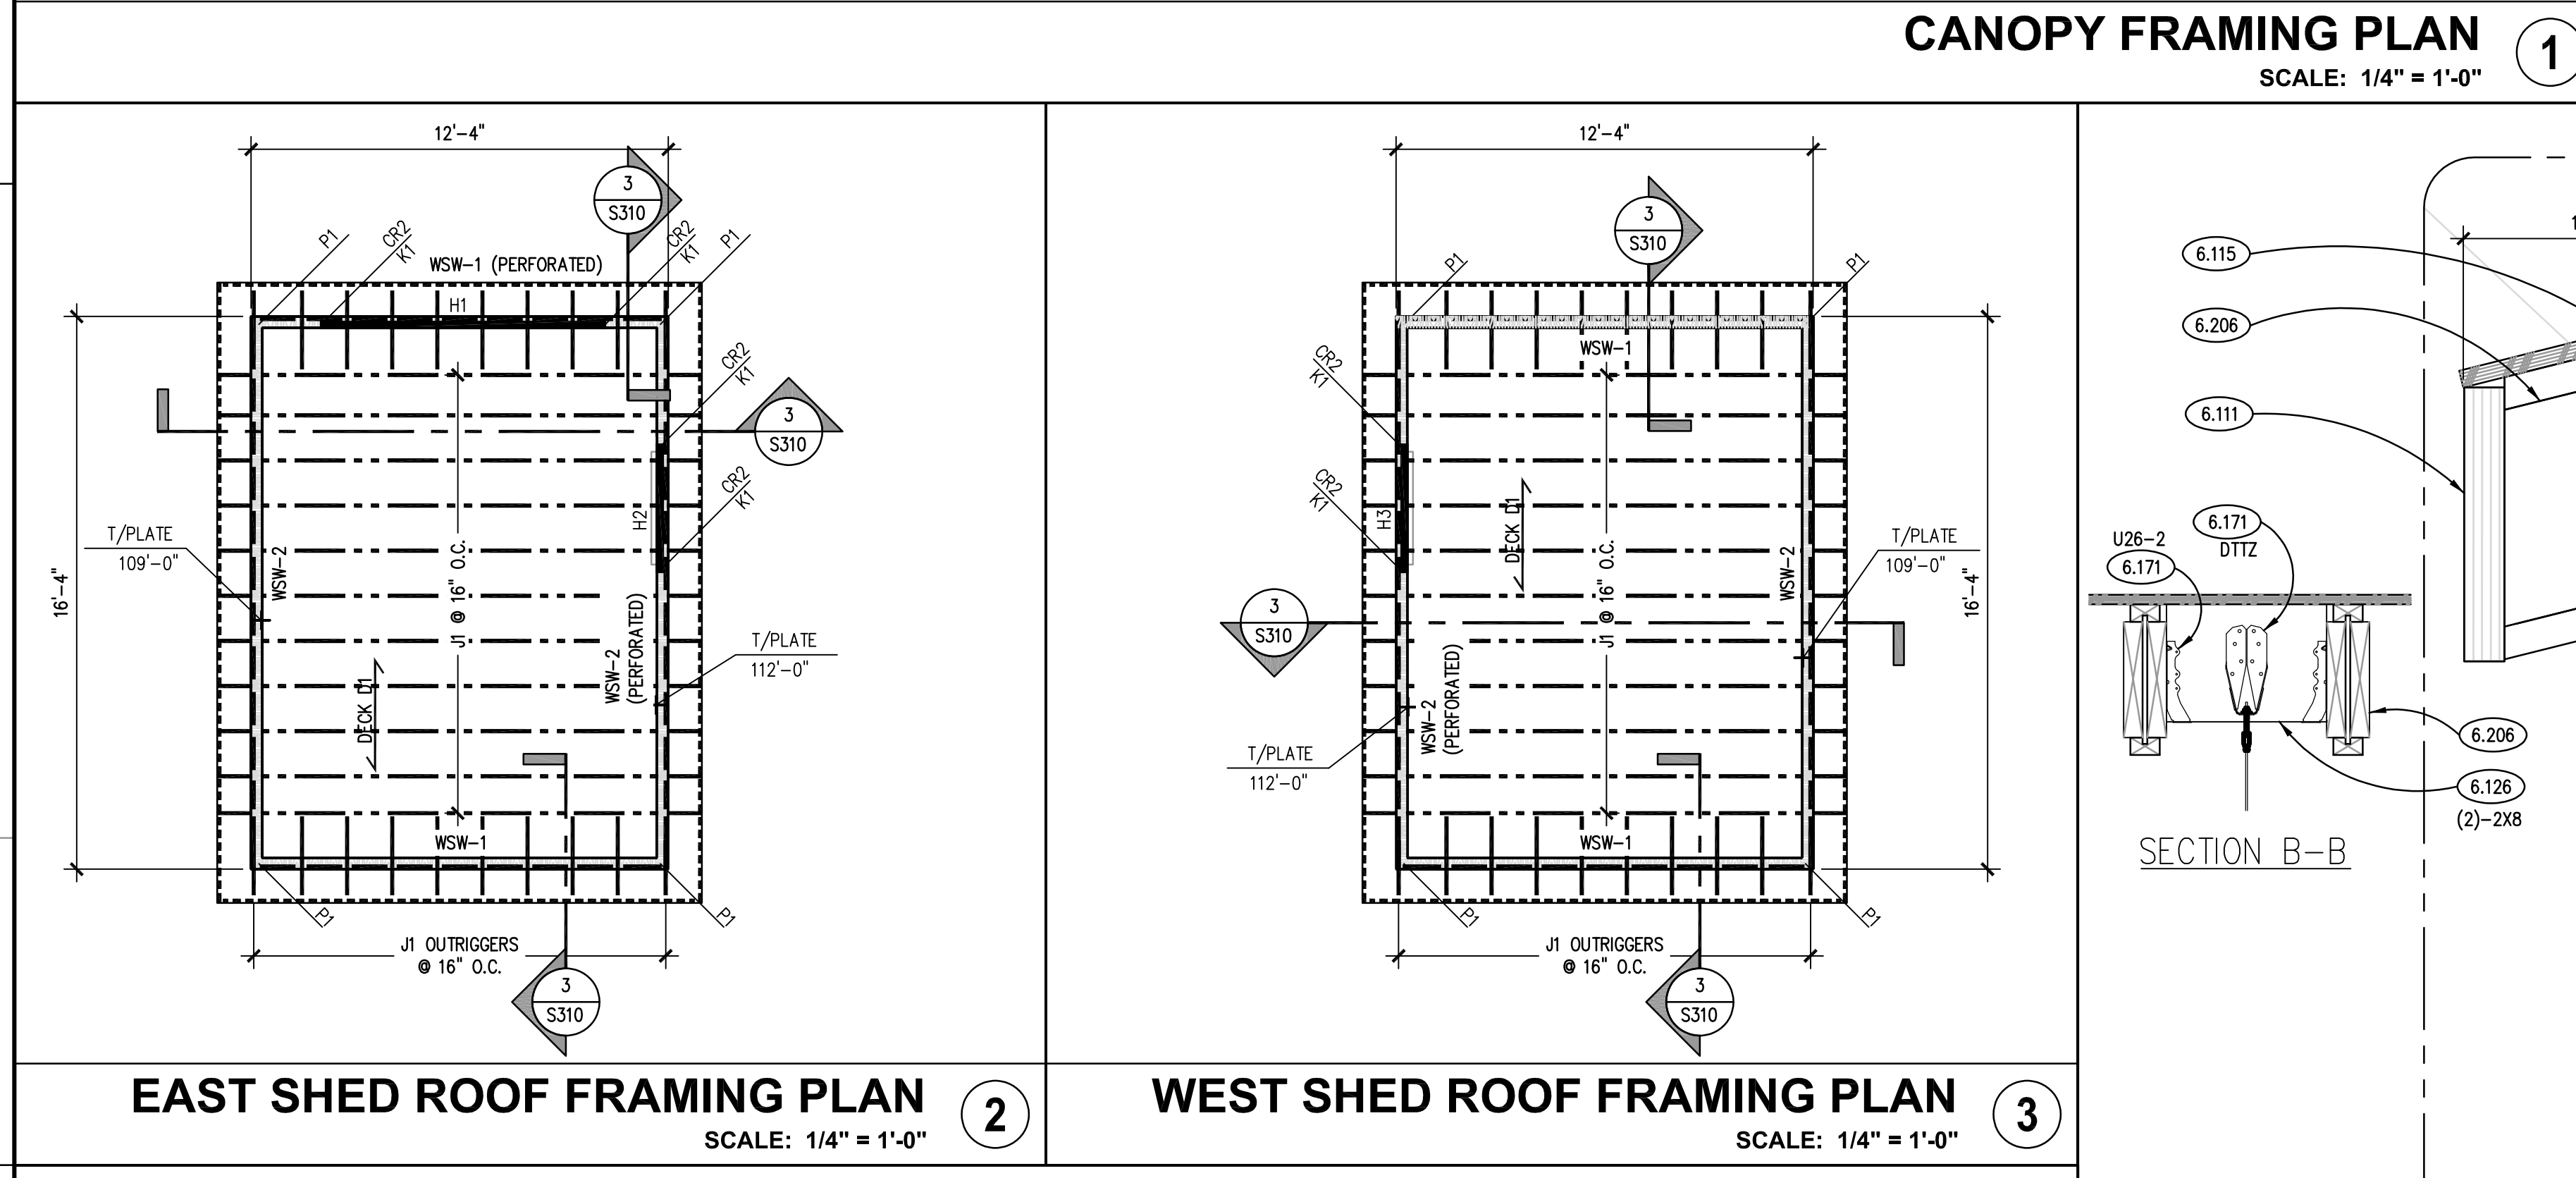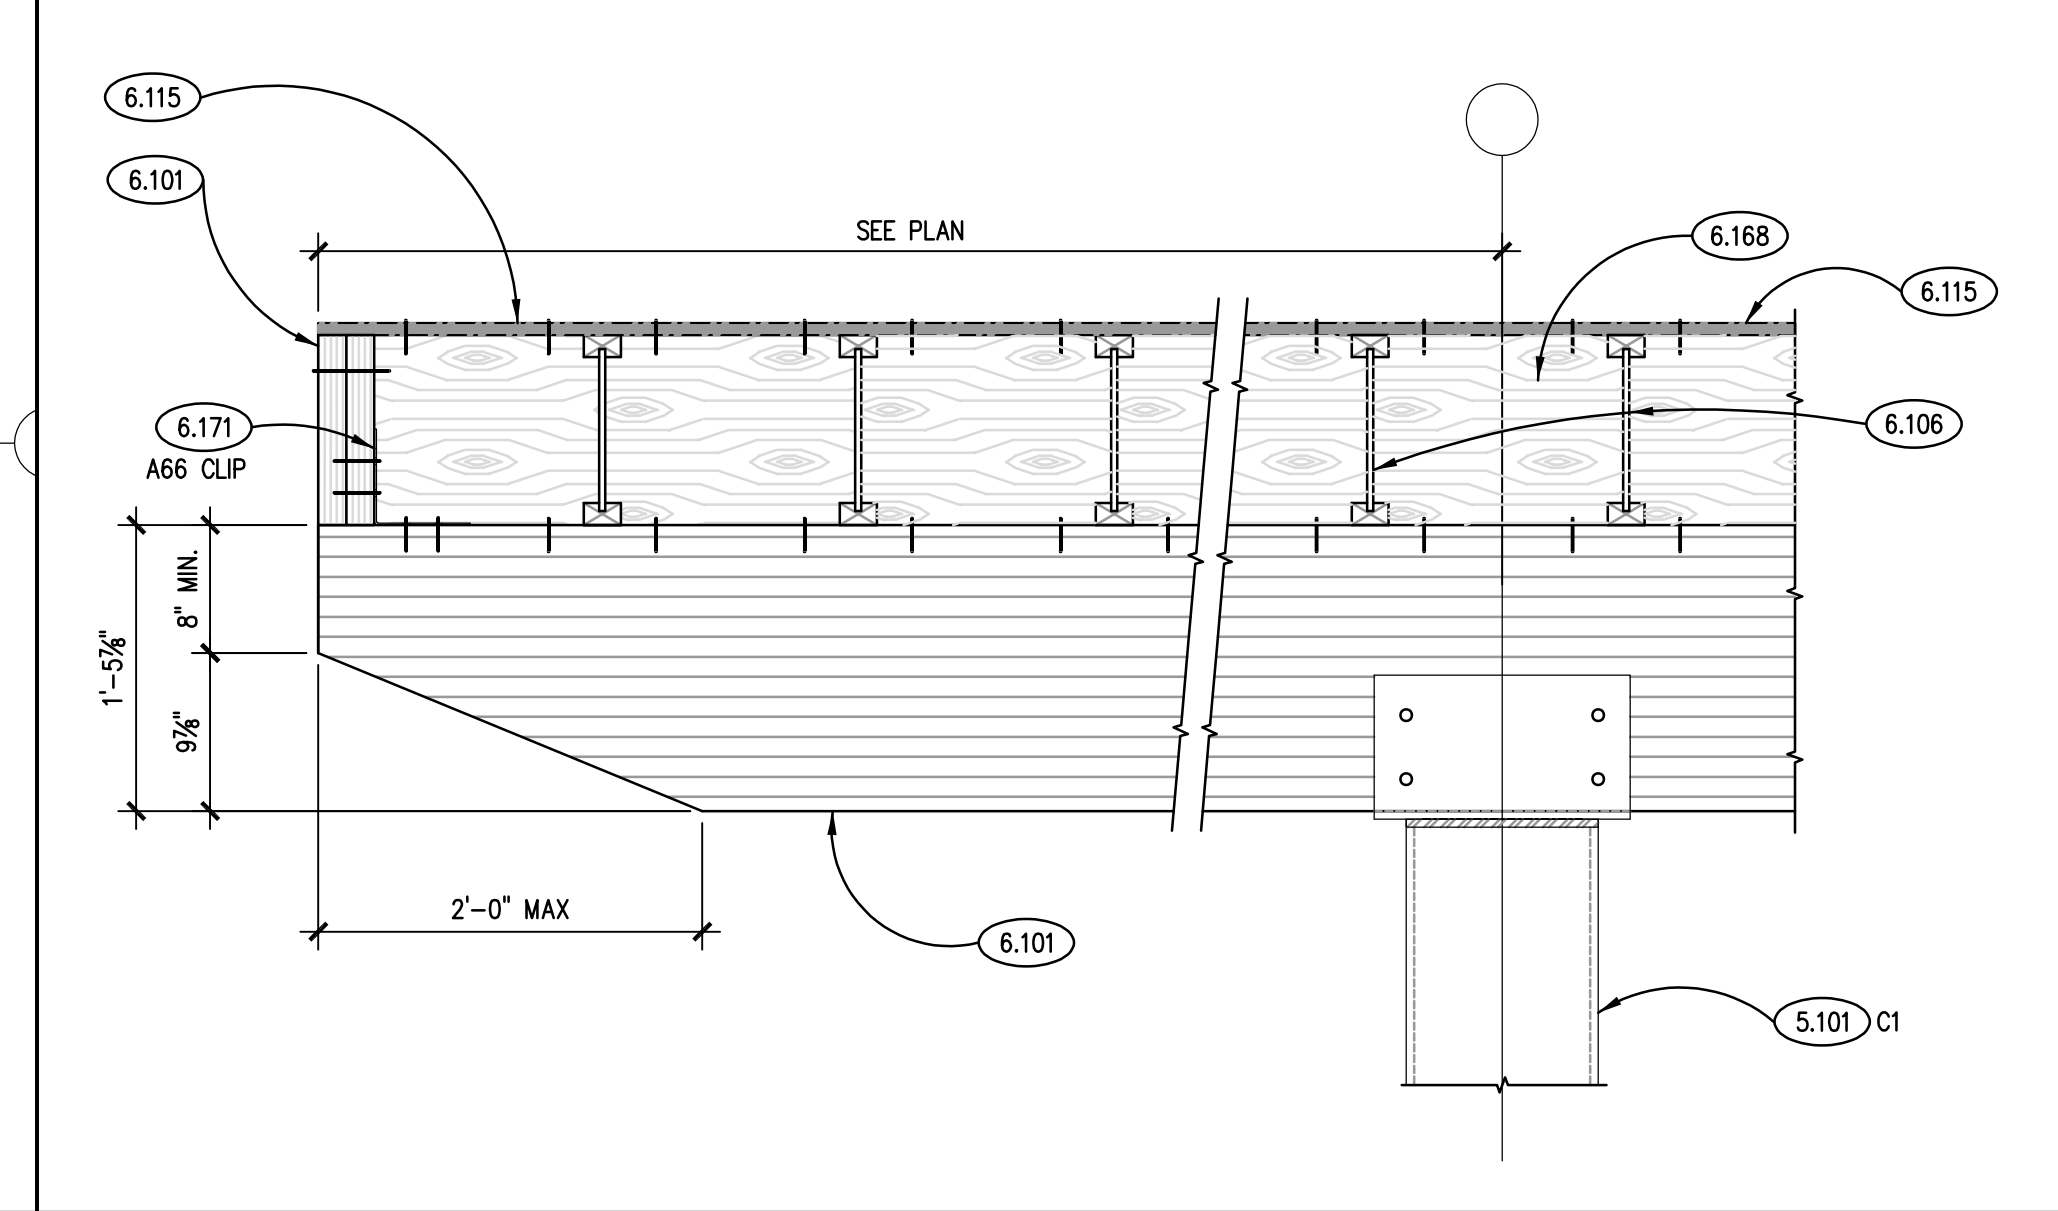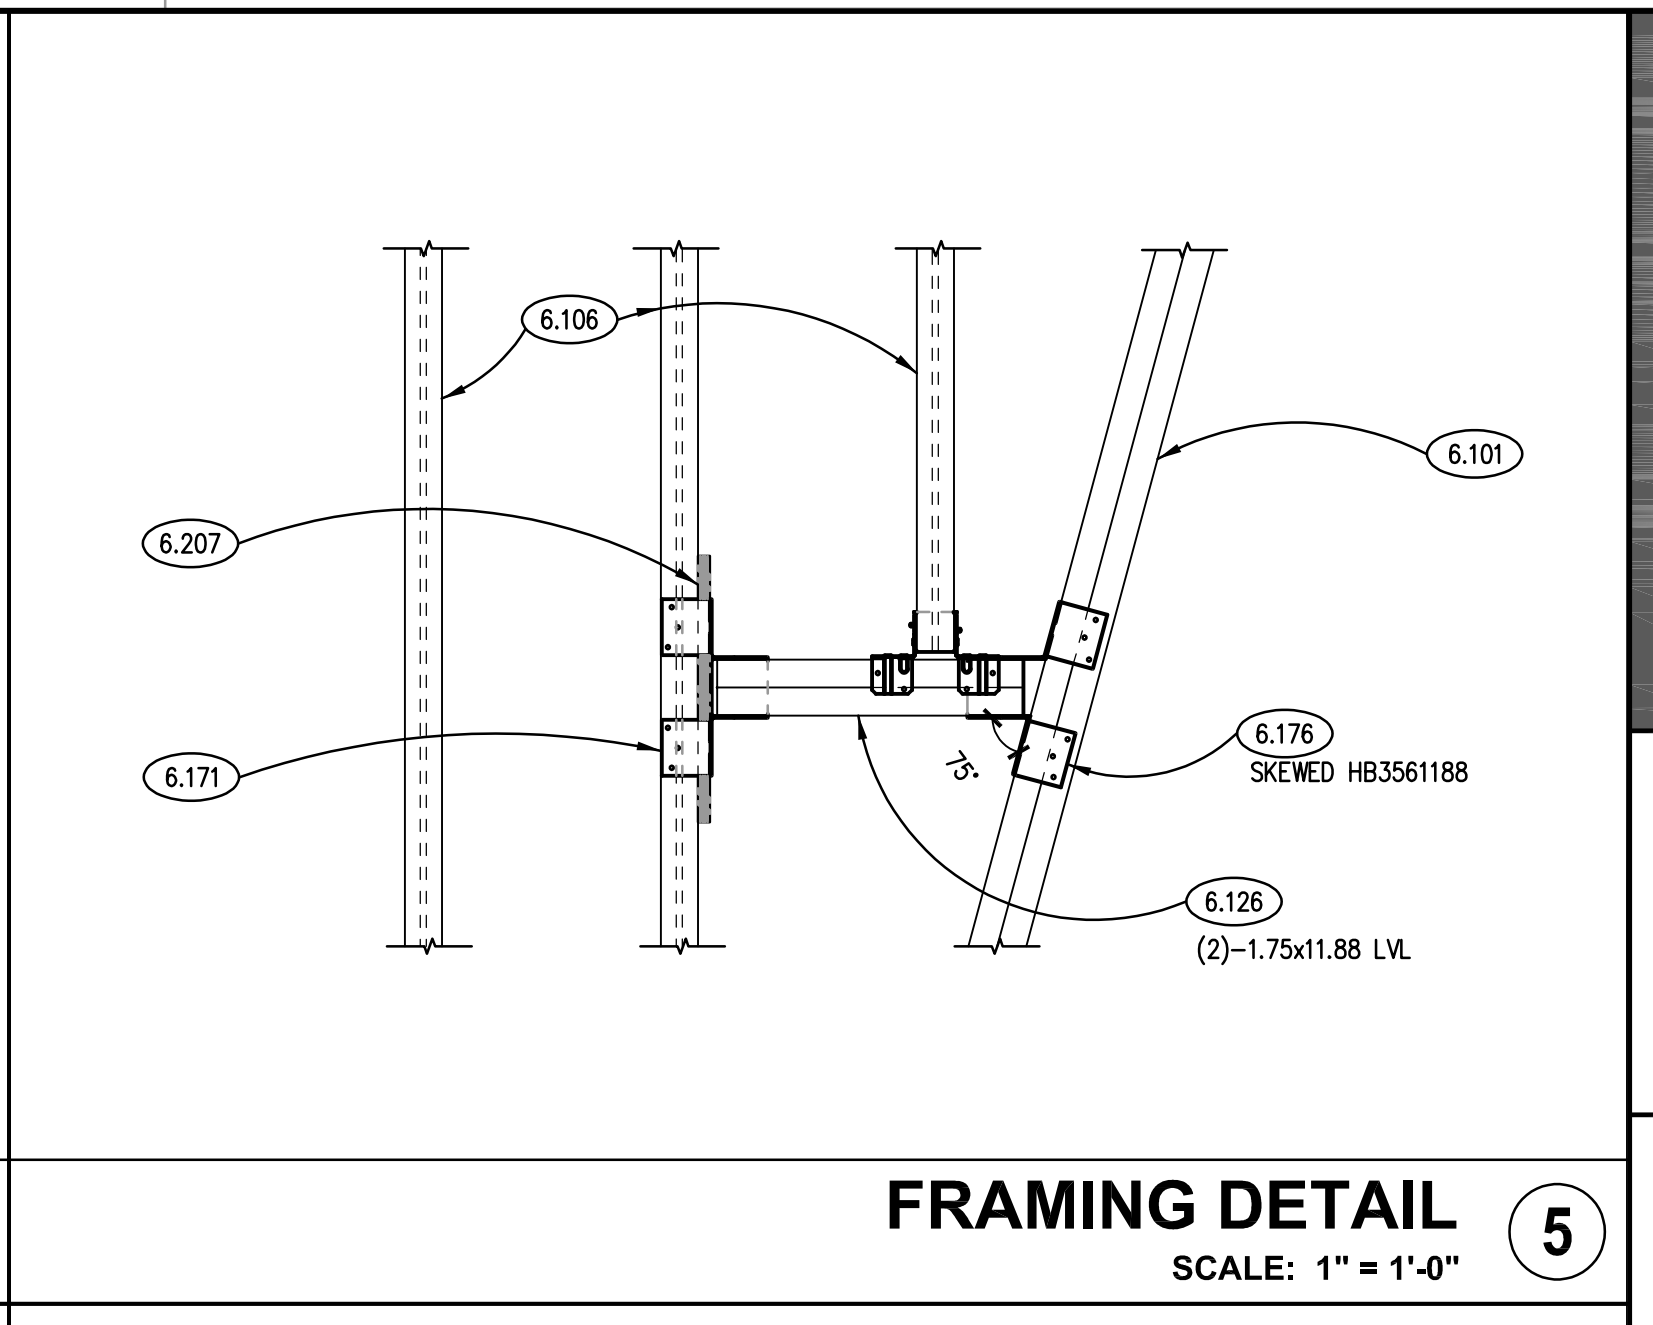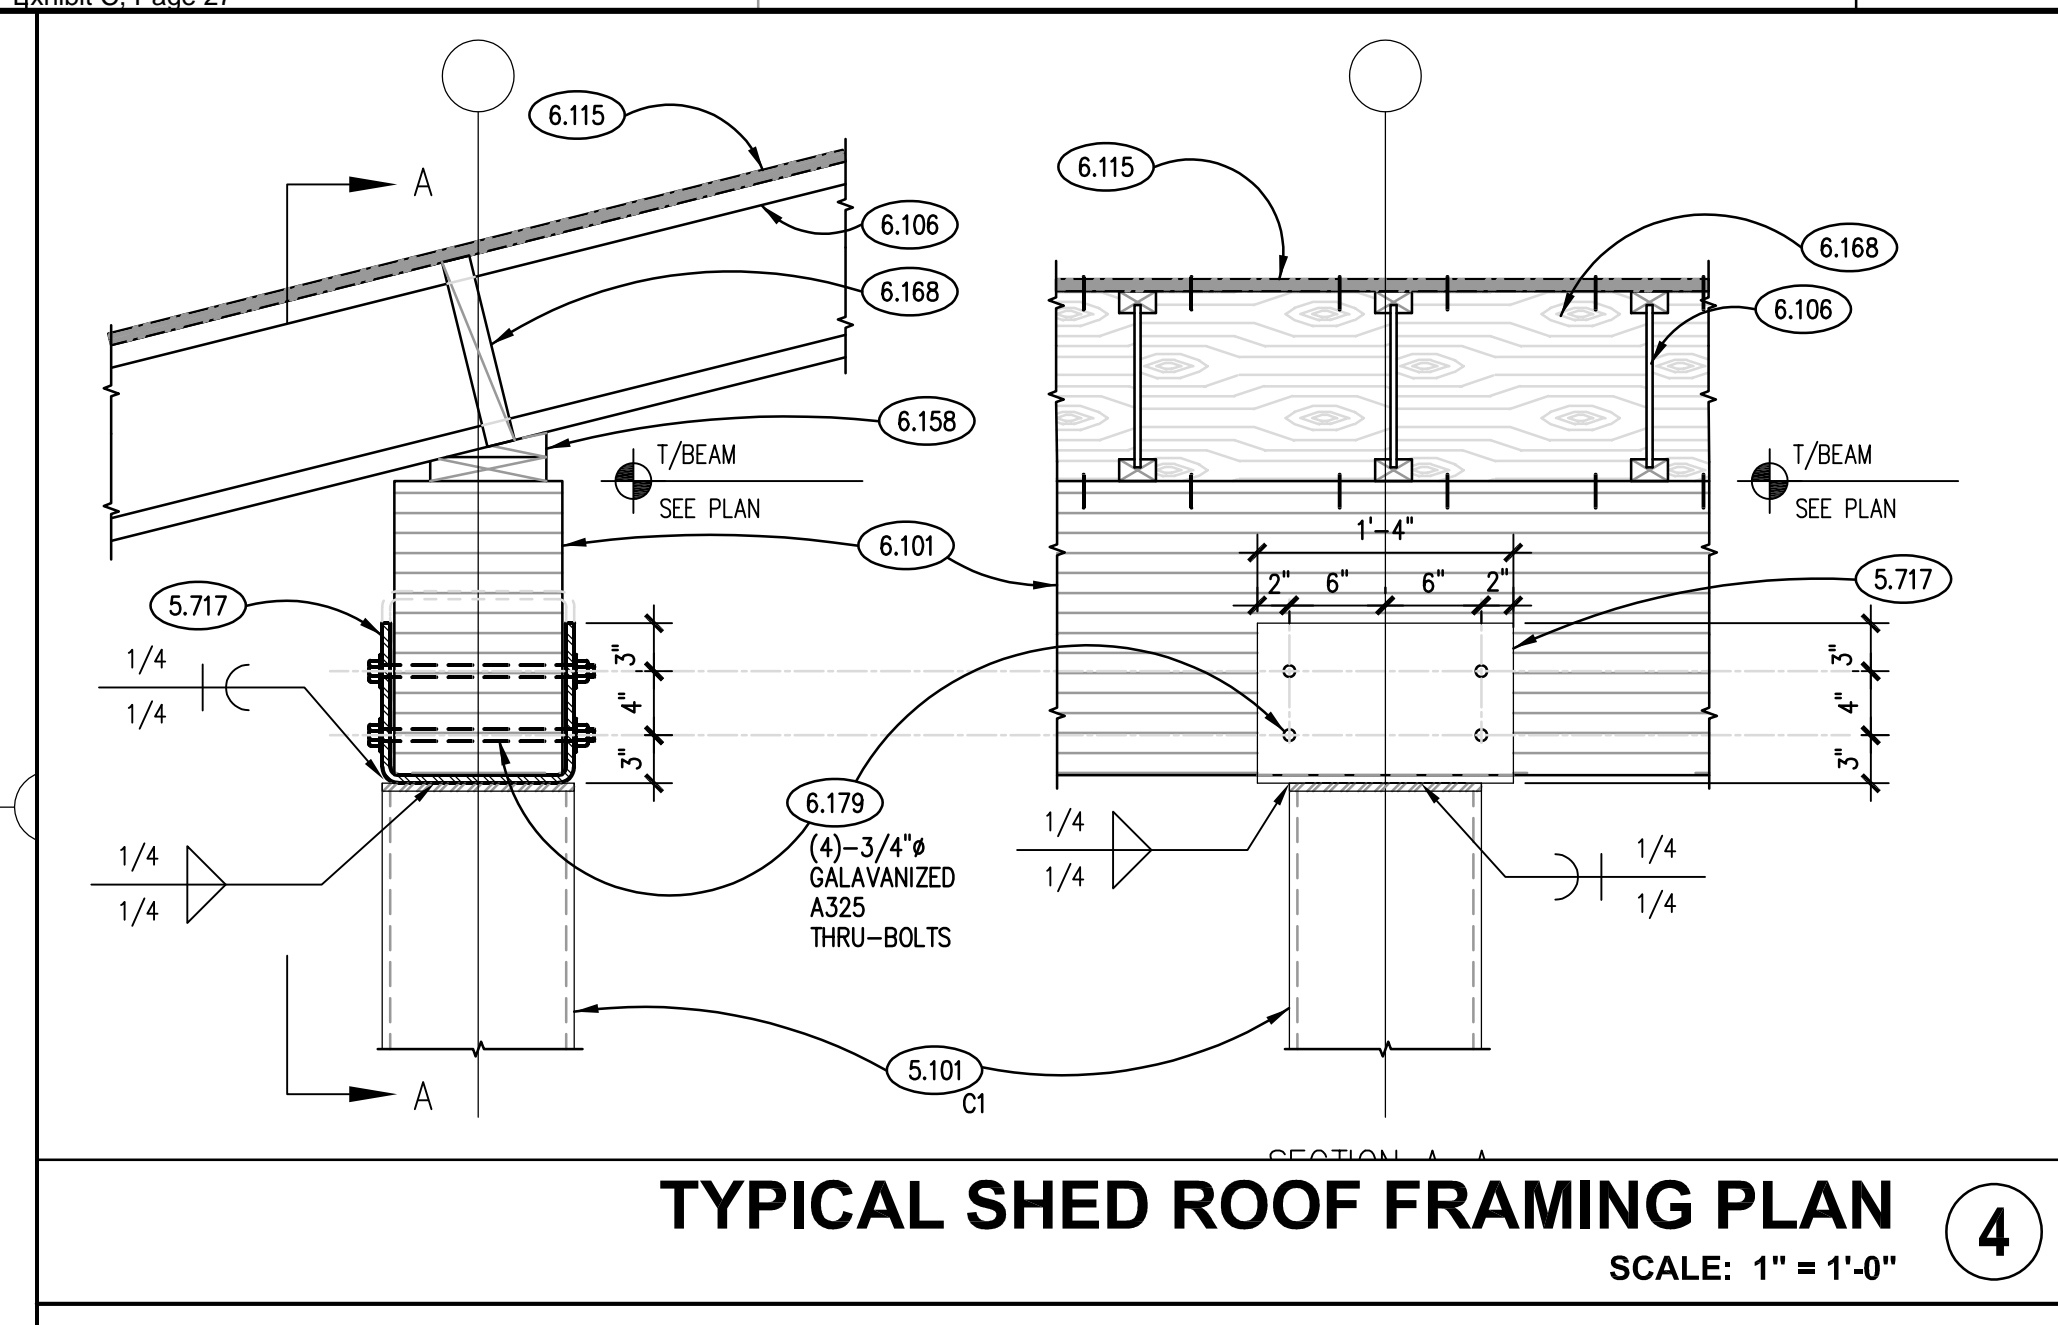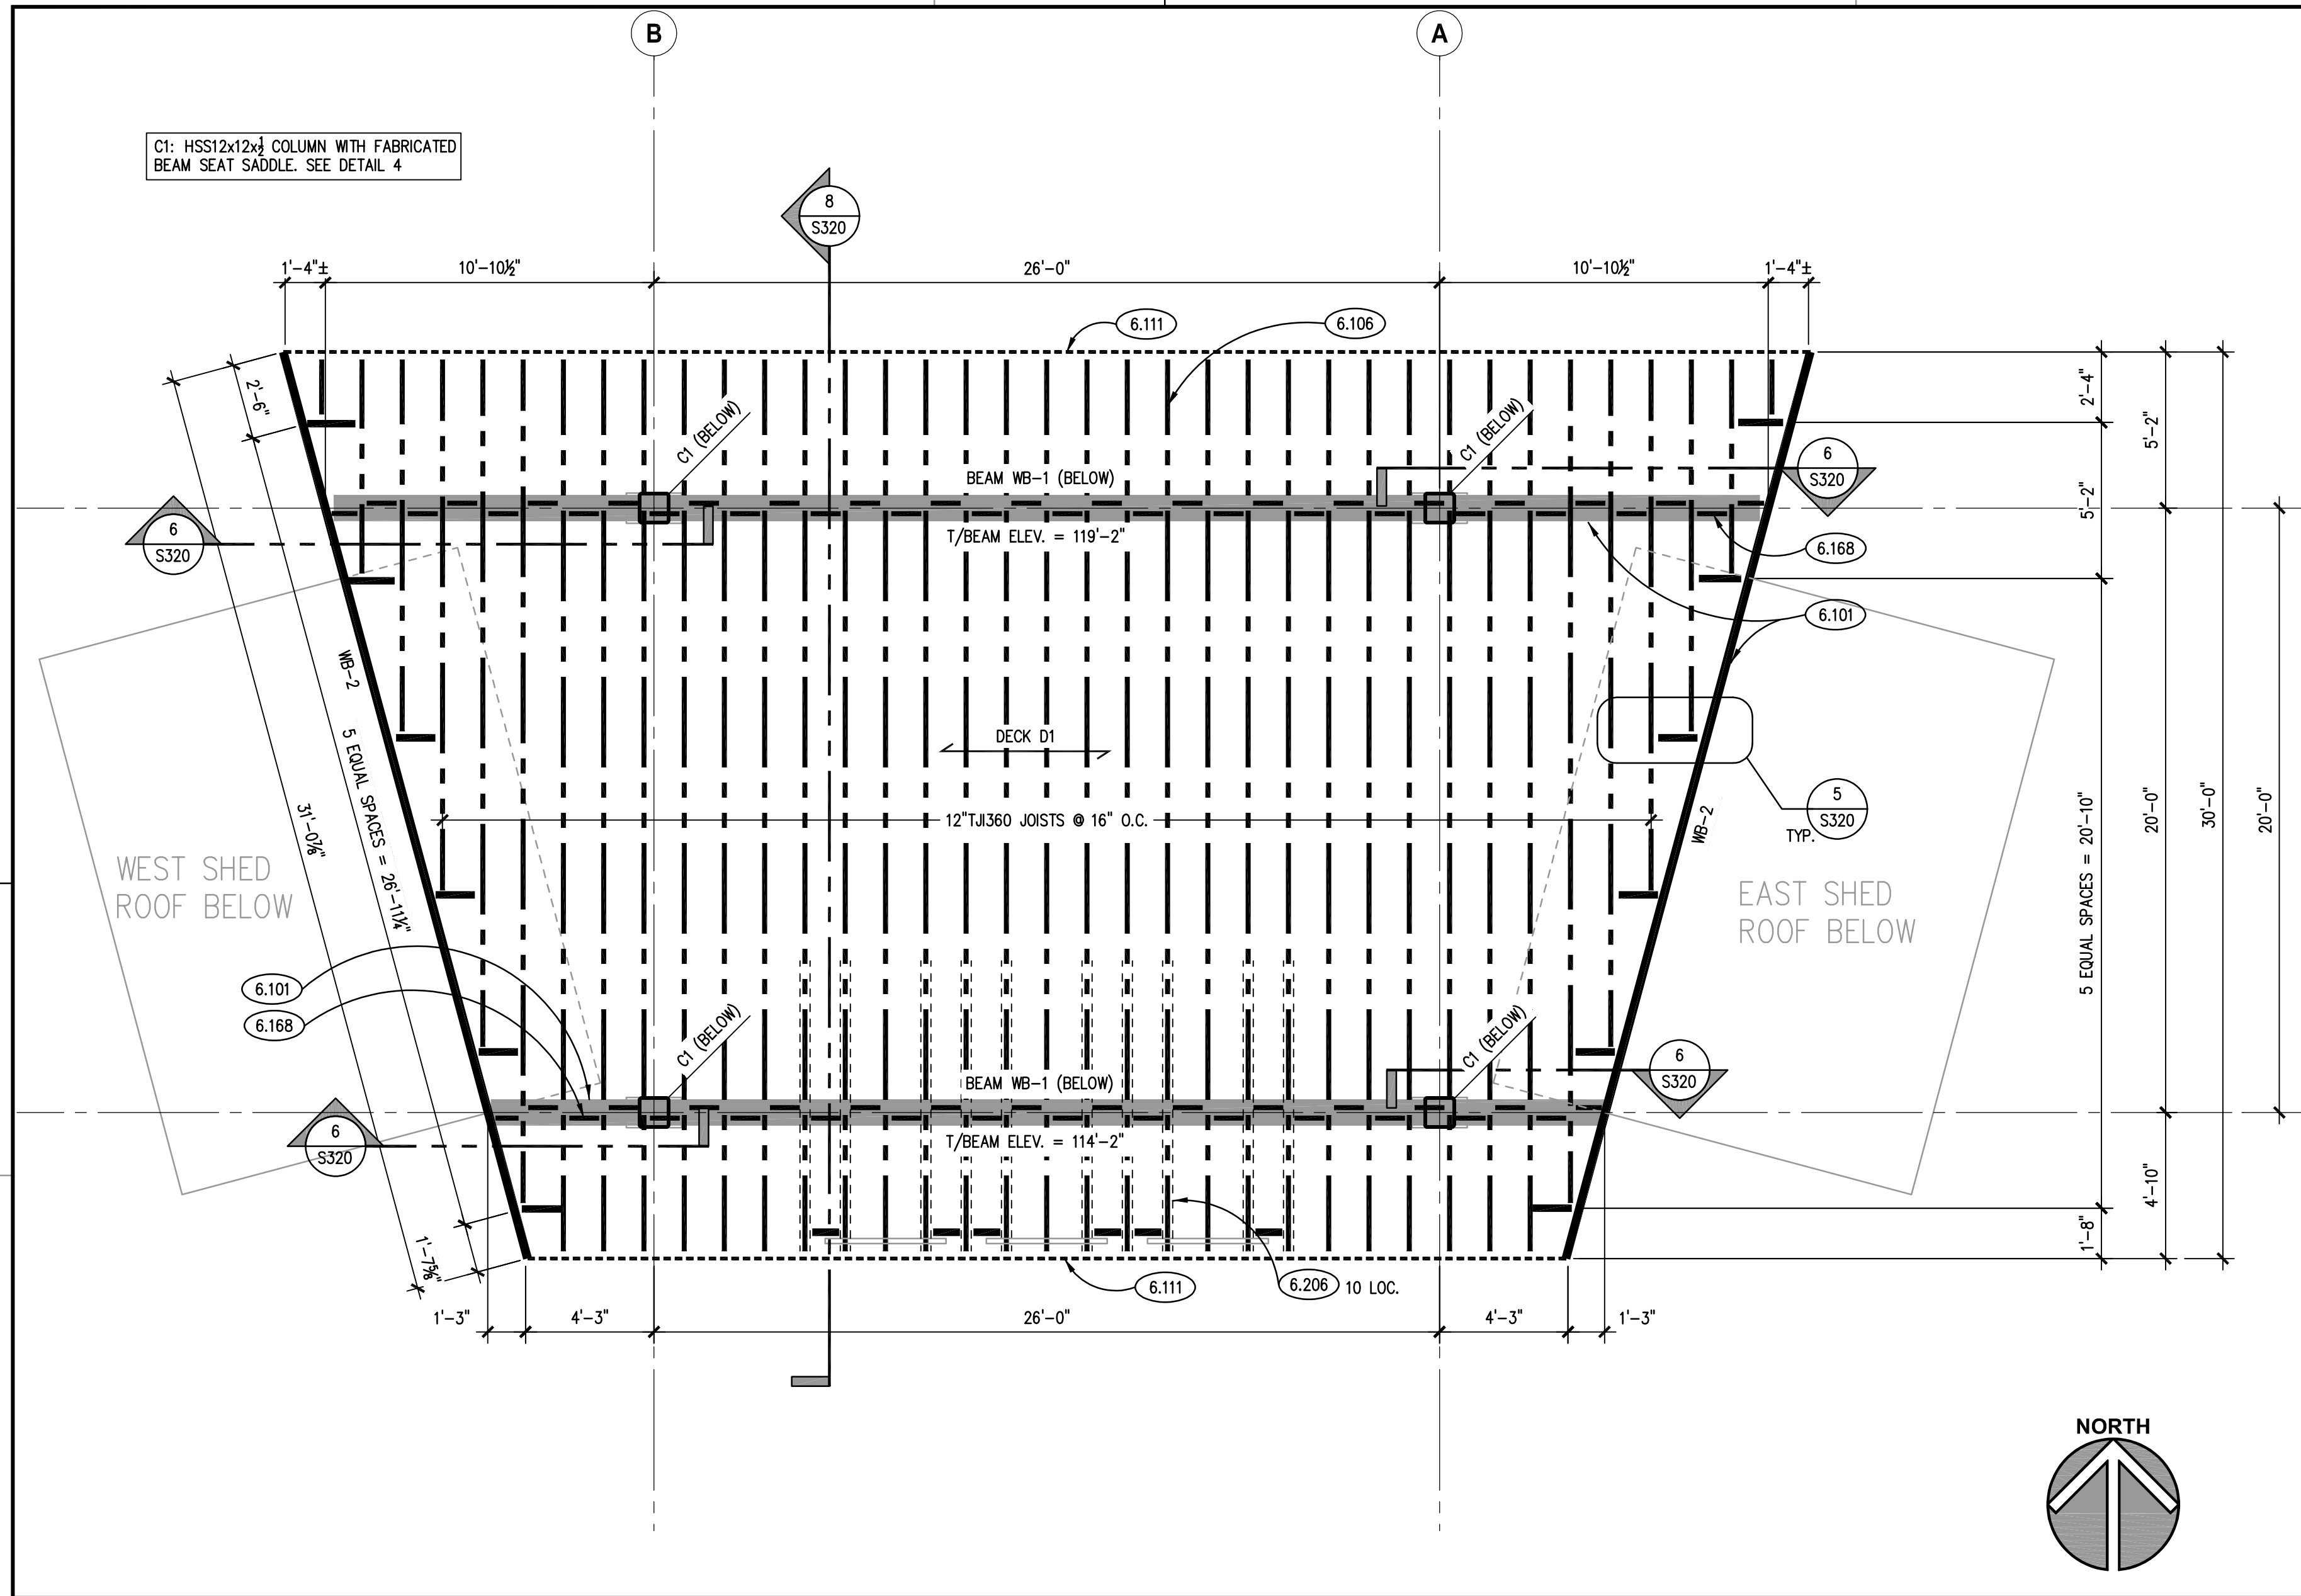

- KEYNOTES**
- KEYNOTES ARE TYPICALLY NOT DUPLICATED WITHIN A GIVEN DETAIL. AN UN-KEYNOTED ITEM IN A DETAIL IS THE SAME AS A KEYNOTED ITEM HAVING THE SAME APPEARANCE WITHIN THE SAME DETAIL.
- 3.113 CONCRETE FORMING AND ACCESSORIES: CONTINUOUS RADIUS EDGE. PROVIDE 3/4" RADIUS U.N.O.
  - 3.304 CAST-IN-PLACE CONCRETE: EXTERIOR SLAB-ON-GRADE. REFER TO SPECIFICATIONS FOR MIX TYPE AND FINISH. REFER TO PLAN & SCHEDULE FOR REINFORCING. REFER TO PLAN AND ARCHITECTURAL DRAWINGS FOR ELEVATIONS AND SLOPES.
  - 3.319 CAST-IN-PLACE CONCRETE: 8" x 4'-0" LONG SONOTUBE ANCHORAGE FOUNDATION; PROVIDE (4)-#4 VERTICAL BARS & (2)-#3 CLOSED LOOP STIRRUPS AT TOP 4" OF PIER; COORDINATE WITH ARCHITECTURAL FABRICATION DETAILS FOR REQUIRED MATERIALS TO BE CAST INTO TOP OF PIERS.
  - 3.321 CAST-IN-PLACE CONCRETE: SPREAD FOOTING. REFER TO PLAN, SCHEDULE AND SPECIFICATIONS FOR THICKNESS, SIZE, REINFORCING AND MIX TYPE.
  - 5.101 STRUCTURAL STEEL: STEEL COLUMN. REFER TO PLAN AND SCHEDULE.
  - 5.122 STRUCTURAL STEEL: BASEPLATE & SETTING PLATE. REFER TO COLUMN SCHEDULE.
  - 5.715 METAL FABRICATION: DECORATIVE ART PANELS. SEE ARCHITECTURAL DRAWINGS FOR MORE INFORMATION FOR DISPLAY AND SUSPENSION SYSTEM.
  - 5.717 METAL FABRICATION: 16" LONG STEEL BEAM SADDLE FABRICATED FROM COLUMN SECTION; PROVIDE THRU-BOLT HOLES AS SHOWN AND FABRICATED TO TOP OF COLUMN VIA SHOP WELDING AS SHOWN. ALL STEEL TO BE GALVANIZED.
  - 6.101 WOOD FRAMING: BEAM/HEADER. SEE PLAN, SCHEDULE AND DETAILS FOR SIZE AND SPECIES. FIR OUT SIDES TO MATCH WALL THICKNESS WHERE APPLICABLE.
  - 6.106 WOOD FRAMING: ROOF JOIST. SEE PLAN, SCHEDULE AND DETAILS FOR SIZE, SPECIES AND SPACING.
  - 6.111 WOOD FRAMING: CONTINUOUS PERFORMER LSL. PRESSURE TREATED RIM BOARD (2 SIDES) TO MATCH DEPTH OF JOISTS/BEAMS. ATTACH TO EACH JOIST/BEAM USING (5)-16d NAILS. CANTILEVER ENDS BEYOND LAST JOIST/BEAM AS REQUIRED TO SUPPORT SIDE RIM BOARDS. INSIDE CORNERS OF FRONT LSL AND SIDE LSL TO HAVE (2) A35 FRAMING ANGLES AS MANUFACTURED BY SIMPSON OR EQUAL. BEAR SIDE LSL. RIM BOARD ON WALL FRAMING. CONTRACTOR OPTION: IN LIEU OF LSL, PROVIDE (2)-2x8 PRESSURE TREATED ELEMENTS WITH (3)-16d NAILS EACH 2x8 AT EACH JOIST/BEAM.
  - 6.115 WOOD FRAMING: APA RATED SHEATHING. SEE PLAN, SCHEDULE AND DETAILS FOR TYPE, THICKNESS AND ATTACHMENT REQUIREMENTS.
  - 6.126 WOOD FRAMING: HEADER BEAM AS NOTED WITH JOIST HANGER EACH END.
  - 6.158 WOOD FRAMING: CONTINUOUS BEVELED TOP PLATE TO MATCH SLOPE OF ROOF.
  - 6.168 WOOD FRAMING: PROVIDE SOLID 2x BLOKING BETWEEN JOISTS; ATTACH USING (2)-16d NAILS @ EACH END.
  - 6.171 WOOD FRAMING ACCESSORY: LIGHT GAUGE WOOD CONSTRUCTION CONNECTOR AS NOTED MANUFACTURED BY SIMPSON STRONG-TIE OR EQUAL. INSTALL PER MANUFACTURER'S RECOMMENDATIONS. PROVIDE NAIL TYPE AND QUANTITIES RESULTING IN THE MAXIMUM TABULATED CAPACITIES.
  - 6.176 WOOD FRAMING ACCESSORY: SPECIALIZED SERIES LIGHT GAUGE WOOD CONSTRUCTION CONNECTOR AS NOTED MANUFACTURED BY SIMPSON OR EQUAL FOR THE LOADING AND MEMBER SIZES INDICATED. INSTALL PER MANUFACTURER'S RECOMMENDATIONS. REACTION FOR CONNECTOR DESIGN AS INDICATED ON THE DRAWINGS. CONNECTION MANUFACTURER TO SUBMIT CALCULATIONS AND DETAILS TO STRUCTURAL ENGINEER FOR REVIEW.
  - 6.179 WOOD FRAMING ACCESSORY: FASTENER AS NOTED.
  - 6.206 WOOD FRAMING: JOIST REINFORCEMENT; 12"x230 JOIST REINFORCED WITH ADDITIONAL (2)-2x10'S (NS/F'S); MILL AS REQUIRED TO FIT BETWEEN JOIST CHORDS AND FASTEN TOGETHER WITH 16d NAILS @ 12" O.C. T&B.
  - 6.207 WOOD FRAMING: JOIST REINFORCEMENT; PROVIDE BLOKING/SHEATHING REINFORCEMENT IN ACCORDANCE WITH JOIST MANUFACTURER'S RECOMMENDATIONS FOR INSTALLATION OF LIGHT GAUGE HANGER.

